

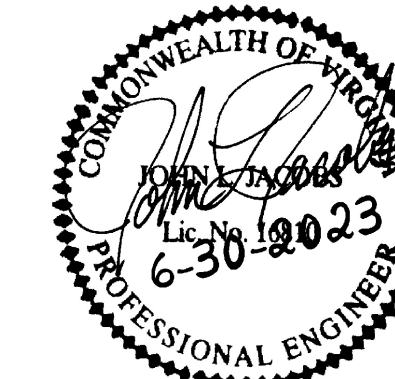
ADDITIONS AND RENOVATIONS TO EXISTING Washington County VA Facility Sheriff's Office - Animal Shelter

15050 Lee Highway - Bristol, Virginia 24201

BID DOCUMENTS / CONSTRUCTION DOCUMENTS




ARCHITECTURE



STRUCTURAL



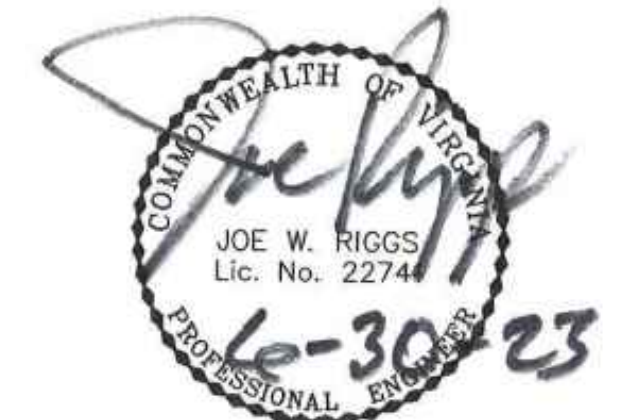MECHANICAL



ELECTRICAL



the LANE GROUP
 engineering architecture environmental
 310 Valley Street N.W. Abingdon, VA 24210
 276.206.8571 - office
 Abingdon | Big Stone Gap | Galax
 www.thelanegroupinc.com

GENERAL PROJECT INFORMATION

PROJECT DATA

PROJECT
 ADDITIONS AND RENOVATIONS TO EXISTING
 WASHINGTON COUNTY VA FACILITY
 SHERIFF'S OFFICE - ANIMAL SHELTER
 15050 LEE HIGHWAY
 BRISTOL, VIRGINIA 24201

OWNER / DEVELOPER
 WASHINGTON COUNTY, VIRGINIA

OWNER CONTACT PERSON: BRYAN McALLISTER
 TELEPHONE NO.: 276-525-1353

OWNER CONTACT PERSON: KEVIN HILL, GENERAL SERVICES MANAGER
 TELEPHONE NO.: 276-525-1355

DESIGNERS OF RECORD



DISCIPLINE	NAME	LICENSE NO.	TELEPHONE NO.
ARCHITECT	D. MICHAEL WEAVER, AIA	VA. 009031	276-206-8571
LANDSCAPE	N.A.		
CIVIL ENGR.	MATTHEW LANE, P.E.	VA. 034173	276-206-8571
STRUCTURAL	JOHN L. JACOBS, P.E.	VA. 016810	423-787-7828
PLUMBING	DERWIN CARTMEL, P.E.	VA. 031491	423-426-5491
HVAC	DERWIN CARTMEL, P.E.	VA. 031491	423-426-5491
SPRINKLER	N.A.		
ELECTRICAL	JOE W. RIGGS, P.E.	VA. 022741	423-426-5491
FIRE ALARM	N.A.		

DRAWING INDEX

T100	TITLE SHEET, DRAWING INDEX, AND LOCATION INFORMATION
G101	PROJECT INFORMATION
SITE / CIVIL	
C101	PROPERTY SURVEY
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A010	PARTITION TYPES / PARTITION DETAILS
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DRAWING INDEX

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MPE102	MECHANICAL, PLUMBING, & ELECTRICAL SPECIFICATIONS
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PLUMBING	
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PI02	SANITARY SEWER, WASTE, & VENT PIPING FLOOR PLAN
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PROJECT

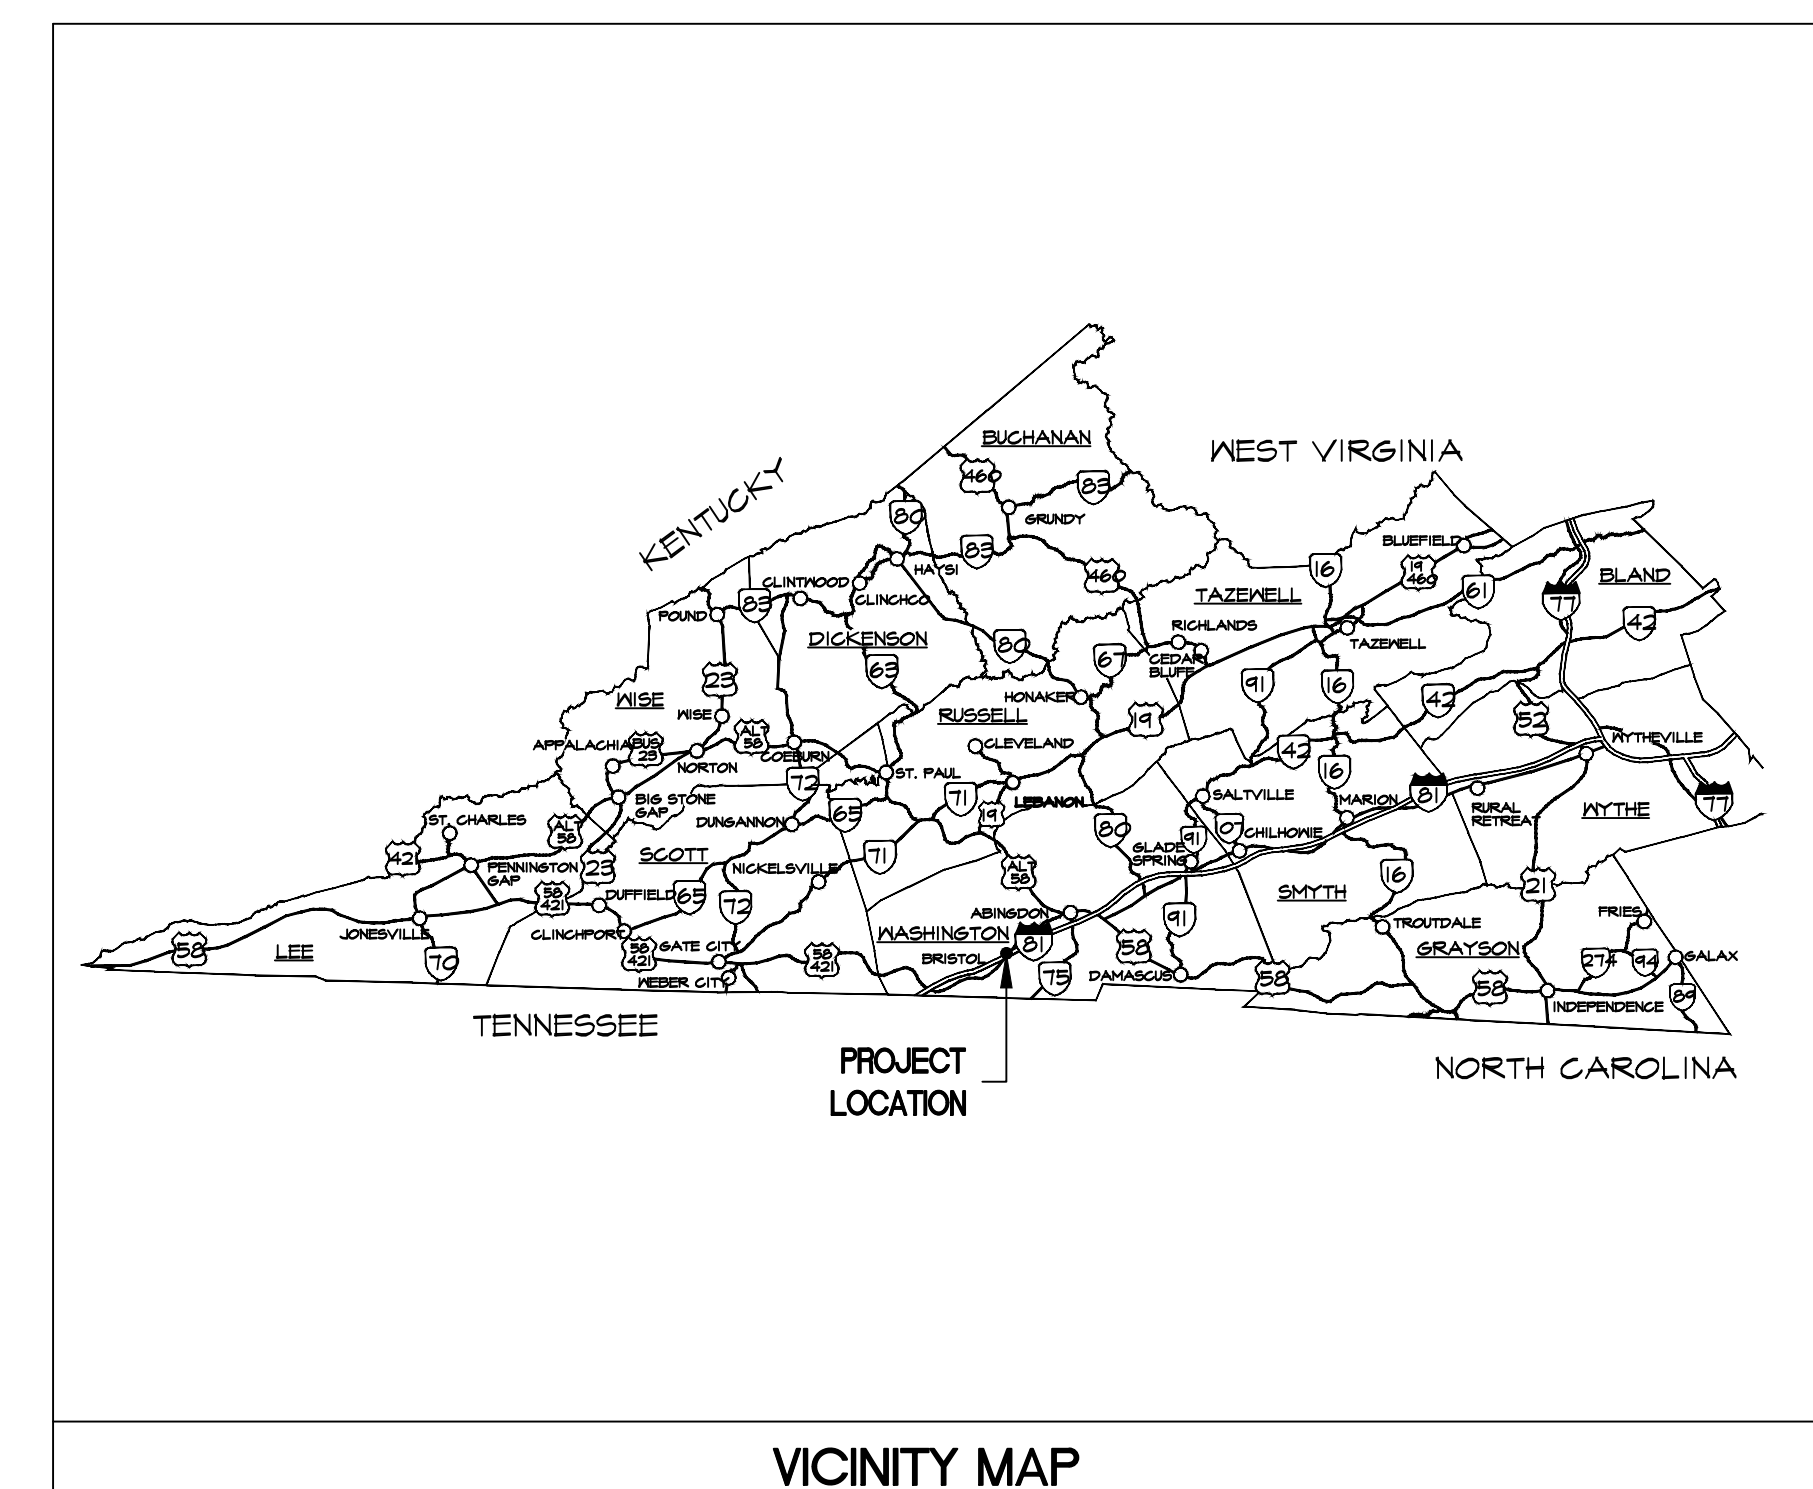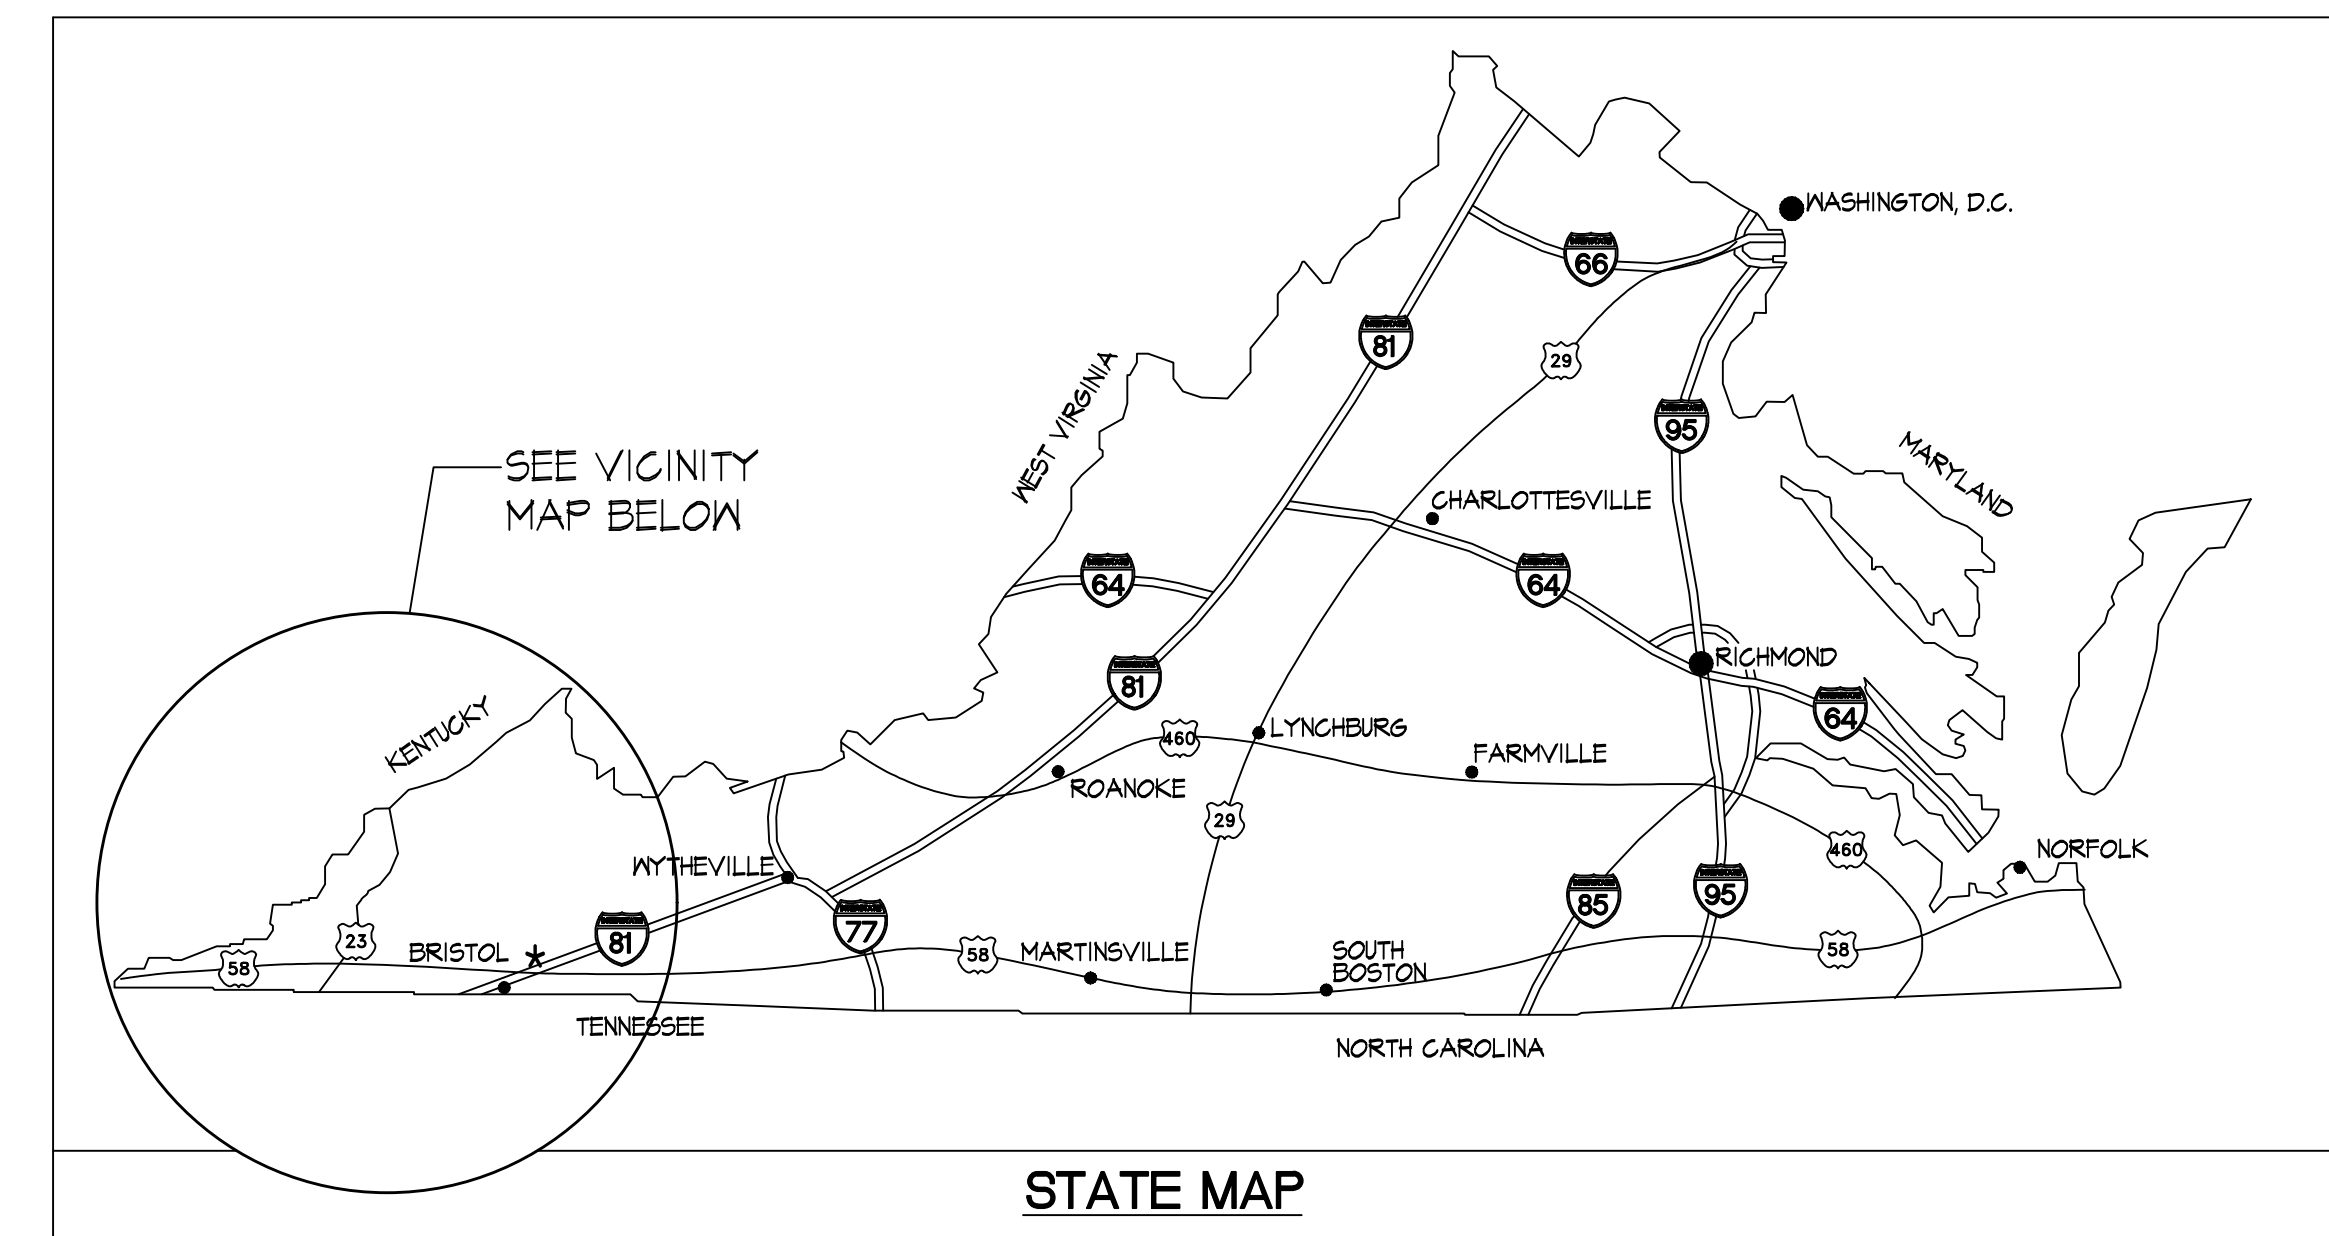ADDITIONS AND RENOVATIONS TO EXISTING
 WASHINGTON COUNTY VA
 SHERIFF'S OFFICE -
 ANIMAL SHELTER
 15050 LEE HIGHWAY
 BRISTOL, VA 24201
 TLG PROJECT NO. 22136

TITLE SHEET
 DRAWING INDEX
 LOCATION INFORMATION

T-100
 Date 06-30-2023

ABBREVIATIONS

#	AND	KIT	Kitchen
AB	At the Rate of (refers to spacing)	KW	Kilowatts
ABV	Anchor Bolt	L	Length, Lintel
ADJ	Above	LAM	Laminated
AFF	Adjustable	LAV	Lavatory
AHU	Above Finish Floor	LBS	Pounds
ALT	Air Handling Unit	LF	Linear Feet
ALUM	Alternative, Alternate	LKR	Locker
APPROX.	Aluminum	LT	Light
ARCH	Approximately	MAS	Masonry
ASPH	Architect, Architectural	MATL	Material
	Asphalt	MAX	Maximum
BD	Board	MECH	Mechanical
BLDG	Building	MFG	Manufacturer
BLKG	BLocking	MIN	Minimum
BLN	Below	MIR	Mirror
BM	Beam	MISC	Miscellaneous
BRK	Brick	MO	Masonry Opening
BTU	British Thermal Unit	MRSNB	Moisture Resistant Gypsum Wallboard
BUR	Built-up Roofing	MTD	Mounted
		MTL	Metal
CFM	Cubic Feet Per Minute (Air Flow)	MTR	Motor
CG	Corner Guard	MUL	Mullion
C.I.P.	Cast-In-Place	N	North
CJ	Central Joint	N/A	Not Applicable
CL	Center Line	NIC	Not in Contract
CL6	Ceiling	NO, #	Number
CLOS.	Closet	NOM.	Nominal
CLR	Clear	NR	Non-Rated
CMU	Concrete Masonry Unit	NRCA	National Roofing Contractors Association
CD	Cleancut	NTS	Not to Scale
C.H.	Cold Hook	OC	On Center
COL	Column	O.H.	Overhead, Opposite Hand
CONC	Concrete	O.H.E.	Overhead Electric
CONT	Continuous	OPNG	Opening
CONTR	Contractor	OSB	Oriented Strand Board
CORR	Corridor	P	Paint
CPT	Carpet	PC	Precast
C.S.	Concrete Sealer, Concrete Stain	PH	Phase
C.T.	Ceramic Tile	PL	Plate
CTB	Ceramic Tile Base	PLAM	Plastic Laminated
CTR	Center	PLAS	Plaster
CM	Cold Water	PP	Power Pole
		PNL	Panel
DEMO	Demolish, Demolition	POLYISO.	Polyisocyanurate
DET	Detail	PROJ	Projection, Project
DF	Drinking Fountain	PRT	Pre-cast Resilient Terrazzo Tile
DIA	Diameter	PSI	Pounds Per Square Inch
DIF	Determine in Field	PT	Porcelain Tile
DIFF	Diffuser	PTD	Painted or Paper Towel Dispenser
DIM	Dimension	PWD	Plywood
DISCH	Discharge	QT	Quarry Tile
DN	Down	R	Radius
DO	Ditto	RA	Return Air
DR	Door	RB	Rubber Base, Resilient Base
DRN	Drain	RC	Resilient Channel
DS	Downspout	RD	Roof Drain
DN	Dishwater	REF	Reference
DWS	Drawing	REFRIG	Refrigerator
DWR	Draener	REINF	Reinforced, Reinforcement
		REQD	Required
E	East	RET	Return
EA	Each	REV	Revise / Revised
EAL	Exhaust Fan on Each Face	RM	Room
EJH	Electric Unit Heater	R.O.M.	Right of Way
EJ	Expansion Joint	R.O.M.	Rough Opening
ELEV	Elevation	RPM	Revolution Per Minutes
ELEC	Electric, Electrical	RTU	Roof Top Unit
ELEV	Elevation	S	South
EMER	Emergency	SATC	Suspended Acoustical Tile Ceiling
ENGR	Engineer	SCH	Schedule
EOS	Edge of Slab	SD	Smoke Damper or Soap Dispenser
EP	Epoxy Paint	SECT	Section
EQ	Equal	SF	Square Foot (feet)
EQUIP	Equipment	SHT	Sheet
EAK	Each Way	SHT MTL	Sheet Metal
EMC	Electric Water Cooler	SIM	Similar
EXH	Exhaust	SPEC5	Specifications
EXIST	Existing	SQ	Square
EXP	Exposed	SS, S/S	Stainless Steel
EXT	Exterior	STD	Standard
		STL	Steel
F	Fahrenheit	STOR	Storage
FCU	Fan Coil Unit	STRUCT	Structure or Structural
FD	Fire Damper or Floor Drain	SUSP	Suspended
FE	Fire Extinguisher	SV	Sheet Vinyl
FEQ	Fire Extinguisher Cabinet	T/	Top of
FFE	Finish Floor Elevation	T/CONC	Top of Concrete
FF&E	Finishes, Fixtures, & Equipment	T/STL	Top of Steel
FHC	Fire Hose Cabinet	T/W	Top of Wall
FIN	Finish	T&G	Tongue and Groove
FLUOR	Fluorescent	TBD	To Be Determined
FRP	Fiberglass Reinforced Panel	TEL	Telephone
FR&MB	Fire-Rated Gypsum Wallboard	TEMP	Temperature
FT	Feet	TH	Thermometer
FTG	Footing	THK	Thickness
FURR	Furring	THOLD	Threshold
		TLT	Toilet
GA	Gauge	TFD	Toilet Paper Dispenser
GAL	Gallon	TSTAT	Thermostat
GALV	Galvanized	TV	Television
G.B.	Grab Bar	TYP	Typical
G.C.	General Contractor	UC	Undercut
GFM	Galvanized Hollow Metal	UG	Underground
GPM	Gallons Per Minute	UH	Unit Heater
GRV	Gravity Roof Ventilator	UL	Underwriters Laboratory
GWB	Gypsum Wallboard	UR	Urinal
		V	Volts
HC	Handicapped	VA	Virginia
HDNR	Hardware	VAV	Variable Air Volume
HDND	Hardwood	VCT	Vinyl Composition Tile
HM	Hollow Metal	VERT	Vertical
HORIZ.	Horizontal	VEST	Vestibule
HP	Horse Power / Heat Pump	VHDA	Virginia Housing Development Authority
HR	Handrail	VIF	Verify in Field
HT	Height	VOL	Volume
HTG	Heating	VT	Virginia Tech (So Hokies!)
HTR	Heater	VTR	Vent Thru Roof
HVAC	Heating / Ventilating / Air Cond.	VNC	Vinyl Wall Covering
HW	Hot Water		
HWD	Hardwood		
IN	Inches		
INCL	Included, Inclusive		
INS	Insulation		
INT	Interior		
JAN	Janitor		
JT	Joint		

MATERIALS & SYMBOLS

	ACOUSTICAL TILE		DETAIL TAG
	BATT INSULATION		EXTERIOR ELEVATIONS
	CARPET		SECTION "CUT" LINE
	CAST STONE		INTERIOR ELEVATIONS
	CERAMIC TILE		DETAIL
	CMU		DWG IDENTIFICATION
	CONCRETE		INTERNATIONAL SYMBOL OF ACCESSIBILITY
	EARTH		PROJECT NORTH
	FACE BRICK		DOOR TAG
	FOAM INSULATION		WINDOW TAG
	GLASS BLOCK		PARTITION TYPE TAG
	GRAVEL		ROOM SIGNAGE TAG
	MARBLE		ELEVATION DESIGNATION
	STEEL		SPOT ELEVATION (distance above (+) or below (-) main floor level)
	STONE		BREAK LINE
	STRUCTURAL CLAY TILE		REVISION TAG
	STRUCTURAL STEEL		ROOM IDENTIFICATION
	PLYWOOD		DETAIL AREA
	RIGID INSULATION		
	TERRAZZO		
	WOOD FINISH		
	WOOD BLOCKING		
	WOOD ROUGH FRAMING		
	W/West or Width		
	W/With		
	W/O Without		
	WC Water Closet		
	WD Wood		
	WH Water Heater		
	WT Weight		
	WTR Water		
	W/F Welded Wire Fabric		

DISCIPLINE CODES

DESIGNATION	DRAWING TYPE
G	GENERAL INFORMATION
D	DEMOLITION (ARCH.) / DETAILS (CIVIL)
C	CIVIL / SITE
L	LANDSCAPE
S	STRUCTURE
A	ARCHITECTURE
I	INTERIORS
P	PLUMBING
M	MECHANICAL
E	ELECTRICAL

SHEET CODES / DESIGNATORS

DESIGNATION	DRAWING TYPE
0	GENERAL INFORMATION
1	PLANS
2	ELEVATIONS
3	SECTIONS
4	LARGE SCALE PLANS
5	DETAILS
6	SCHEDULES & DIAGRAMS
7	INTERIORS (F F & E)
8	DESIGNER DEFINED

MISC. PROJECT NOTES

CONTRACTOR IS RESPONSIBLE FOR PROVIDING PERMITS, WORK, AND MATERIALS IN ACCORDANCE WITH ALL CODES, ORDINANCES, AND REGULATIONS APPLICABLE AT THE PROJECT LOCATION.

THESE DRAWINGS ARE INTENDED TO PROVIDE SUFFICIENT INFORMATION TO OBTAIN A BUILDING PERMIT AND TO CONVEY GENERAL DESIGN INTENT TO THE CONTRACTOR. ADDITIONAL TECHNICAL ADVICE AND DETAILING MAY BE REQUIRED FOR SUCCESSFUL COMPLETION OF THIS PROJECT AND IS THE CONTRACTOR'S RESPONSIBILITY.

BASE DRAWINGS FOR THIS CONTRACT WERE PROVIDED BY WASHINGTON COUNTY, VIRGINIA. BASE DRAWINGS HAVE BEEN SUPPLEMENTED BY MANUAL FIELD DOCUMENTATION UNDER THE CURRENT DESIGN CONTRACT.

CONTRACTOR SHALL BE RESPONSIBLE FOR CHECKING CONTRACT DOCUMENTS, FIELD CONDITIONS, AND DIMENSIONS FOR ACCURACY AND CONFIRMING THAT ALL WORK IS BUILDABLE, AS INDICATED, BEFORE PROCEEDING WITH CONSTRUCTION.

DO NOT SCALE DRAWINGS! USE ONLY THE DIMENSIONS INDICATED ON THE DRAWINGS. IF DIMENSIONS ON THE DRAWINGS ARE AT VARIANCE WITH ACTUAL CONDITIONS, SUCH THAT WORK CANNOT PROCEED AS INDICATED, REQUEST CLARIFICATION FROM THE ARCHITECT BEFORE PROCEEDING WITH CONSTRUCTION AND / OR FABRICATION OF ANY ITEM SCHEDULED FOR INSTALLATION.

CONTRACTOR IS RESPONSIBLE FOR THE MEANS, METHODS, AND TECHNIQUES OF CONSTRUCTION, SAFETY PRECAUTIONS IN CONNECTION WITH THE WORK, AND FOR THE ACTS OR OMISSIONS OF SUBCONTRACTORS.

INSTALL ALL MANUFACTURED ITEMS, MATERIALS, AND EQUIPMENT IN STRICT ACCORDANCE WITH MANUFACTURER'S RECOMMENDED SPECIFICATIONS.

UNLESS NOTED OTHERWISE, DIMENSIONS ARE FACE TO FACE OF WOOD STUDS, EXCEPT AT EXTERIOR WALLS WHERE DIMENSION IS TO FACE OF EXISTING GYPSUM WALLBOARD FINISH.

MASONRY DIMENSIONS ARE FACE TO FACE OF CONCRETE MASONRY UNITS.

CONCRETE DIMENSIONS ARE FACE TO FACE OF CONCRETE SURFACE.

ELEVATIONS AND LEVELS ARE SHOWN TO TOP OF FINISHED HARD SURFACES (i.e., TOP OF FINISHED WOOD FLOORING, ETC.). THIN-SET FINISH MATERIALS, SUCH AS CARPET, TILE, ETC. ARE IN ADDITION TO THE DIMENSION INDICATED.

ALL VERTICAL PIPING SHALL BE FURRED AND FINISHED TO MATCH ADJACENT WALLS. EXCEPTIONS ARE IN MECHANICAL / ELECTRICAL ROOM WHERE PIPING MAY REMAIN EXPOSED.

CEILING ACCESS PANELS SHALL BE PROVIDED IN OTHERWISE NON-ACCESSIBLE CEILING BELOW THE FOLLOWING MECHANICAL AND PLUMBING DEVICES:

- A. VALVES
- B. FLOW MEASURING DEVICES
- C. MIXING BOXES
- D. POWER OPERATED DAMPERS
- E. ACCESS PANELS IN DUCTWORK
- F. VOLUME AND BALANCING DEVICES
- G. WATER FLOW SWITCHES
- H. SPRINKLER SYSTEM DRAINS AND TEST CONNECTIONS
- I. PRESSURE SWITCHES

CODES & ORDINANCES

- 2018 - VIRGINIA CONSTRUCTION CODE (VIRGINIA UNIFORM STATEWIDE BUILDING CODE)
- 2018 - VIRGINIA EXISTING BUILDING CODE
- 2018 - VIRGINIA ENERGY CONSERVATION CODE
- 2018 - INTERNATIONAL PLUMBING CODE
- 2018 - INTERNATIONAL MECHANICAL CODE
- 2014 - NATIONAL ELECTRICAL CODE
- 2010 - ADA STANDARDS FOR ACCESSIBLE DESIGN

OCCUPANCY

BUSINESS GROUP - 'B'

TOTAL OCCUPANT LOAD

LESS THAN 50 PERSONS.

CONSTRUCTION TYPE

TYPE V-B

FIRE PROTECTION

NO AUTOMATIC SPRINKLER SYSTEM IS REQUIRED.
NO FIRE ALARM SYSTEM IS REQUIRED.

BUILDING HEIGHT / AREA

1 STORY, ACTUAL / 3 STORIES ALLOWED BY CODE.
9,000 SQ. FT. PER STORY ALLOWED BY CODE / 9,000 SQ. FT. PER BLDG. ALLOWED

PROJECT AREA

FIRST FLOOR: 7,888.58 SQ. FT. (1,475.25 SQ. FT. ADDITION / 6,413.33 SQ. FT. EXISTING) / 9,000 SQ. FT. ALLOWED BY CODE.

AREA INCREASE? NO

INTERIOR FINISHES

FLAME SPREAD RATING SHALL BE IN ACCORDANCE WITH ASTM E84 AND GROUPED IN THE FOLLOWING CLASSES:

- CLASS A: FLAME SPREAD 0-25, SMOKE-DEVELOPED 0-450.
- CLASS B: FLAME SPREAD 26-75, SMOKE-DEVELOPED 0-450.
- CLASS C: FLAME SPREAD 76-200, SMOKE-DEVELOPED 0-450.

THE RATINGS FOR THIS GROUP 'B' OCCUPANCY SHALL BE IN ACCORDANCE WITH THE "NON-SPRINKLERED" PORTION OF THE VIRGINIA CONSTRUCTION CODE, TABLE 803.5, INTERIOR WALL AND CEILING FINISH REQUIREMENTS BY OCCUPANCY.

EXIT ENCLOSURES AND PASSAGEWAYS: A
CORRIDORS: B
ROOMS AND ENCLOSED SPACES: C

ENERGY CONSERVATION

PER THE VIRGINIA ENERGY CONSERVATION CODE, CHAPTER 8, SECTION 801, "CLIMATE ZONES", THE ENTIRE COMMONWEALTH OF VIRGINIA LIES WITHIN CLIMATE ZONE 4. THIS PROJECT SITE FALLS WITHIN SUB-ZONE "A" MOIST.

IN ACCORDANCE WITH THE VIRGINIA ENERGY CONSERVATION CODE, CHAPTER 5, TABLE 502.2, "BUILDING ENVELOPE REQUIREMENTS-OPAQUE ASSEMBLIES", THE FOLLOWING MINIMUM INSULATION REQUIREMENTS APPLY TO ZONE 4:

- ATTIC AND OTHER ROOF INSULATION: R-38
- WALLS AND ABOVE GRADE INSULATION: R-13 + R1.5 CONTINUOUS INSULATION
- UNEHEATED SLABS ON GRADE: R-10 FOR 24" BELOW GRADE
- SWINGING OPAQUE DOORS: U-0.61
- SWINGING ENTRANCE DOORS: U-0.77
- WINDOWS (FIXED): U-0.38
- WINDOWS (OPERABLE): U-0.45
- FENESTRATION SHGC: 0.40
- FENESTRATION % OF EXTERIOR WALL: 11.28%

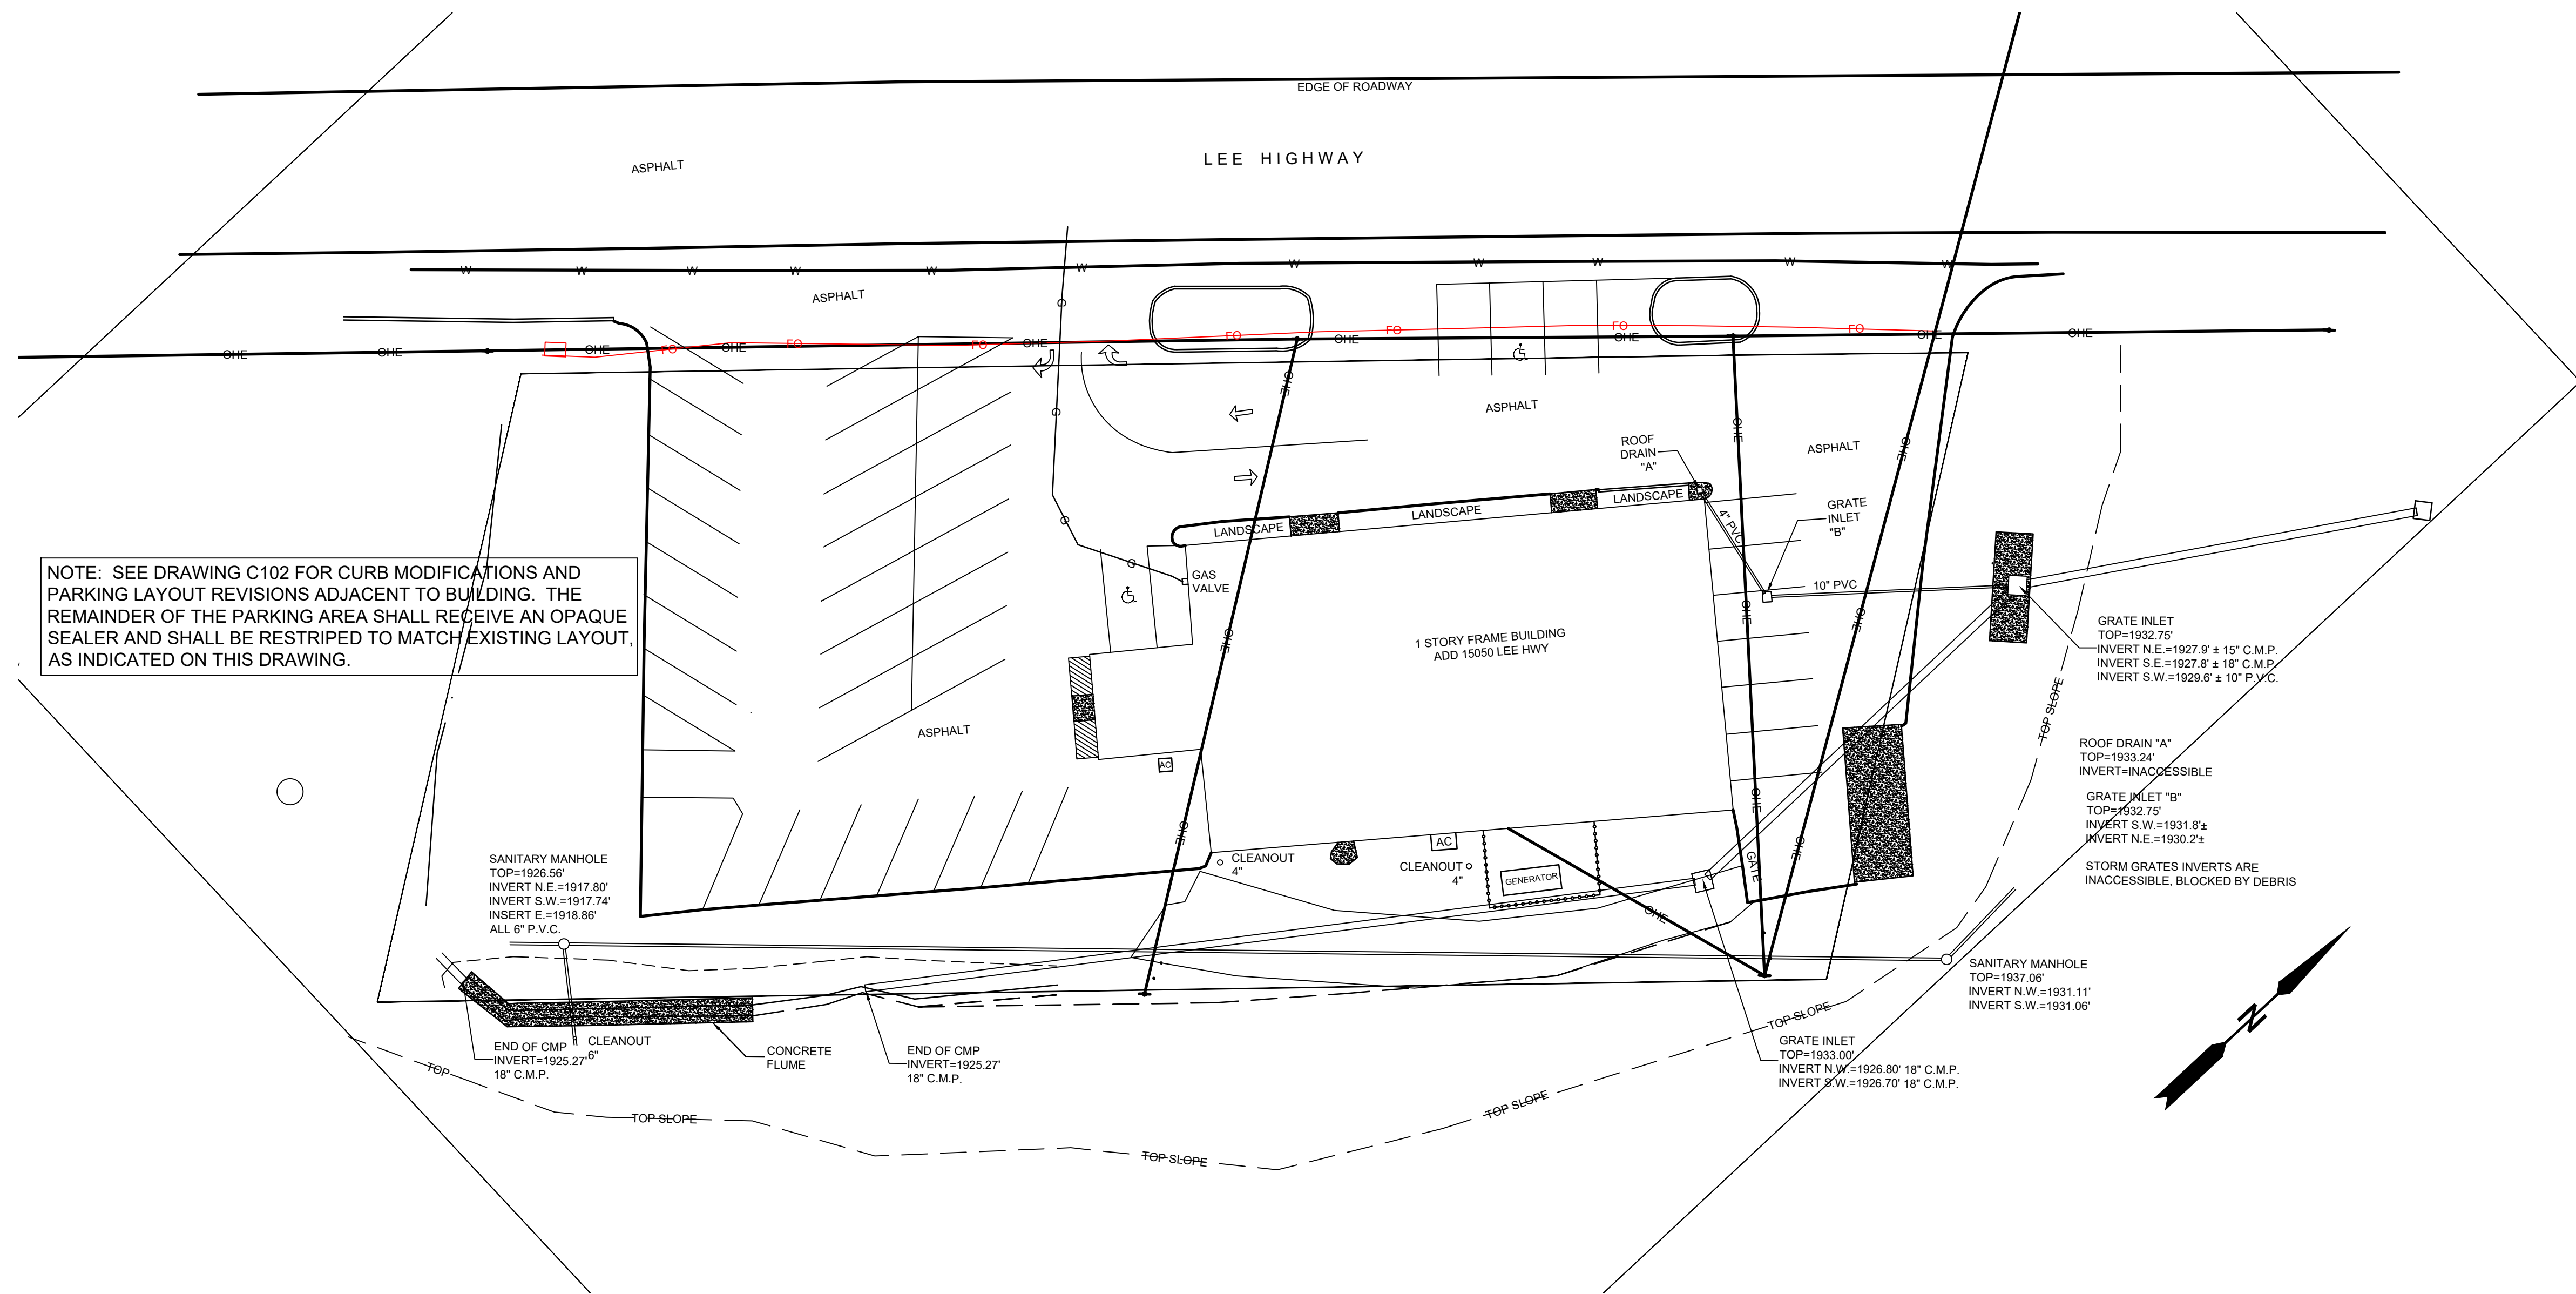
BUILDING RENOVATION FOR
 WASHINGTON COUNTY, VIRGINIA
 ANIMAL SHELTER
 15050 LEE HIGHWAY
 BRISTOL, VIRGINIA 24201

PROJECT INFORMATION



DATE:	06-30-2023
NO.	REVISION DATE
1	
2	
3	
SHEET:	G101
DRAWN BY:	SV
CHECKED BY:	MW
PROJECT NO.:	TLG-22136
THE LANE GROUP INC.	

the
LANE
 GROUP
 engineering
 architecture
 environmental
 310 Valley Street NW
 Abingdon, VA 24210
 276.206.5688 - office
 Abingdon | Big Stone Gap | Galax
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NOTE: SEE DRAWING C102 FOR CURB MODIFICATIONS AND PARKING LAYOUT REVISIONS ADJACENT TO BUILDING. THE REMAINDER OF THE PARKING AREA SHALL RECEIVE AN OPAQUE SEALER AND SHALL BE RESTRIPTED TO MATCH EXISTING LAYOUT, AS INDICATED ON THIS DRAWING.

SANITARY MANHOLE
TOP=1926.30'
INVERT N.E.=1917.80'
INVERT S.W.=1917.74'
INVERT E.=1918.86'
ALL 6" P.V.C.

END OF CMP CLEANOUT
INVERT=1925.27'
18" C.M.P.

CONCRETE FLUME

END OF CMP CLEANOUT
INVERT=1925.27'
18" C.M.P.

CLEANOUT 4"

CLEANOUT 4"

GENERATOR

GRATE INLET
TOP=1933.00'
INVERT N.W.=1928.90' 18" C.M.P.
INVERT S.W.=1928.70' 18" C.M.P.

SANITARY MANHOLE
TOP=1937.06'
INVERT N.W.=1931.11'
INVERT S.W.=1931.06'

GRATE INLET
TOP=1932.75'
INVERT N.E.=1927.9' ± 15" C.M.P.
INVERT S.E.=1927.8' ± 18" C.M.P.
INVERT S.W.=1929.6' ± 10" P.V.C.

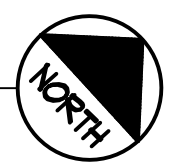
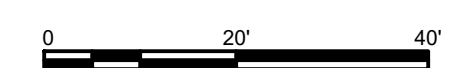
ROOF DRAIN "A"
TOP=1933.24'
INVERT=INACCESSIBLE

GRATE INLET "B"
TOP=1932.75'
INVERT S.W.=1931.8' ±
INVERT N.E.=1930.2' ±

STORM GRATES INVERTS ARE INACCESSIBLE, BLOCKED BY DEBRIS

PROPERTY SURVEY

SCALE: 1" = 20'-0"



BUILDING RENOVATION FOR
WASHINGTON COUNTY, VIRGINIA
ANIMAL SHELTER
15050 LEE HIGHWAY
BRISTOL, VIRGINIA 24201

PROPERTY SURVEY




DATE:	06-30-2023
NO.	REVISION DATE
1	*
2	
3	
SHEET:	C101
DRAWN BY:	CHECKED BY:
PROJECT NO.:	TLG-22136
THE LANE GROUP INC.	

SITE PLAN KEY NOTES



- A. COORDINATE OVERHEAD ELECTRICAL LINE RELOCATION WITH UTILITY.
- B. EXISTING OVERHEAD ELECTRICAL SERVICE LINE SHALL REMAIN.
- C. REMOVE EXISTING 12" X 12" SUMP PUMP AT EXISTING BUILDING CORNER.
- D. REMOVE EXISTING 4" PVC STORM LEADER.
- E. 4000 PSI X 4" THICK AIR-ENTRAINED CONCRETE STOOOP ON 4" NO. 57 STONE BASE. REINFORCE WITH 6 X 6 X W/4 / M/4 WELDED WIRE FABRIC. PLACE WIRE FABRIC IN TOP THIRD OF CONCRETE. TOP OF CONCRETE STOOOP FLUSH WITH FLOOR LEVEL. WARP ADJACENT ASPHALT TO BE FLUSH WITH TOP OF CONCRETE STOOOP ON THREE SIDES, EXCEPT AT SHERIFF'S OFFICE ENTRANCE WHERE TOP OF SLAB WILL BE APPROX. 6" ABOVE THE ASPHALT AT THE DOOR. TURN EDGES DOWN 1'-0".
- F. 4" X 6" X 6'-0" LONG UV RESISTANT RECYCLED PLASTIC WHEELSTOPS, WHERE INDICATED. PROVIDE MOUNTING HARDWARE SUITABLE FOR ASPHALT PAVEMENT. BASIS OF DESIGN SHALL BE ITEM # "ULTRA4672B" AS MANUFACTURED BY IDEALSHIELD. COLOR AT TWO ACCESSIBLE PARKING SPACES SHALL BE BLUE. COLOR AT ALL OTHER SPACES SHALL BE GRAY.
- G. ADA COMPLIANT PARKING SIGNAGE AT CENTERLINE OF ACCESSIBLE PARKING SPACES. LOCATE SIGNAGE FOR SPACE CLOSEST TO BUILDING ENTRANCE ON THE BUILDING WALL. LOCATE SIGNAGE FOR THE OTHER SPACE 1'-0" BACK FROM THE CENTERLINE OF THE PARKING SPACE STRIPE. SEE SIGN DETAIL ON DRAWING CS01. PAINT POST TO MATCH BOLLARD COVER.
- H. 6-INCH DIAMETER CONCRETE FILLED STEEL PIPE BOLLARD. CUT CONCRETE FLUSH WITH TOP OF BOLLARD AND PROVIDE A 1/4-INCH THICK HDPE DOMED PLASTIC COVER. BASIS OF DESIGN BOLLARD COVER SHALL BE AS MANUFACTURED BY IDEALSHIELD. BOLLARD COLOR SHALL BE BROWN (PANTONE COLOR #P0 440C).
- J. SEAL EXISTING ASPHALT PAVEMENT WITH AN OPAQUE ASPHALT SEALER AND STRIPE PARKING AREA AS INDICATED. ALL PAVEMENT STRIPING SHALL BE 4" WIDE, WHITE COLOR.
- K. AT ACCESSIBLE AISLE, PAINT DIAGONAL LINES AT A 45-DEGREE ANGLE AND AT 2'-6" ON CENTER. STRIPES SHALL BE 4" WIDE, WHITE COLOR. VAN ACCESSIBLE AISLE SHALL BE 9'-0" WIDE. PAINT THE WORDS "NO PARKING" IN 12" HIGH BLOCK LETTERS WHERE INDICATED IN WHITE COLOR. CENTER TEXT BETWEEN DIAGONAL STRIPES.
- L. PAINT THE INTERNATIONAL HANDICAPPED SYMBOL AT THE CENTERLINE OF EACH ACCESSIBLE PARKING SPACE USING A PROFESSIONALLY FABRICATED STENCIL. PAINT SYMBOL APPROX. 3'-0" HIGH, WHITE COLOR. ALIGN THE BOTTOM OF THE WHEELCHAIR WITH THE END OF ADJACENT PARKING LOT STRIPING. ALTERNATELY, PROVIDE AN ADA PAVEMENT "DECAL" # IN-19-3761" AS MANUFACTURED BY STOP-PAINTING.COM OR ARCHITECT APPROVED EQUAL.
- M. SAW CUT AND REMOVE EXISTING ASPHALT PAVEMENT BACK 4'-0" FROM FACE OF NEW BUILDING ADDITION. PROVIDE LANDSCAPE FABRIC AND STONE FILL TO MATCH EXISTING STONE.
- N. REMOVE / RELOCATE EXISTING GRATE INLET.

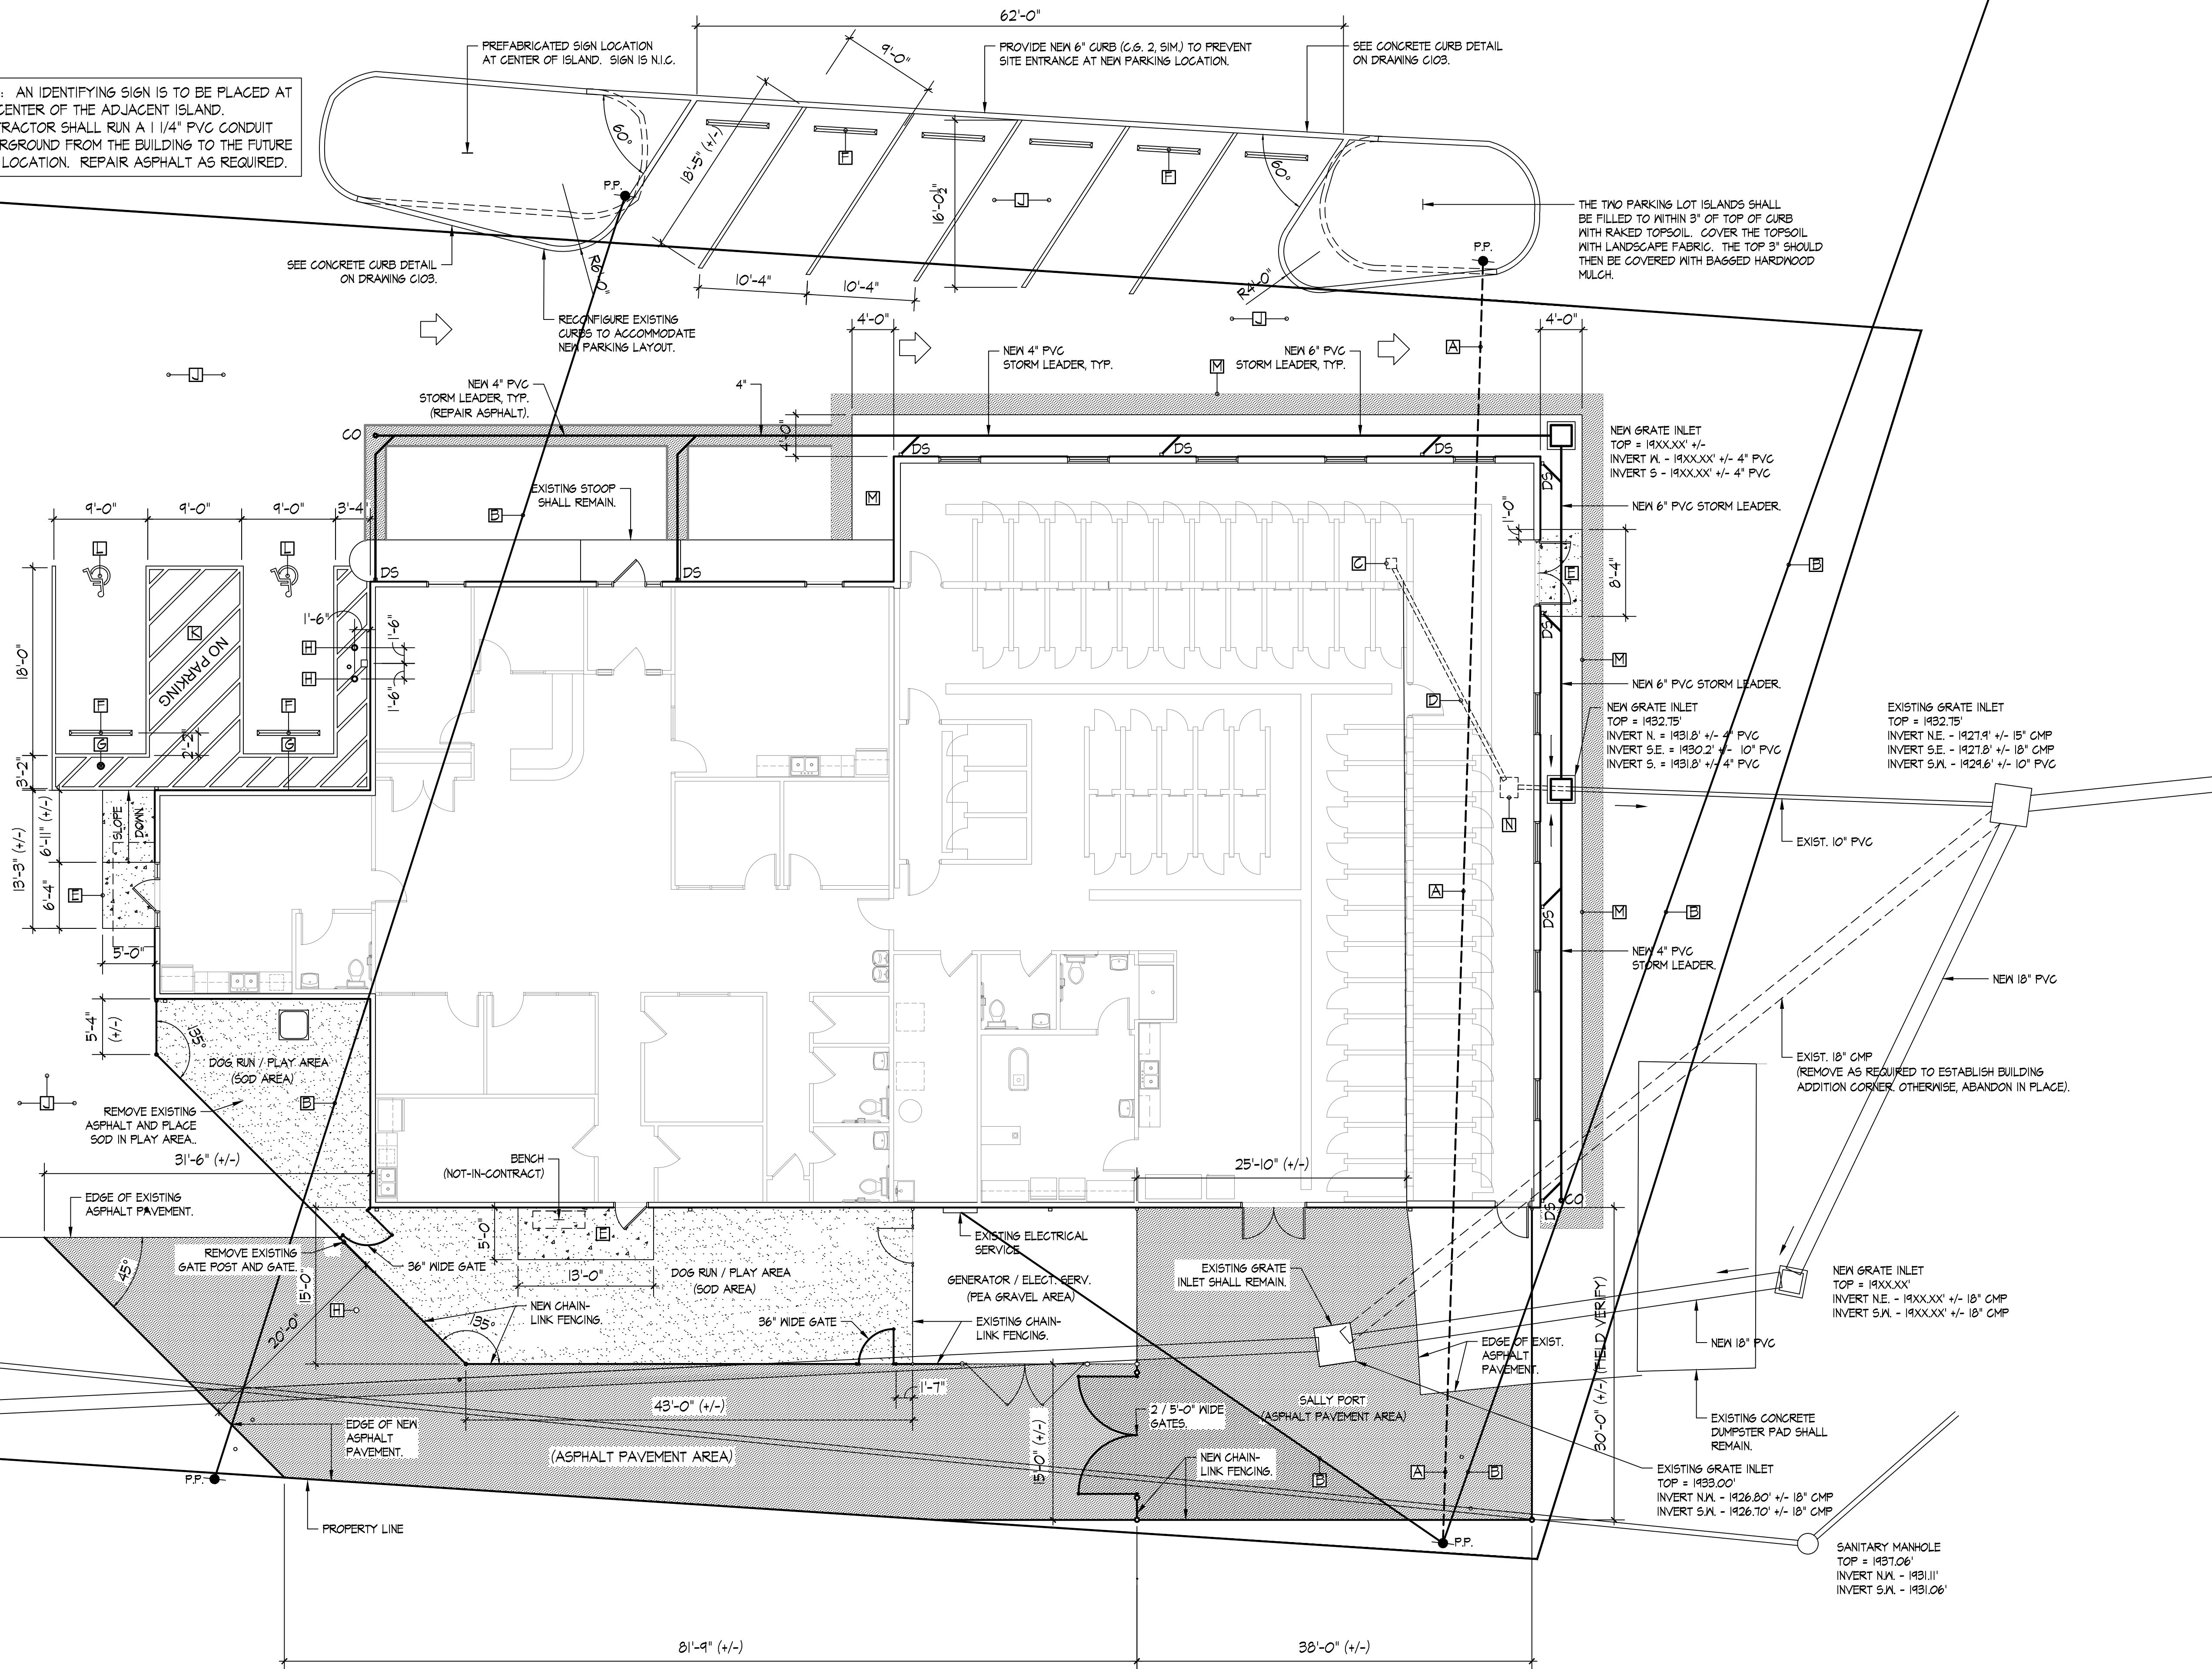NOTE: AN IDENTIFYING SIGN IS TO BE PLACED AT THE CENTER OF THE ADJACENT ISLAND. CONTRACTOR SHALL RUN A 1/4" PVC CONDUIT UNDERGROUND FROM THE BUILDING TO THE FUTURE SIGN LOCATION. REPAIR ASPHALT AS REQUIRED.





SITE PLAN

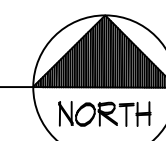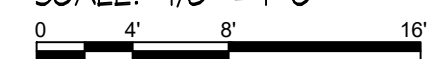SCALE: 1/8" = 1'-0"





DATE:	06-30-2023
NO.	REVISION DATE
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SHEET:	C102
DRAWN BY:	CHECKED BY:
PROJECT NO.:	TLG-22136
THE LANE GROUP INC.	

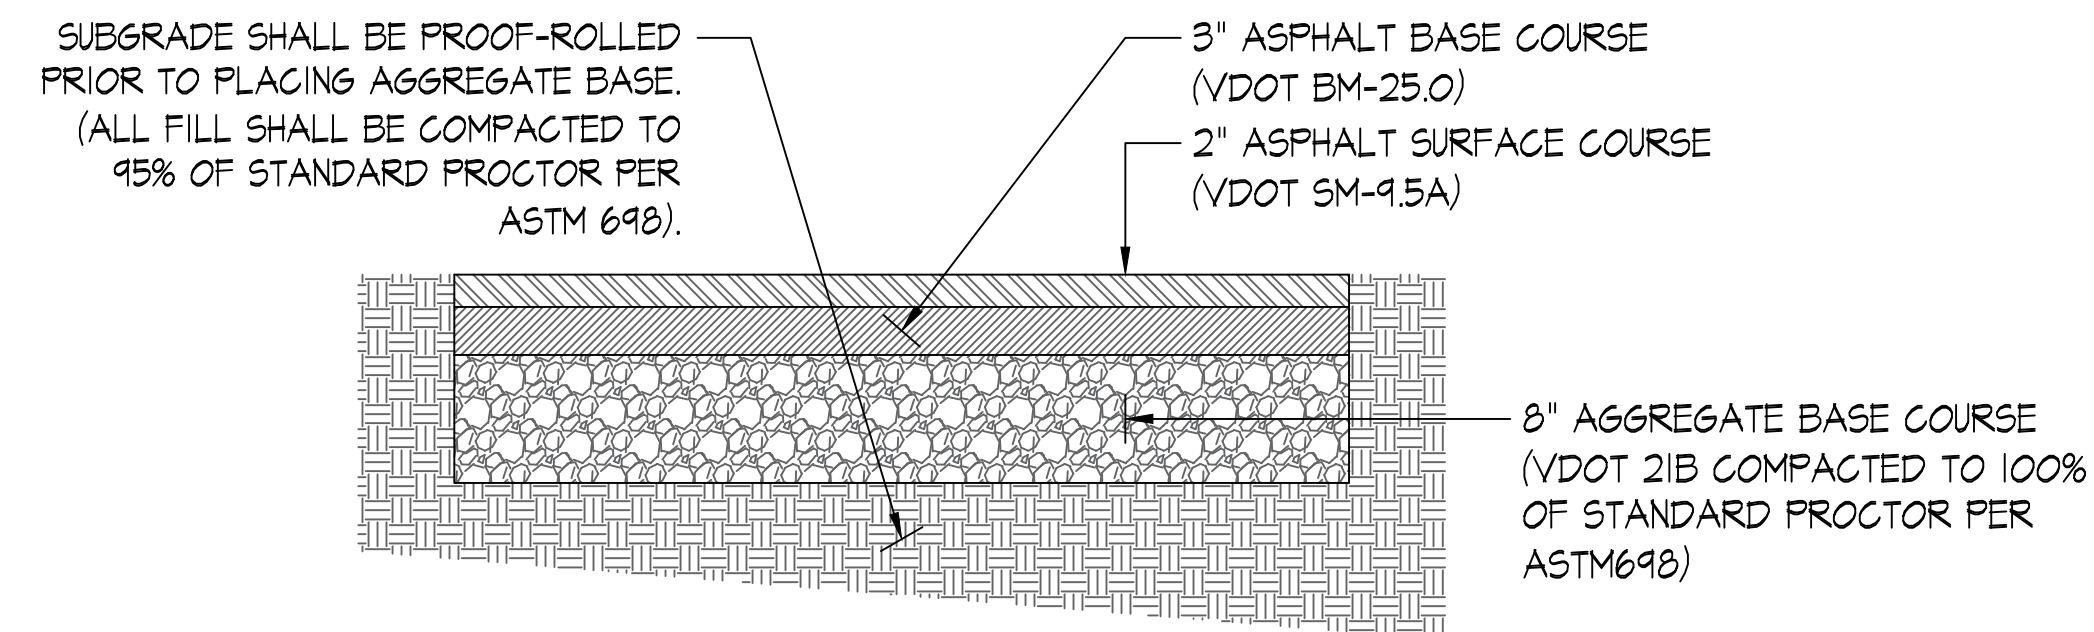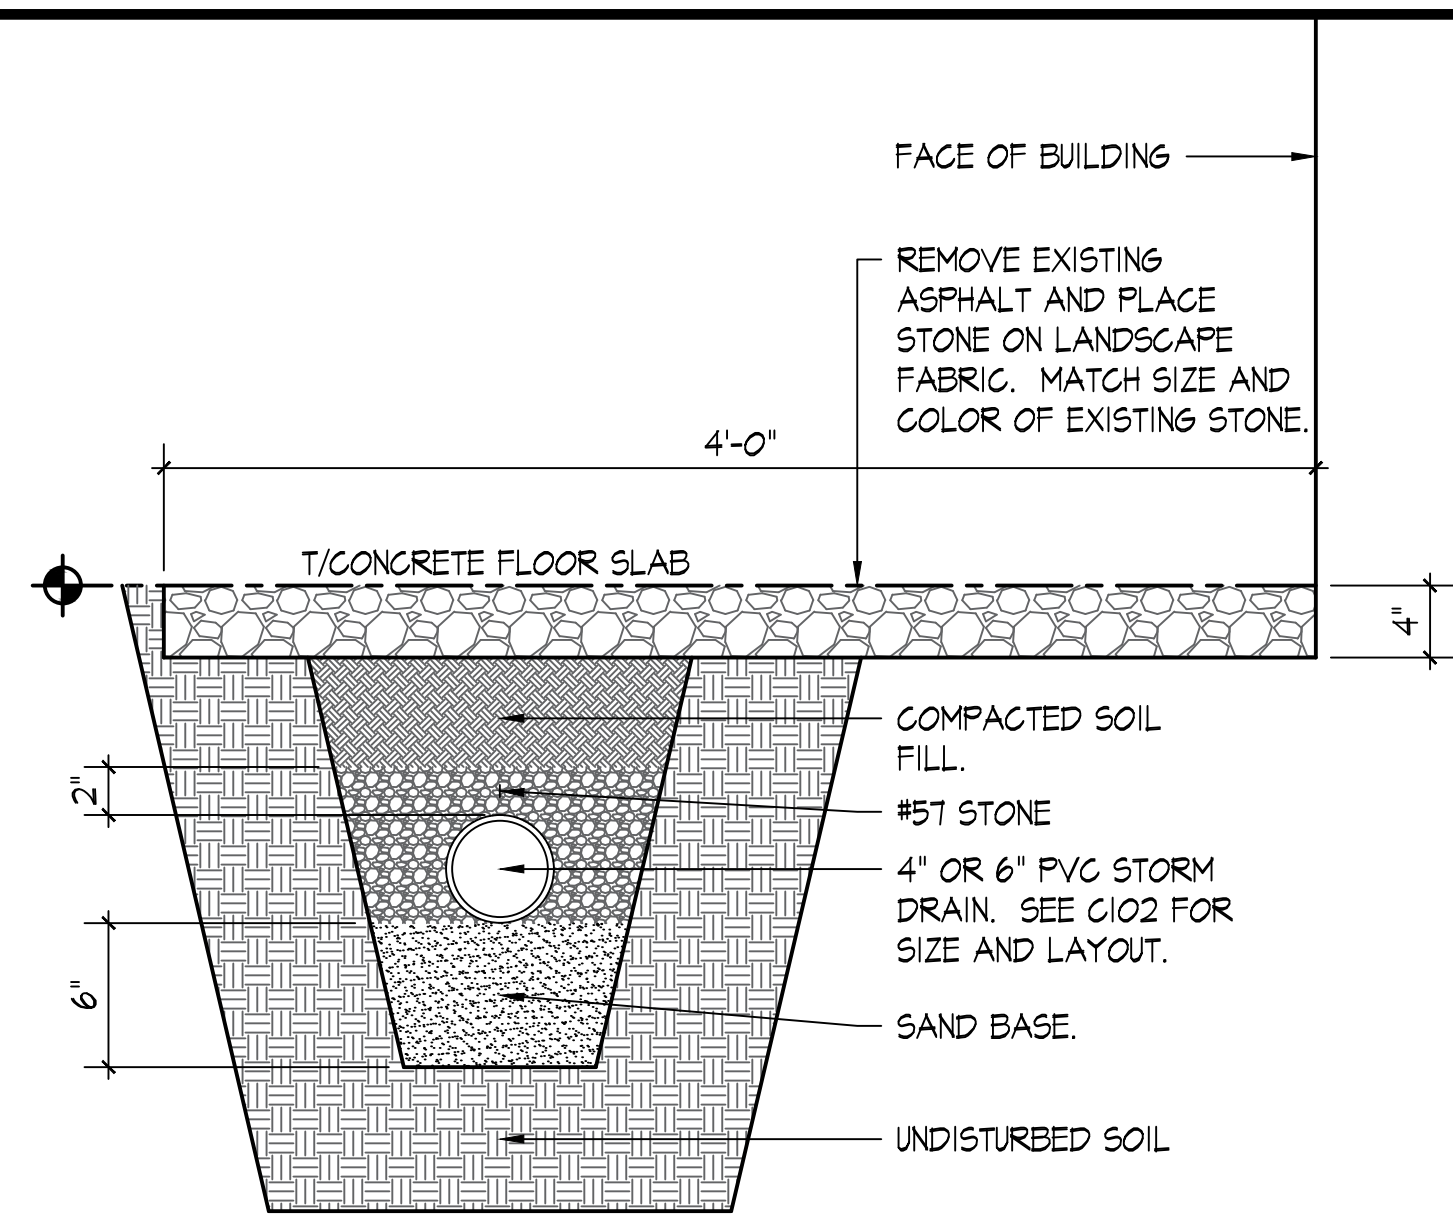


D STORM DRAIN DETAIL
C103 SCALE: 1/2"=1'-0"

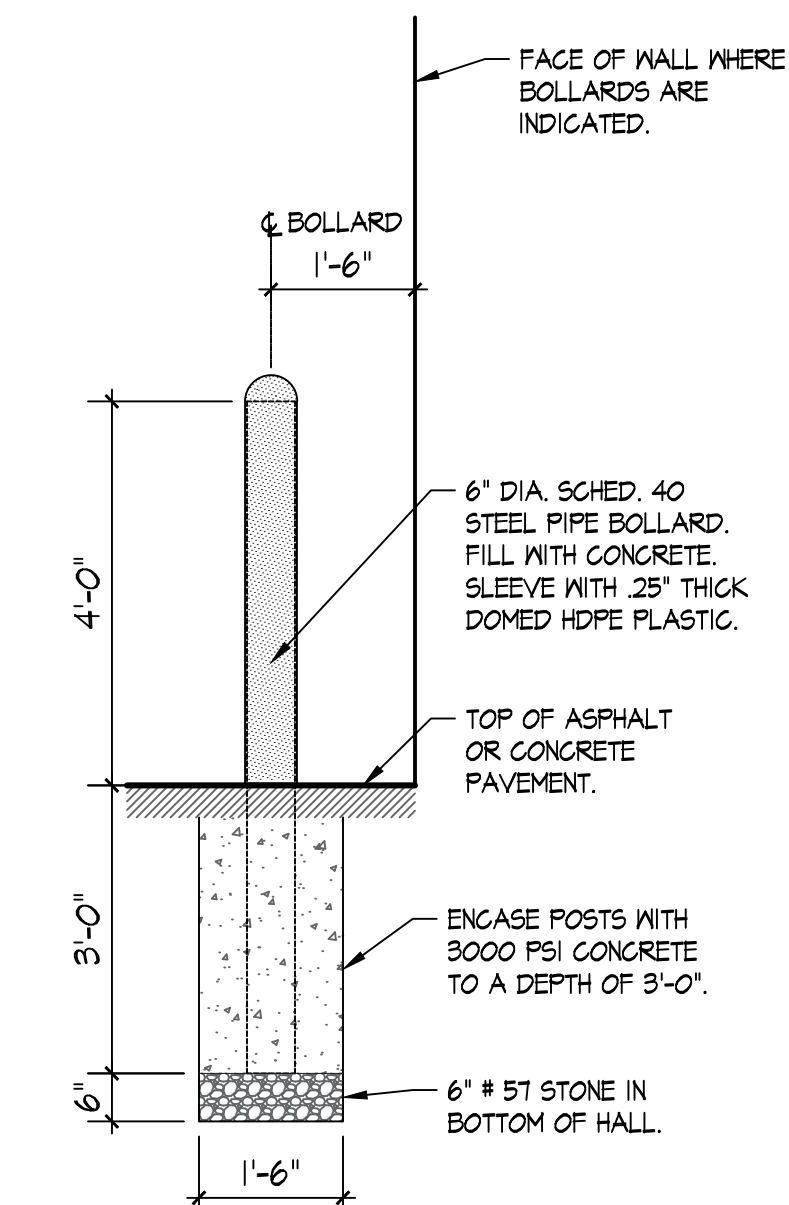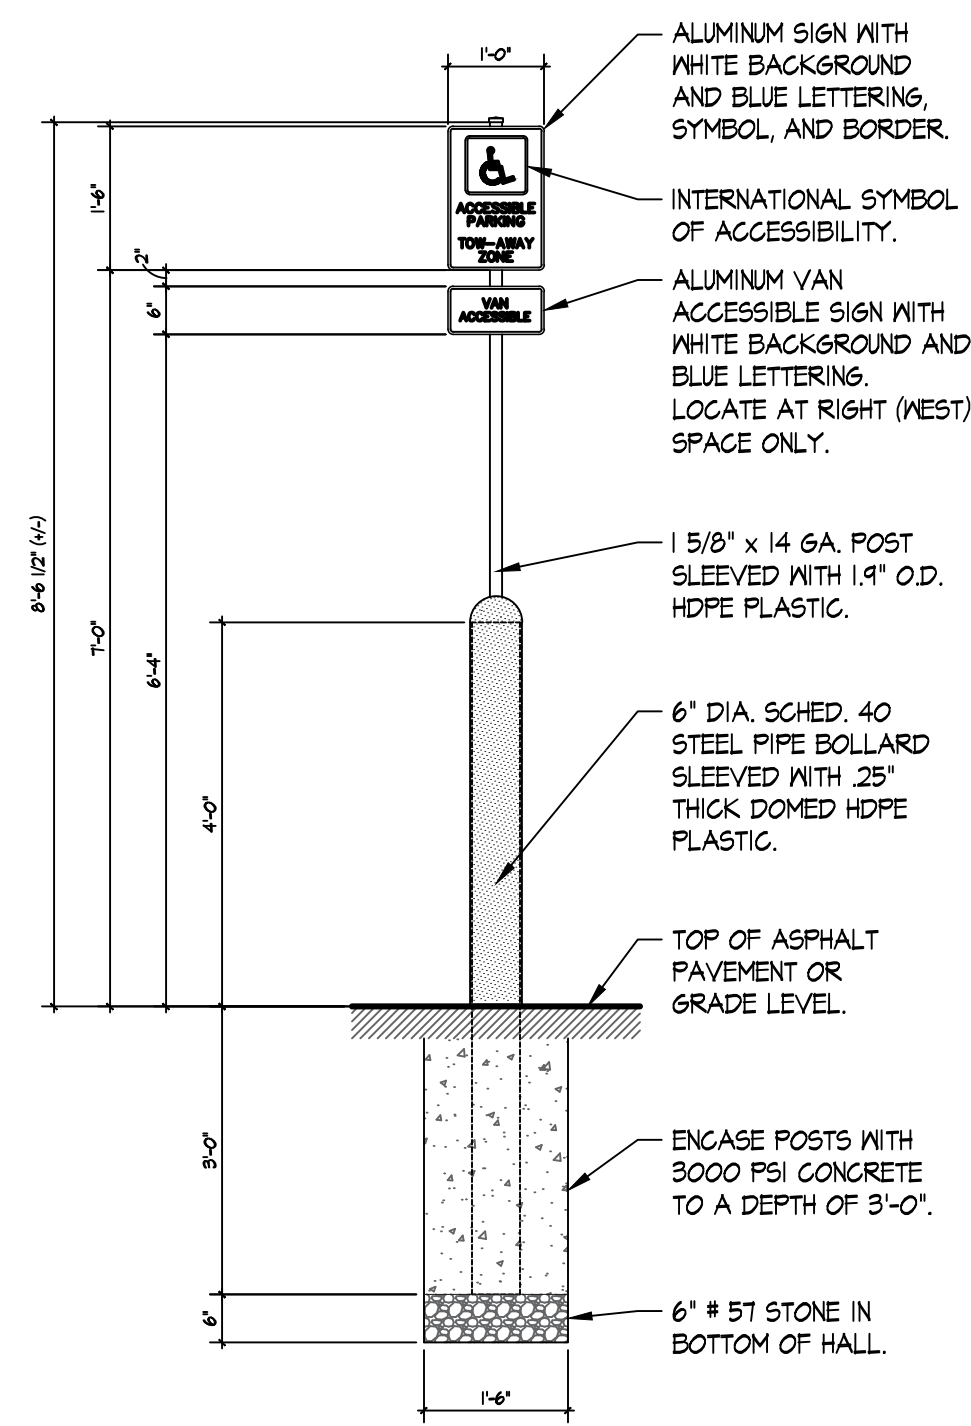E TYPICAL PAVED PARKING SECTION
C103 NOT TO SCALE



C ACCESSIBLE PARKING SIGN POST DETAIL
C103 SCALE: 1/2"=1'-0"

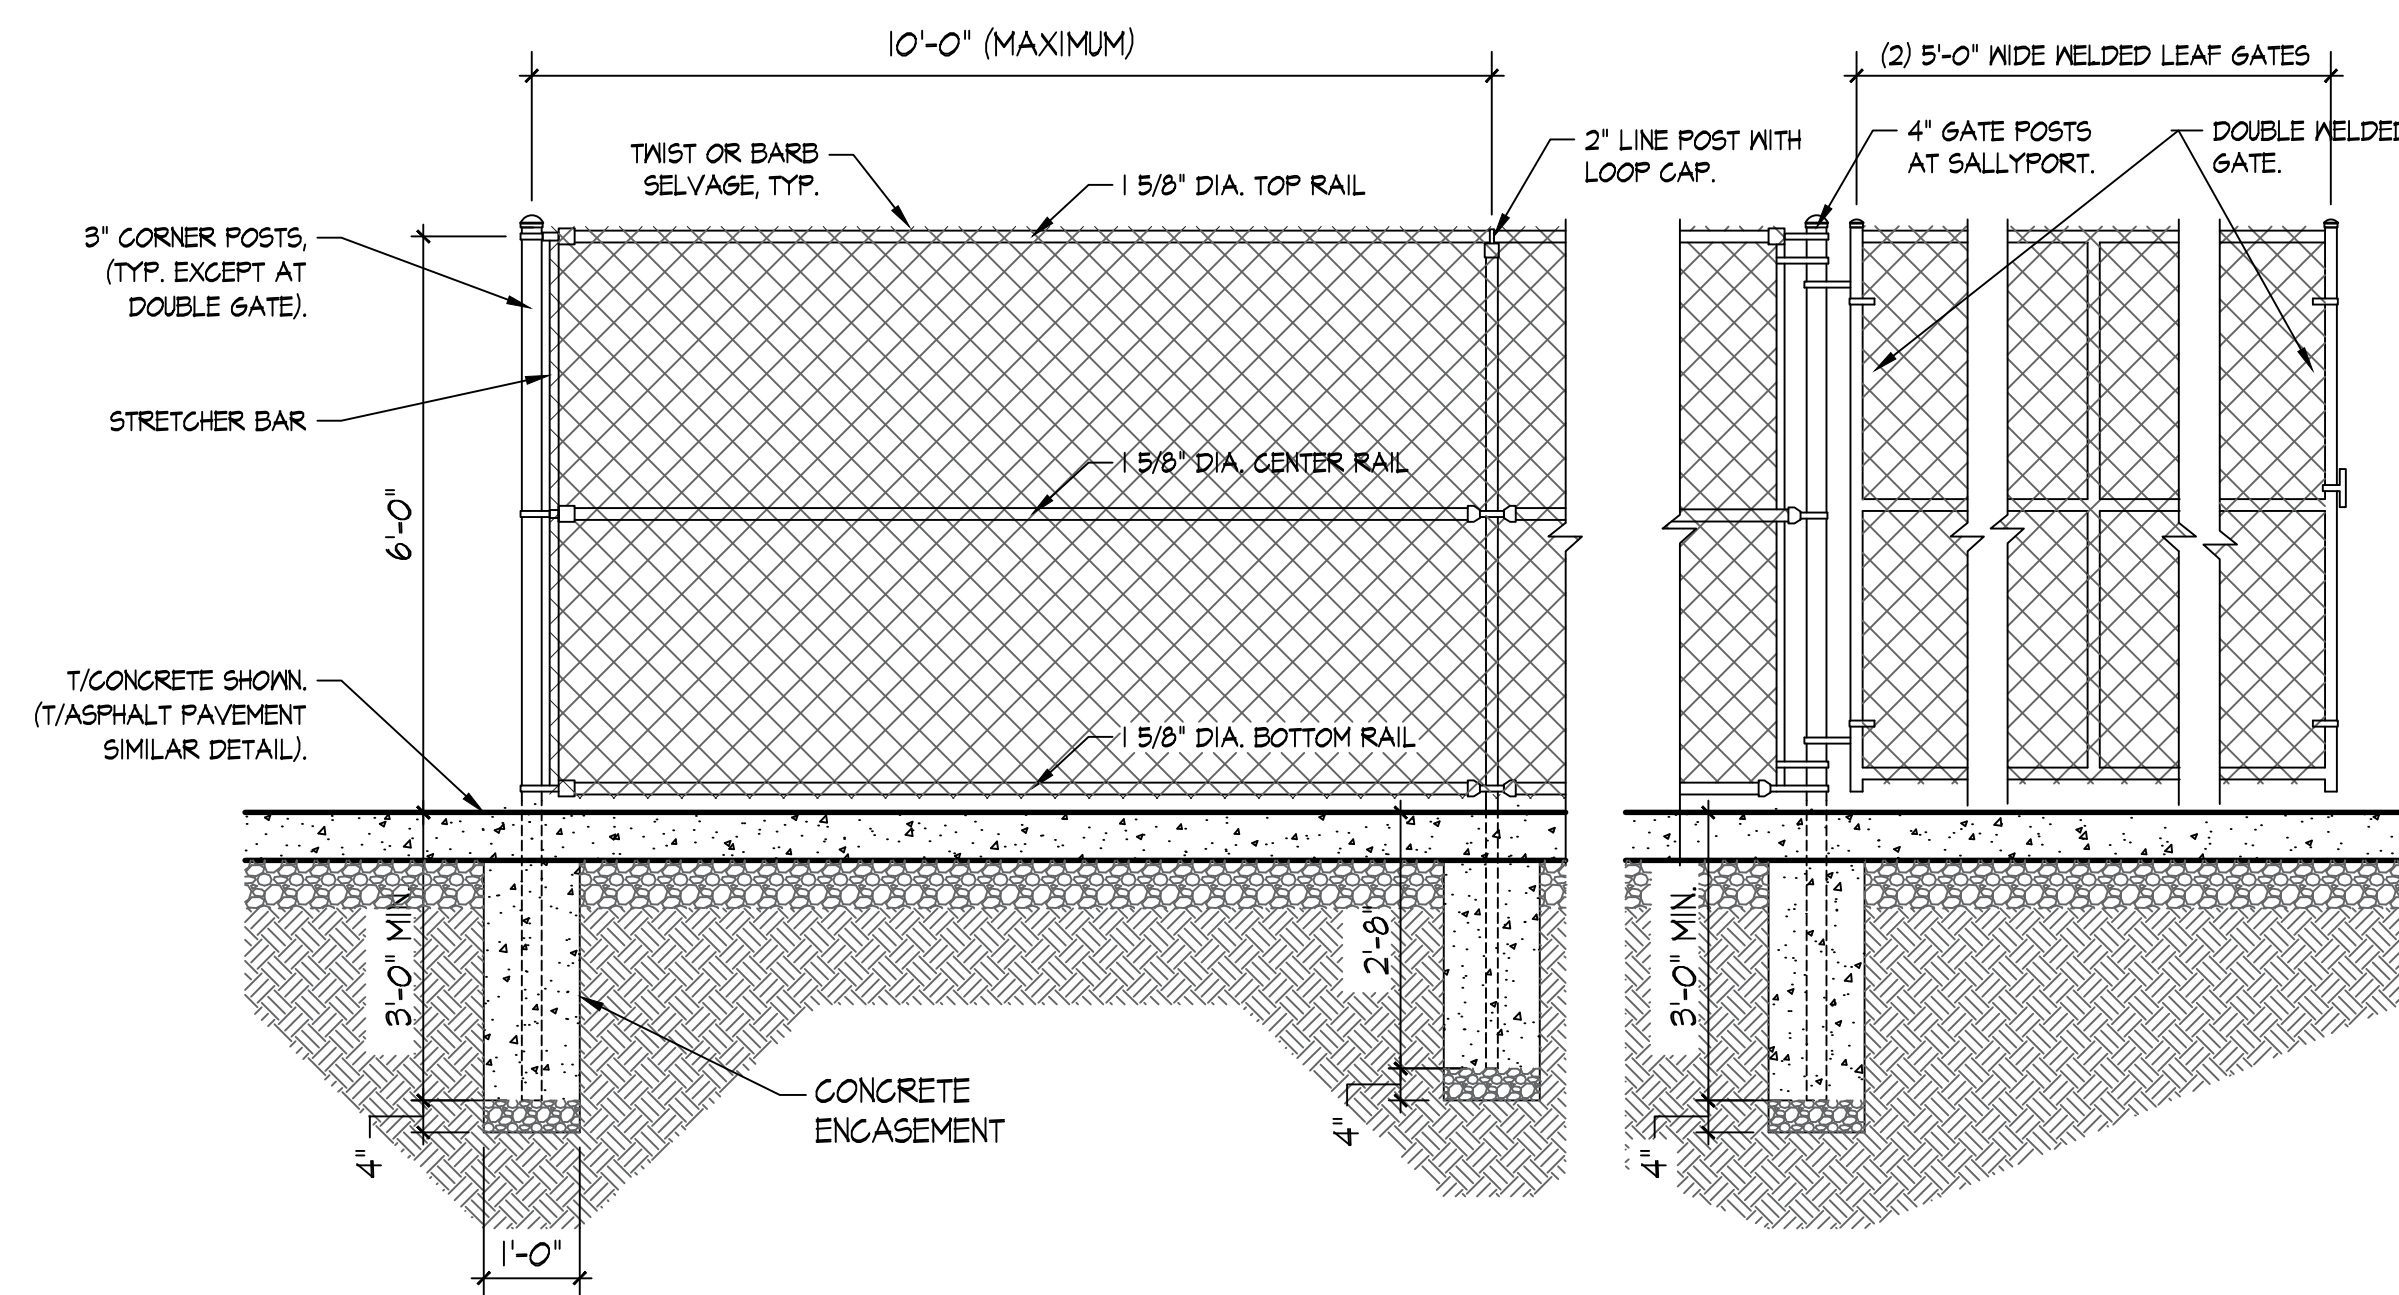B EXTERIOR BOLLARD DETAIL
C103 SCALE: 1/2"=1'-0"



A CHAIN-LINK FENCING DETAIL
C103 SCALE: 1/2"=1'-0"

- CHAIN-LINK FENCING NOTES:
1. DOUBLE GATE SHALL HAVE A LOCKING MECHANISM, DROP ROD, AND TRUSS ROD.
 2. ALL FENCE COMPONENT MATERIALS SHALL BE HOT-DIPPED GALVANIZED STEEL OR IRON.
 3. ALL FENCE FABRIC SHALL BE 9-GAUGE (HEAVY DUTY).


BUILDING RENOVATION FOR
WASHINGTON COUNTY, VIRGINIA
ANIMAL SHELTER
15050 LEE HIGHWAY
BRISTOL, VIRGINIA 24201

SITE DETAILS



DATE:	06-30-2023
NO.	REVISION DATE
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SHEET:	C103
DRAWN BY:	CHECKED BY:
PROJECT NO.:	TLG-22136
THE LANE GROUP INC.	

the **LANE** GROUP
engineering
architecture
environmental
Abingdon | Big Stone Gap | Galax
www.thelaneinc.com
310 Valley Street NW
Abingdon, VA 24210
276.206.8571 - office

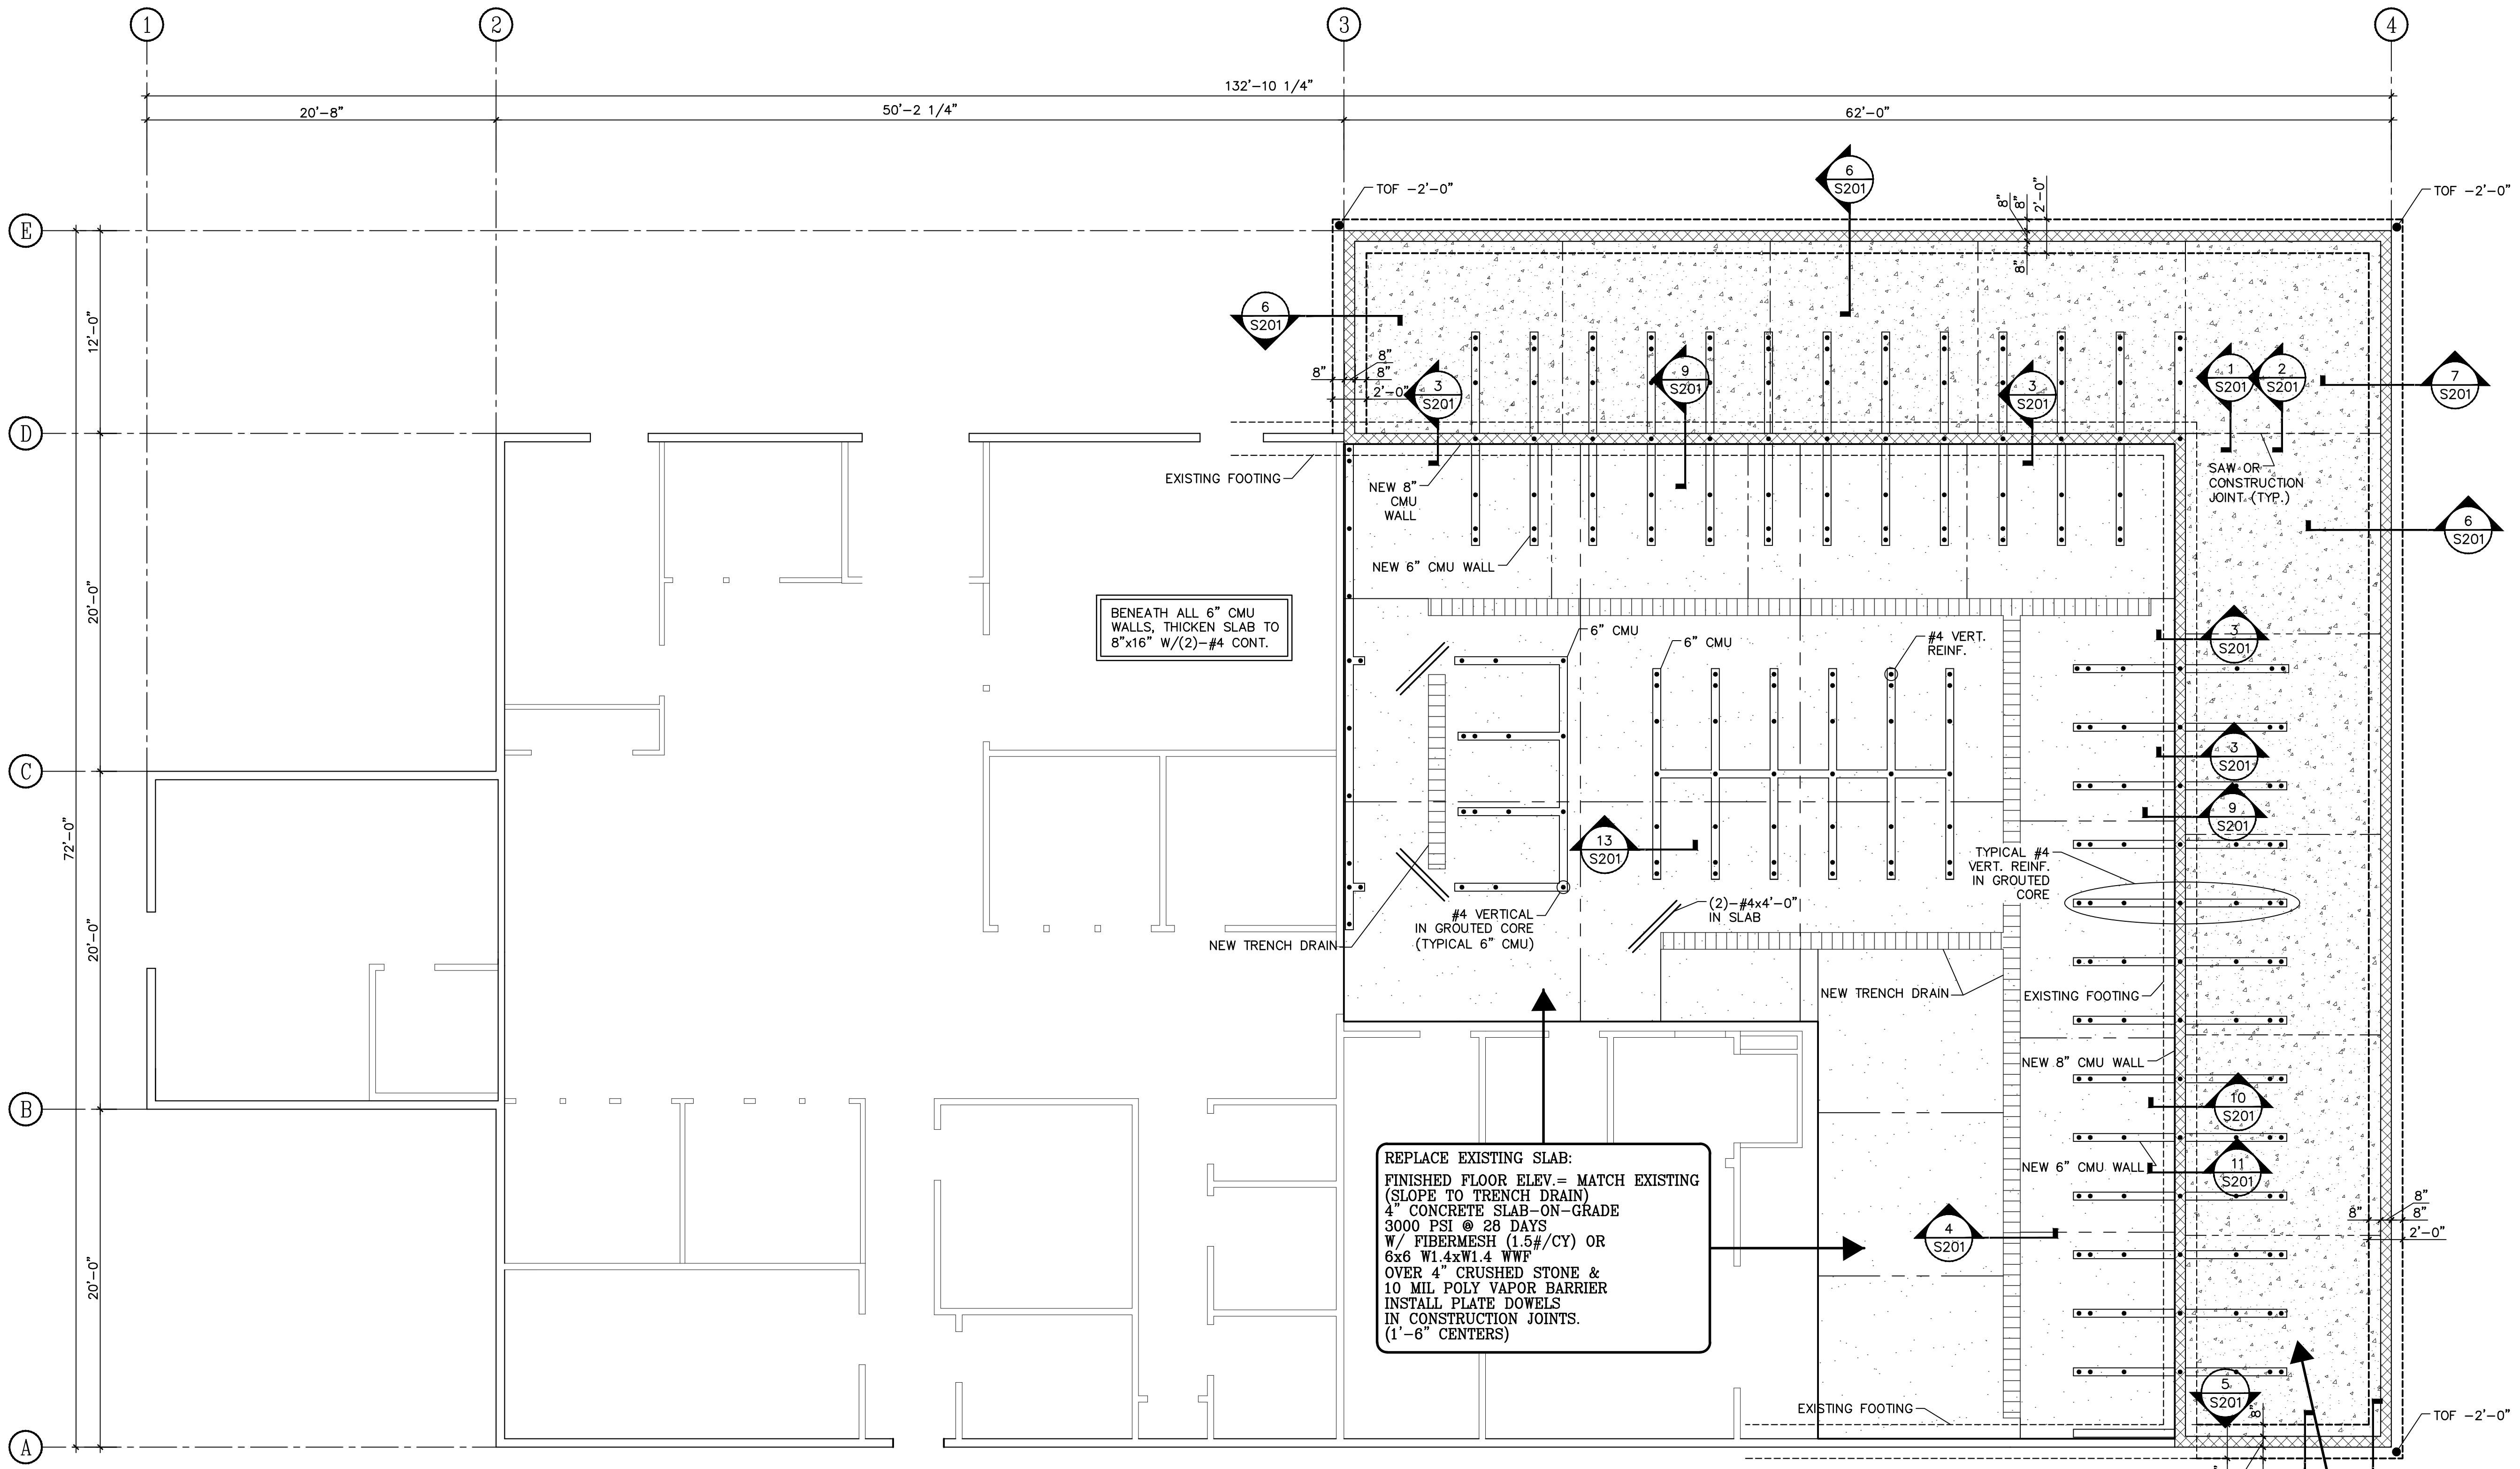

1 FOUNDATION PLAN
S101

3/16" = 1'-0"

VERTICAL WALL REINFORCING

#4 @ 4'-0" o.c. ALL LOCATIONS (UNLESS NOTED OTHERWISE) IN GROUDED CORE, CENTER IN CORE
ALL REINFORCING SHALL EXTEND FROM FOOTING TO TOP OF WALL
WALLS SHALL BE REINFORCED IN ACCORDANCE WITH MASONRY NOTES, GROUTING METHOD DETAILS, AND CMU WALL REINFORCING DETAIL ON SHEET S200.

CONTINUOUS FOOTING REINF.

SIZE	LONG. REINF.	LAT. REINF.
2'-0" X 1'-0"	(3)-#4	#4 @ 2'-0" o.c.

NEW SLAB:
FINISHED FLOOR ELEV. = MATCH EXISTING
4" CONCRETE SLAB-ON-GRADE
3000 PSI @ 28 DAYS
W/ FIBERMESH (1.5#/CY) OR
6x6 W1.4xW1.4 WWF
OVER 4" CRUSHED STONE &
10 MIL POLY VAPOR BARRIER
INSTALL PLATE DOWELS
IN CONSTRUCTION JOINTS.
(1'-6" CENTERS)

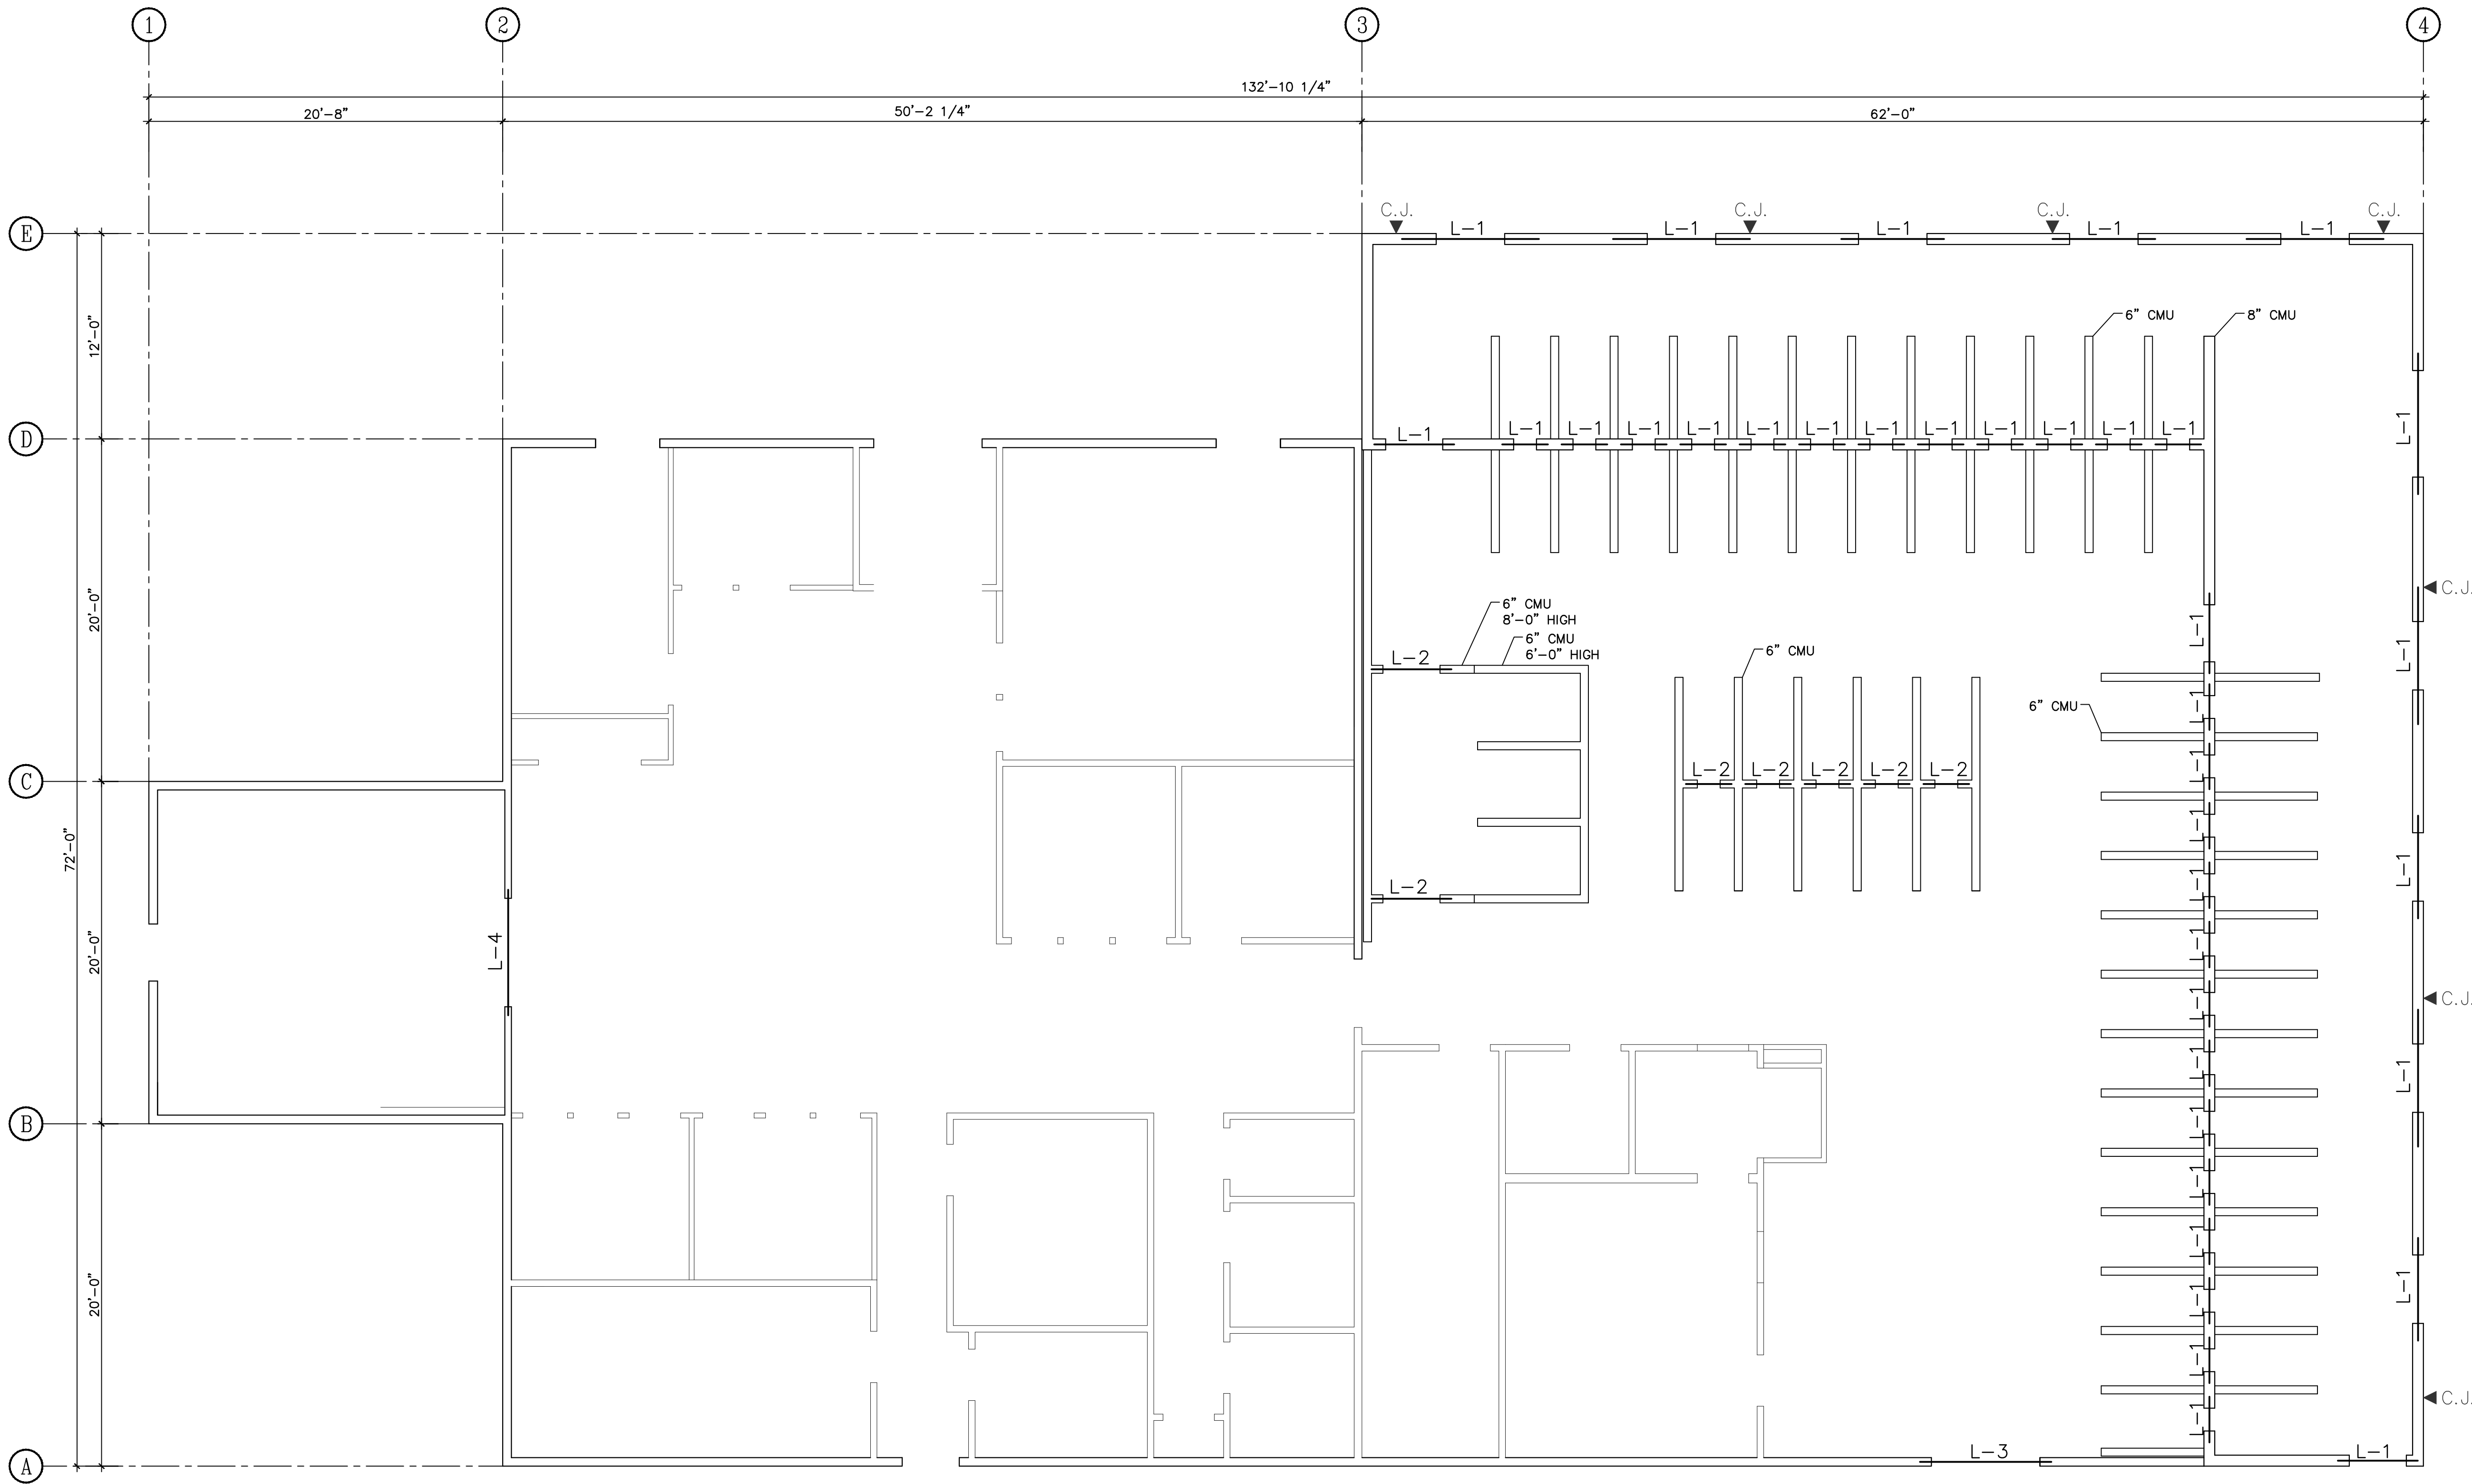


DATE: 06-30-2023

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SHEET: **S101**
 DRAWN BY: ST CHECKED BY: JLJ
 PROJECT NO.:
 THE LANE GROUP INC.

J.L. Jacobs & Associates
 511 Tusculum Boulevard
 Greeneville, Tennessee 37745
 (423) 787-7828
 www.jlengineering.com



1 LINTEL PLAN
S102

LINTEL SCHEDULE			
MARK	SHAPE	MEMBER	BEARING (EACH END)
L-1		8" BOND BEAM W/2-#4 REBAR	24"
L-2		6" PRECAST LINTEL W/2-#4 REBAR T&B	24"
L-3		(2)-1 3/4"x9 1/4" 2.1E LVL	3"
L-4		(2)-2x10's	1 1/2"

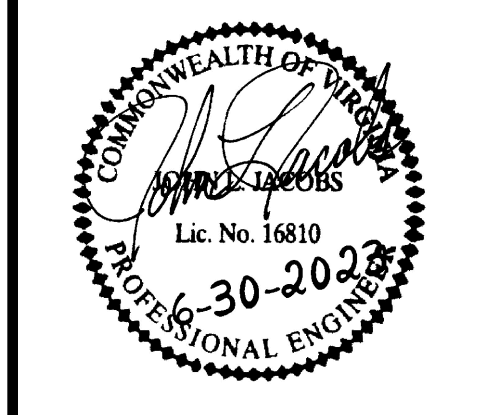
MASONRY CONTROL JOINT: ◀ C.J.
SEE 4 AND 5

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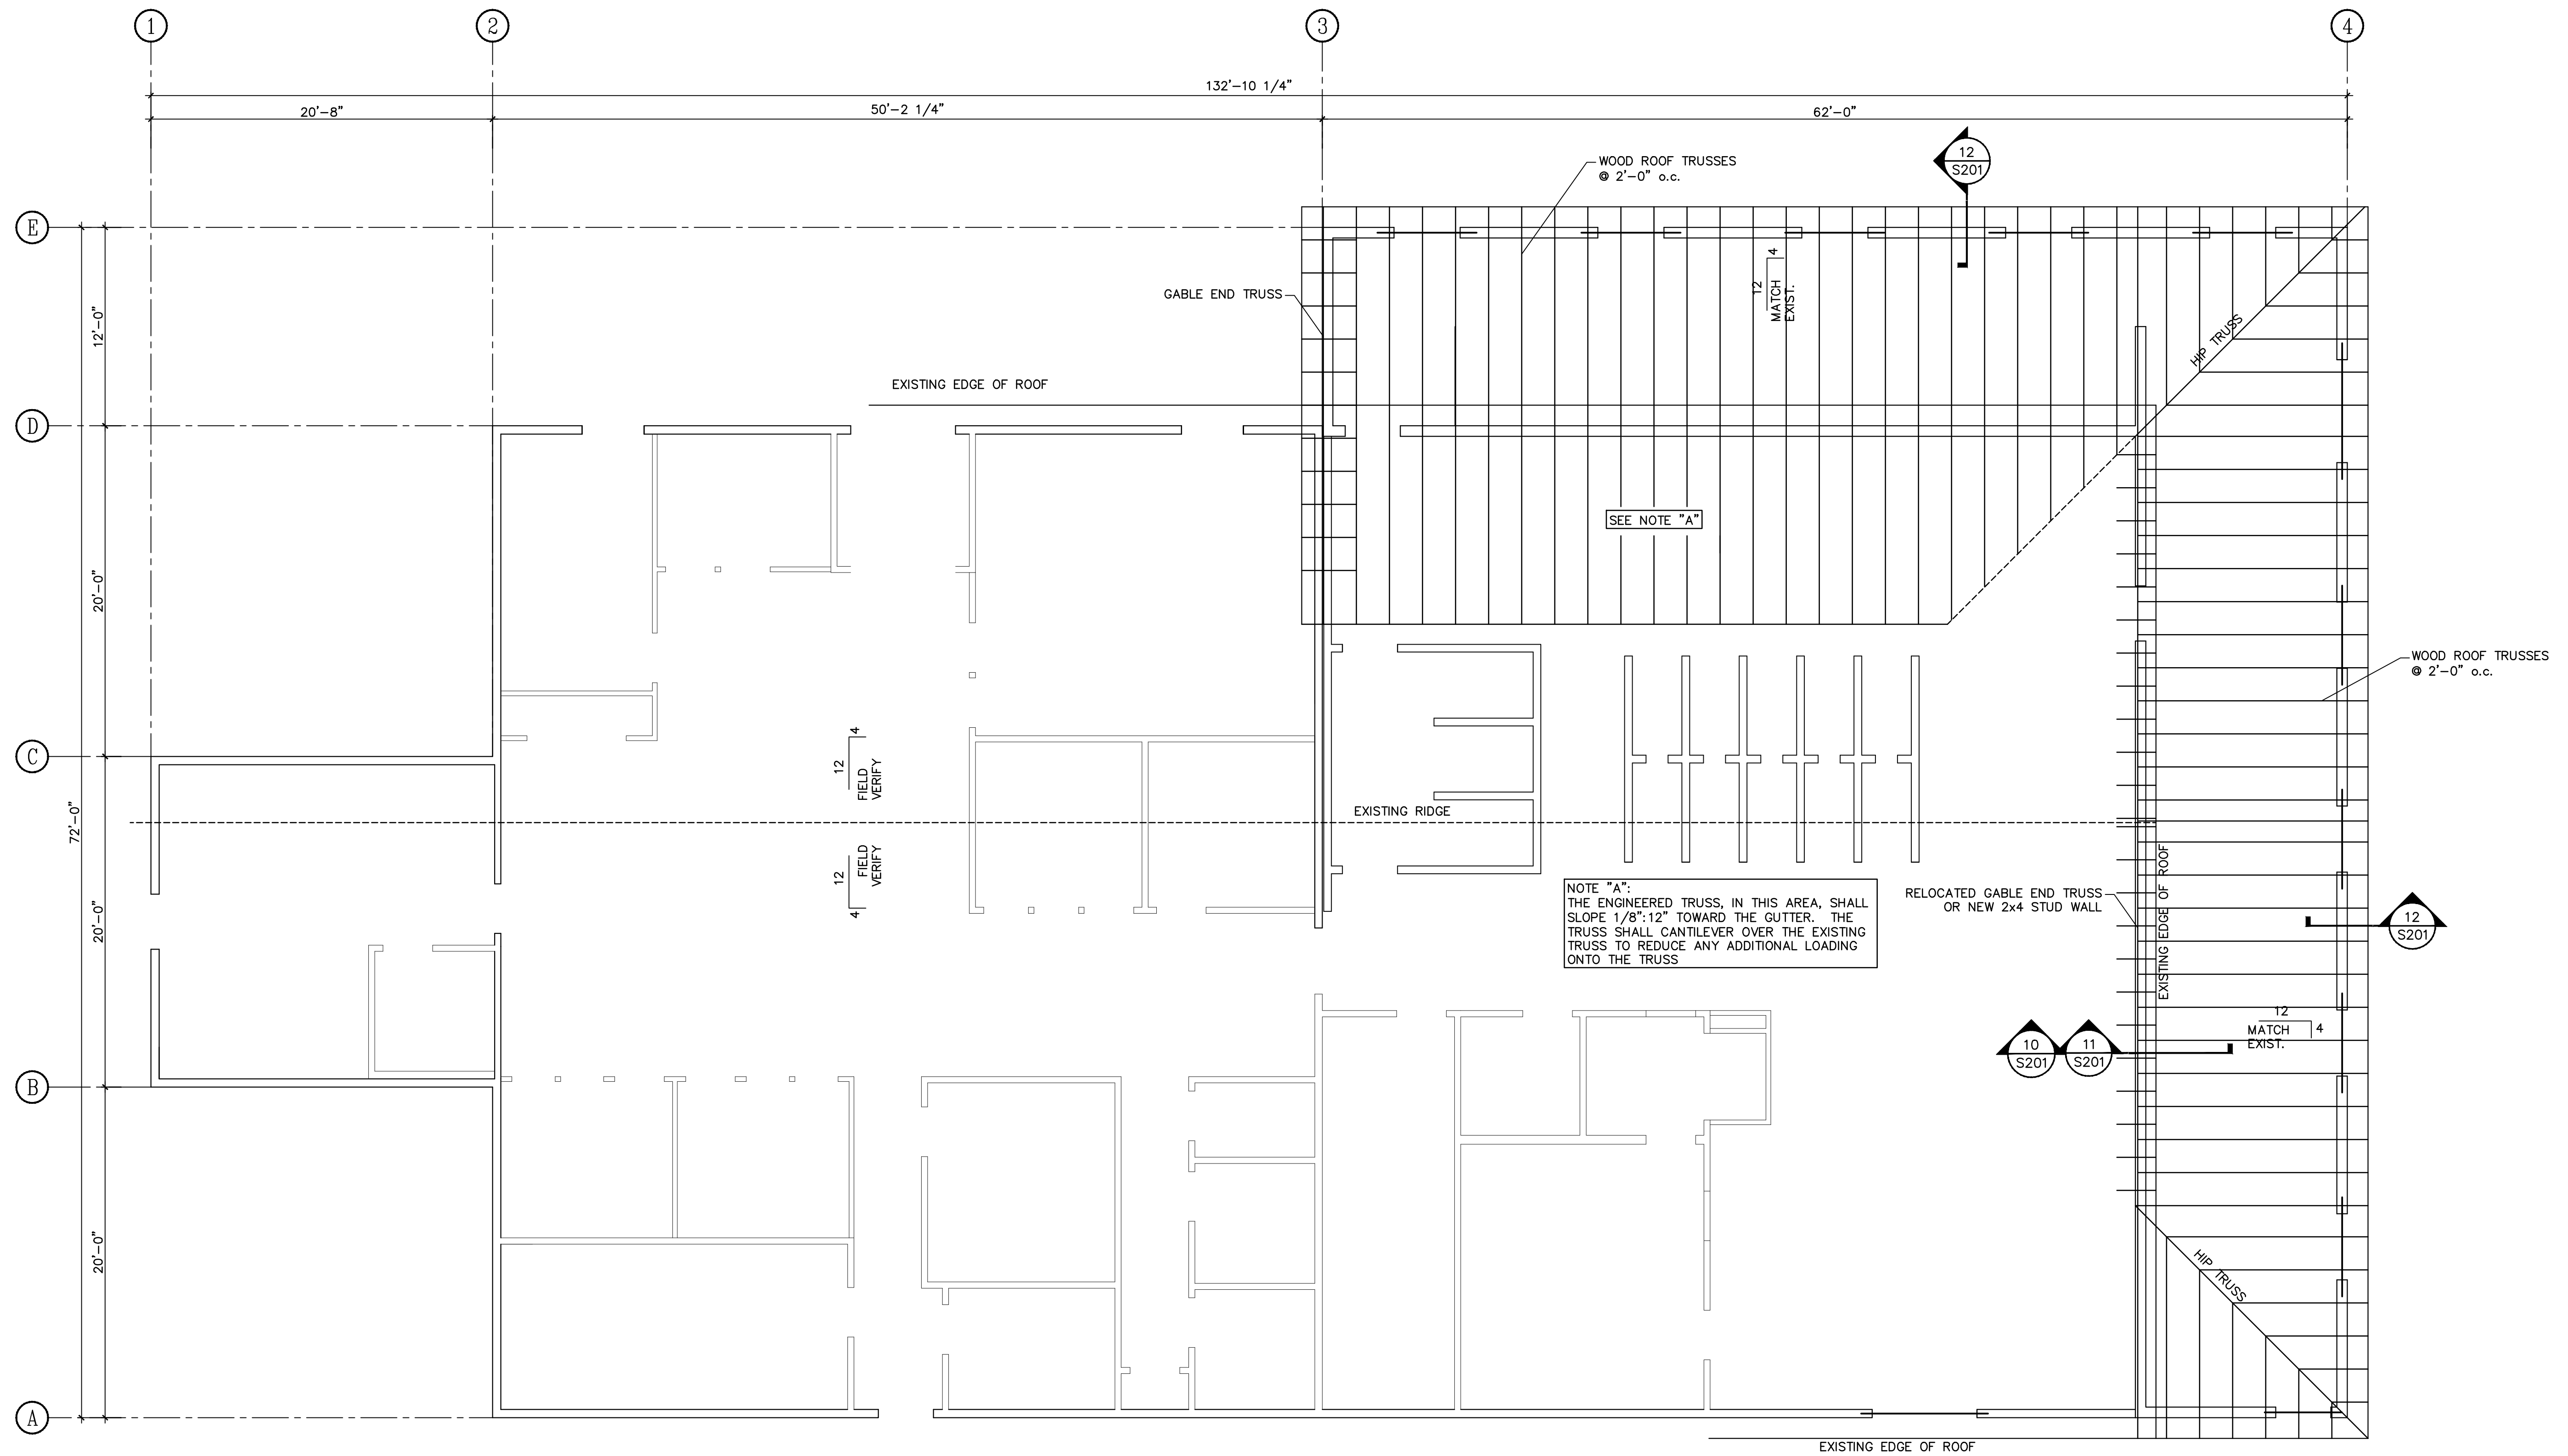
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 ANIMAL SHELTER
 15050 LEE HIGHWAY
 BRISTOL, VIRGINIA 24201

LINTEL PLAN




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SHEET:	S102
DRAWN BY	ST
CHECKED BY	JLJ
PROJECT NO.	
THE LANE GROUP INC.	

PLT DATE 8/18/2023
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1 ROOF FRAMING PLAN
 S103
 3/16" = 1'-0"

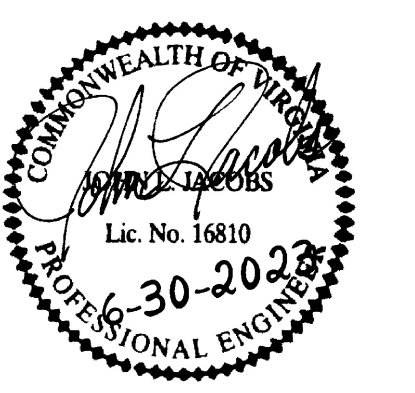ROOF FRAMING PLAN

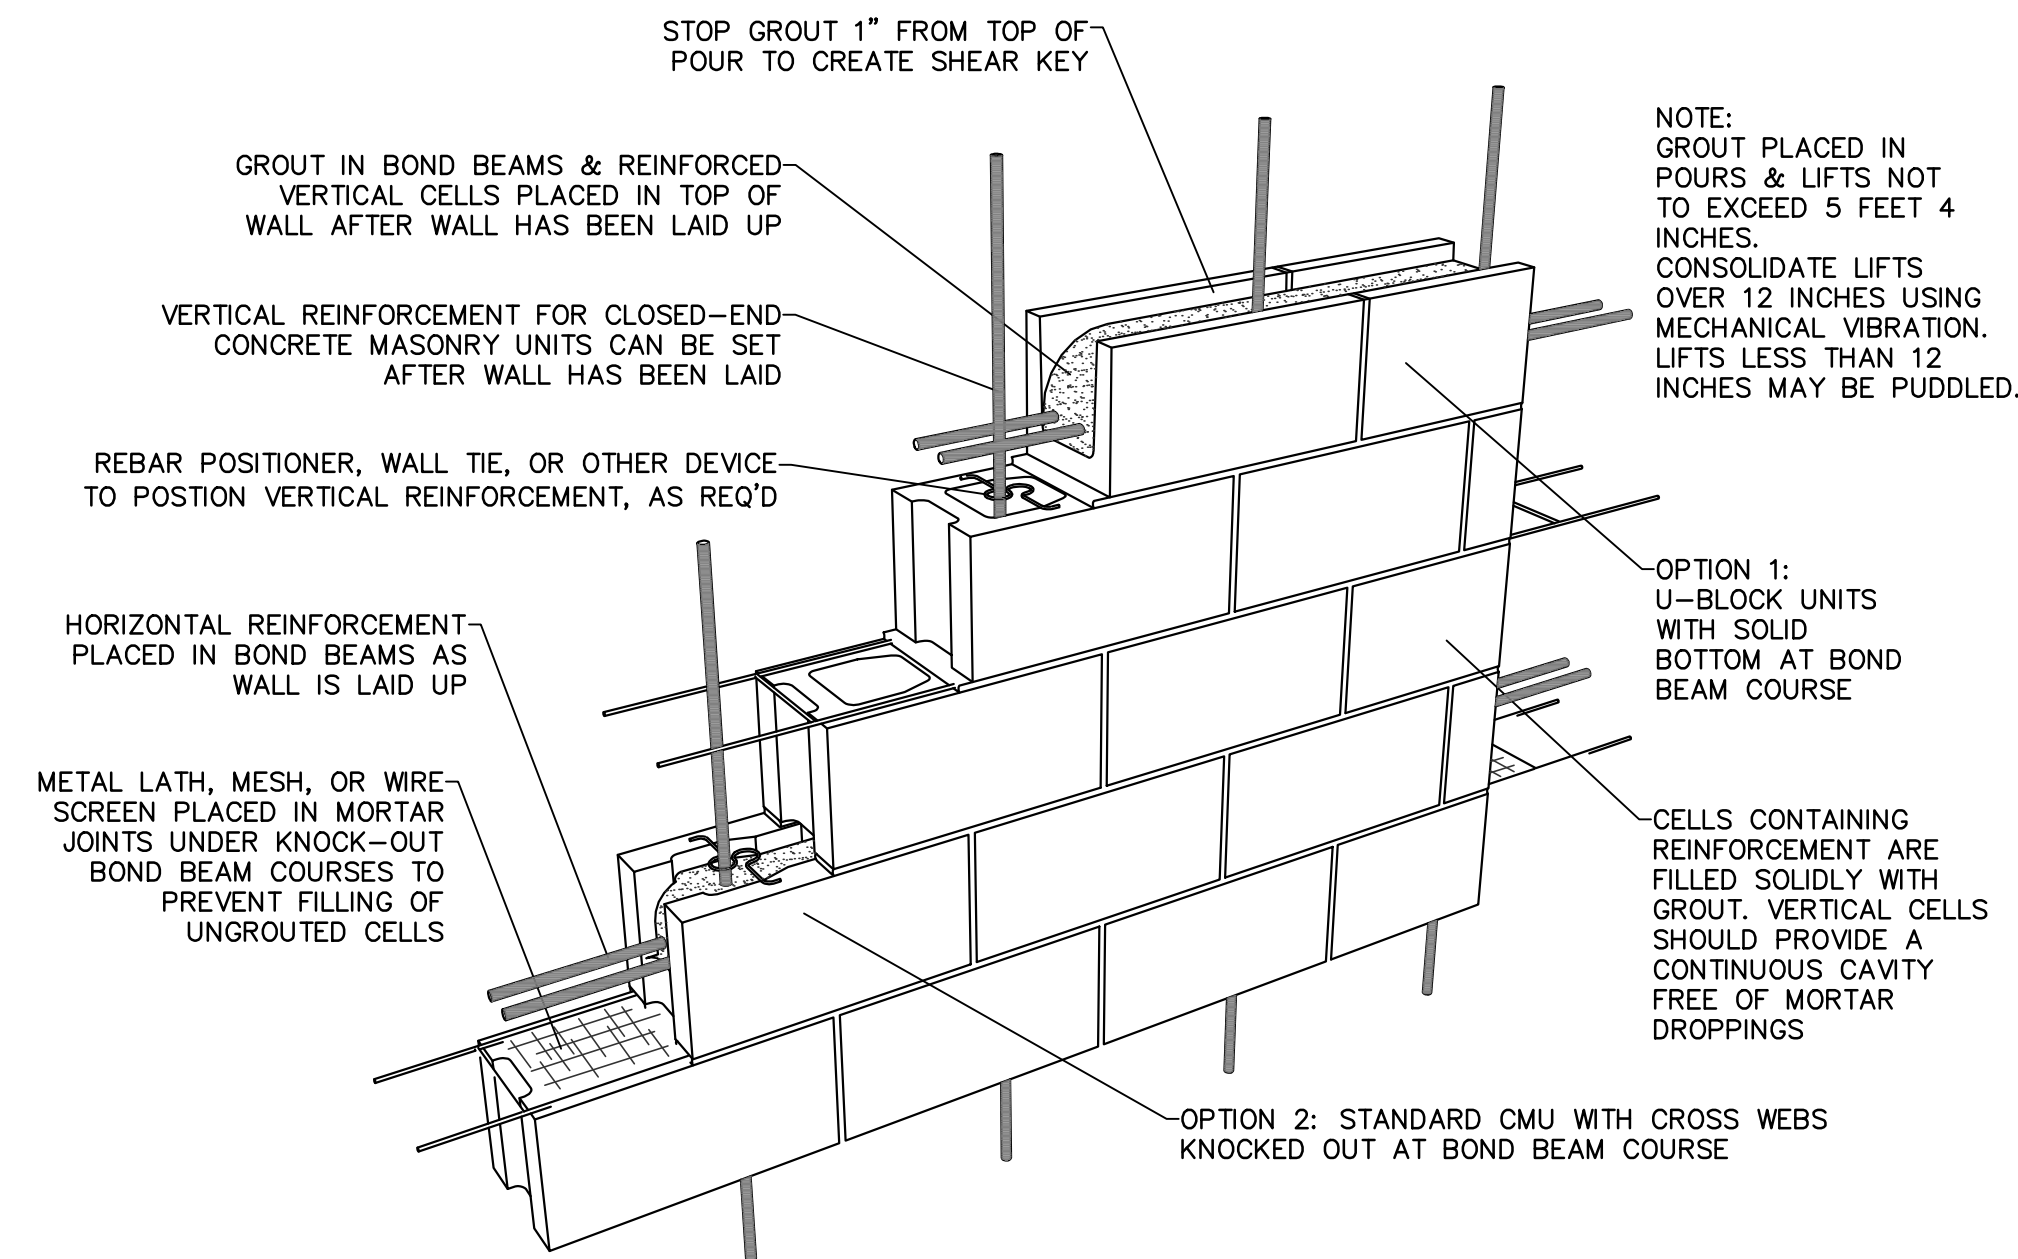


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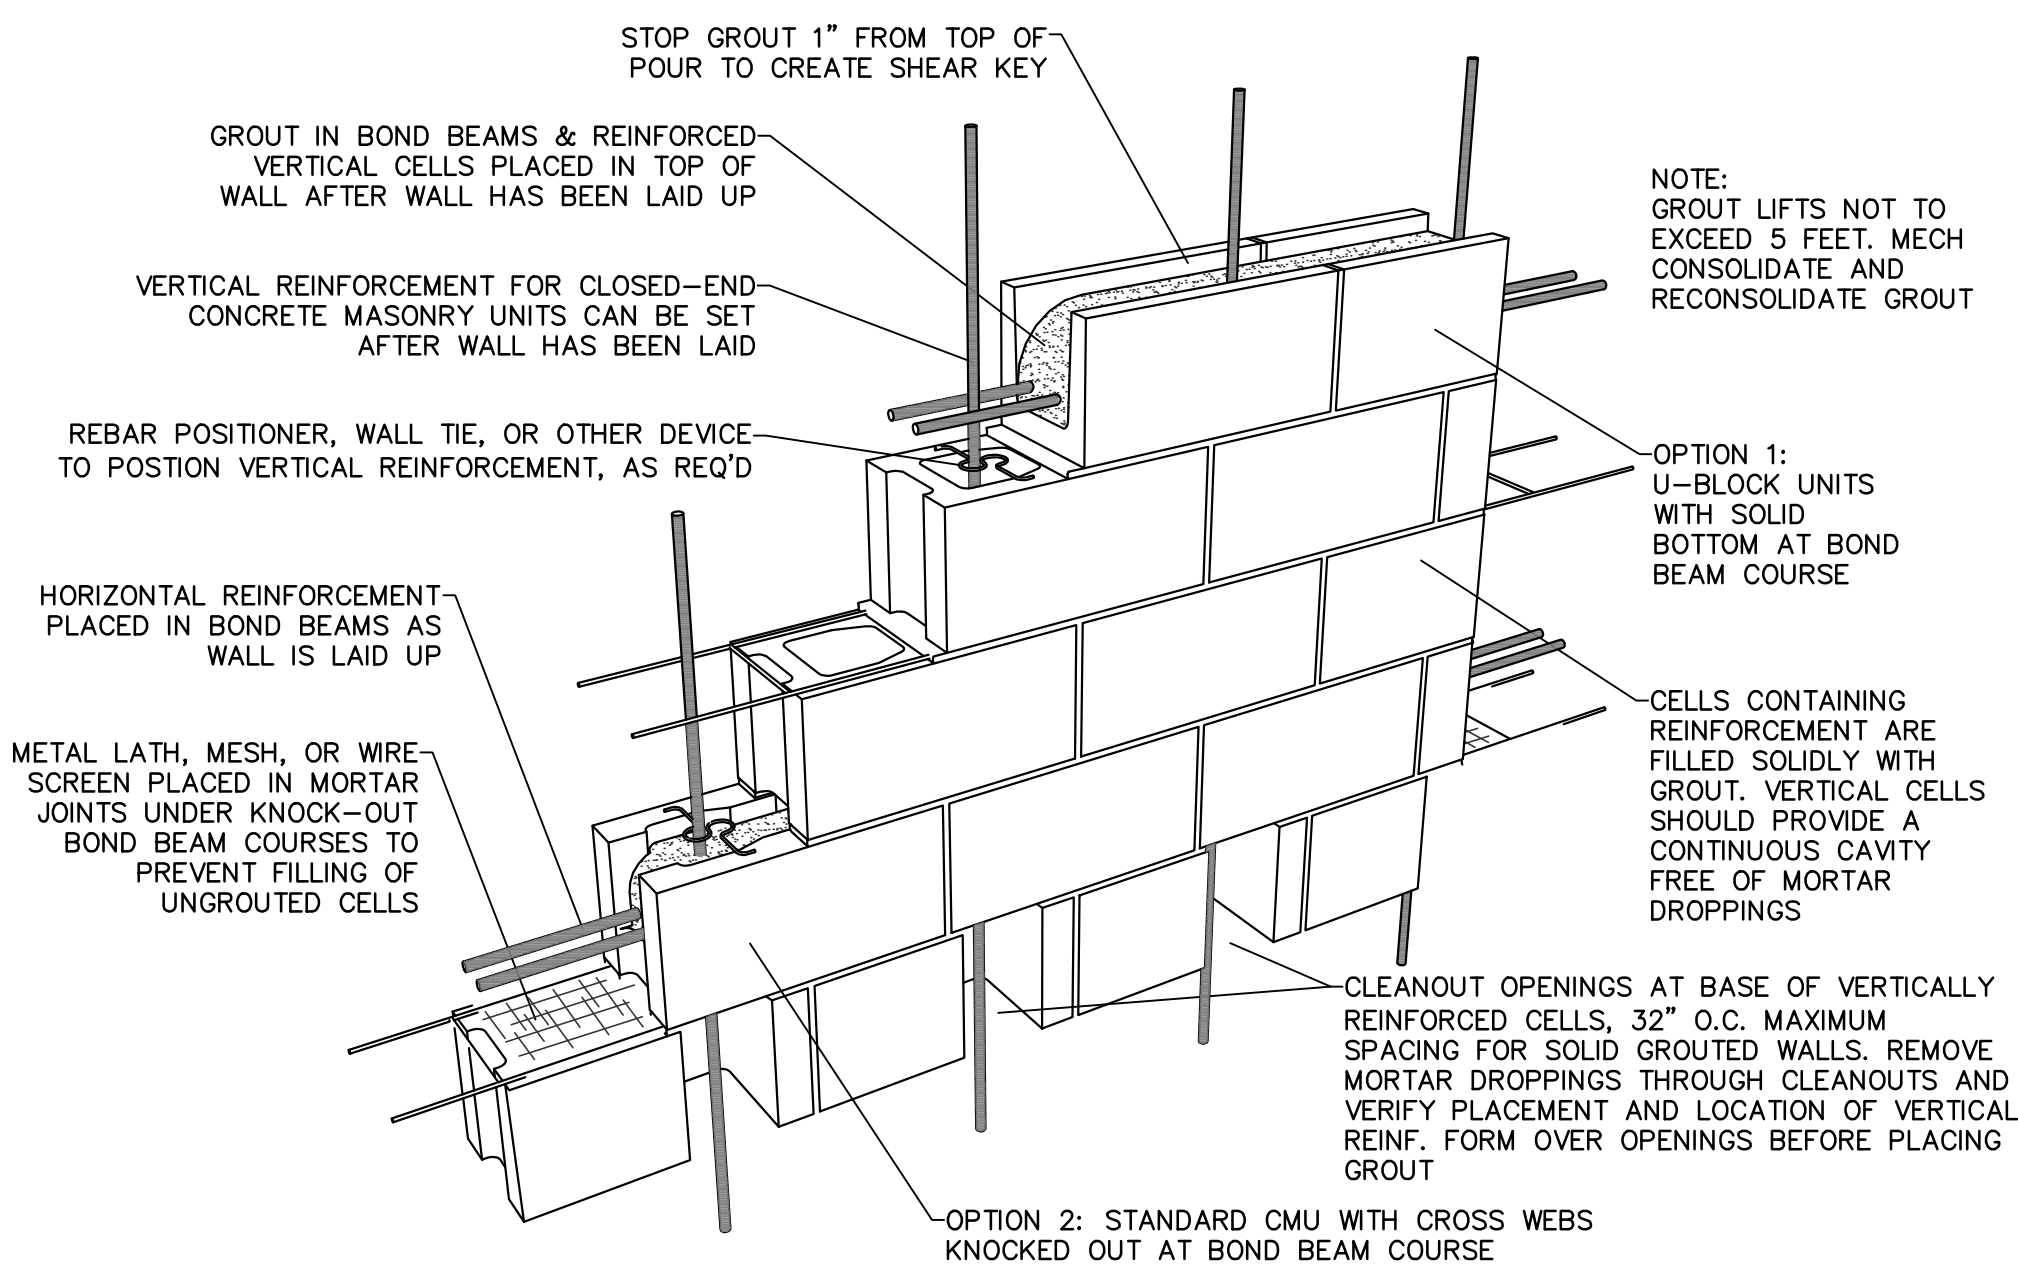
SHEET: S103	
DRAWN BY: ST	CHECKED BY: JLJ
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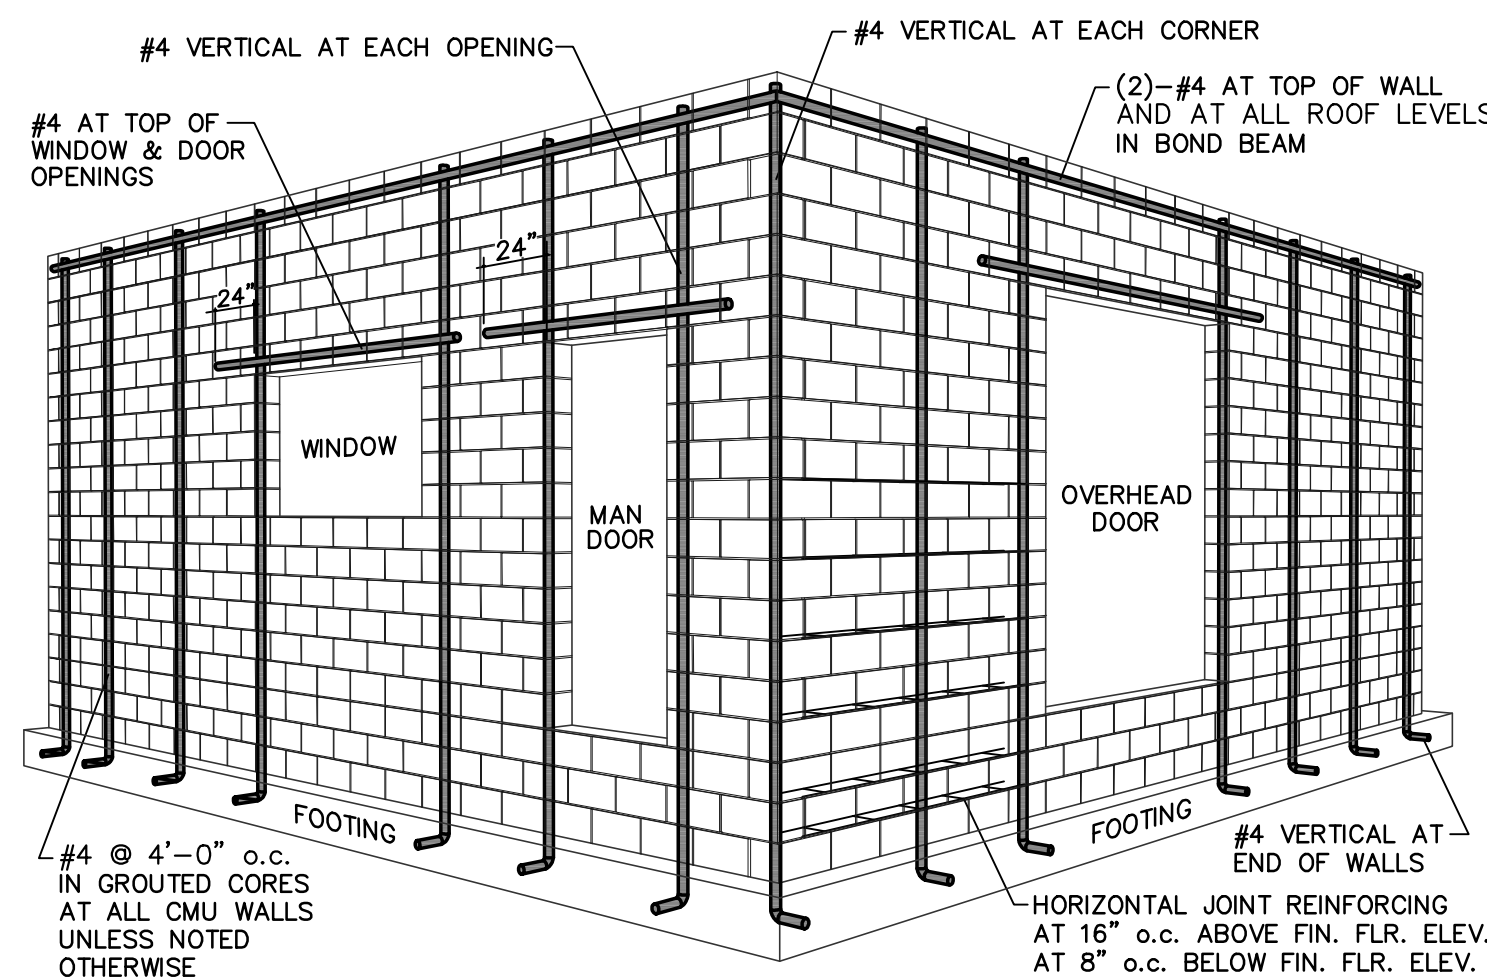
PLOT DATE 8/18/2023
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1 LOW LIFT GROUTING PROCEDURES
 S200 GROUT POUR HEIGHT < 5'-4" N.T.S.



2 HIGH LIFT GROUTING PROCEDURES
 S200 GROUT POUR HEIGHT > 5'-4" (Reference: TMS 402: Figure SC-20) N.T.S.



3 CMU WALL REINFORCING DETAIL
 S200 TYPICAL DETAIL N.T.S.

LAYOUT:

1. Before beginning work, Contractor shall verify all existing building horizontal and vertical dimensions.

GRADING NOTES:

- Asphalt and other unsuitable materials shall be stripped from the site a distance of 5 feet outside cuts, fills and building limits.
- Proofroll areas to receive fill, as well as final subgrade areas. Use dump truck weighing at least 20 tons. Any area that rut or pump shall be undercut to firm bearing soils and backfilled with well-compacted soil.
- Fill soil shall have a minimum dry unit density of 90 pounds per cubic foot, a maximum plasticity index (PI) of 30 or less and be free of topsoil, debris or trash. Place soil fill in 8" loose lifts to 98 percent of the standard proctor maximum dry density within plus or minus two percentage points of its optimum moisture content in accordance with ASTM D698. Test at rate of 1 test per 2500 sq. ft. per lift.

CONCRETE NOTES:

- All foundation and slab-on-grade concrete shall be 3000 PSI @ 28 days (W/C<49). Exterior concrete shall be 4000 PSI @ 28 days (W/C<46). All exterior concrete shall be air entrained (6 percent). Fly ash shall be limited to 25 percent of cementitious materials. Slump: 4-6". Concrete mix shall not exceed 90 degrees at time of placement.
- Reinforcing steel shall be A615, grade 60.
Concrete cover: Foundations - 3"
Slabs - 1"
- All work shall be performed in accordance with ACI 301 and 117.
- Tool all exposed corners.
- Floor surfaces shall receive steel trowel finish. Exterior flat surfaces shall receive light broom finish.
- Reinforcement at foundation steps shall be continuous with 24" bar laps.
- Concrete shall be tested in accordance with ACI 318:
 - At least once a day for each strength used that day.
 - At least once for each 150 e.y. of concrete.
 - At least once for each 5,000 sq. ft. of surface area of slabs or walls.
Four (4) cylinders shall be taken for each test. Cylinders shall be tested at 7 and 28 days. Results shall be reported to Designer. Acceptance shall be in accordance with ACI 318.
- Vapor barrier shall be 15 mils thick, tensile strength >45 lb/inch, puncture resistance = 2200 grams, with taped edges.

MASONRY NOTES:

- One core of concrete masonry units at exterior building corners shall be filled with grout from the foundation to the bond beam. Core shall have 1 - #5 rebar full depth.
- Cores below lintel and beam bearing points shall be grouted from foundation to top of wall. Each core shall have 1 - #5 rebar full depth.
- Roof levels and top of all masonry walls shall have reinforced, grouted bond beam with 2 - #4 continuous. Reinforcement shall be continuous (lapped 20") at corners and intersections.
- Fully grout all foundation block cores located below slab-on-grade elevation.
- Block cores at all wall intersections shall be filled with grout and 1 - #4 rebar from foundation to bond beam. One block core in each wall at intersection shall be filled.
- Install horizontal reinforcing at 16" centers full height of wall.
- All masonry grout shall be portland cement grout with 3/8" aggregate, 2,000 psi minimum compressive strength, 8"-11" slump.
- Install vertical control joints at 25' - 0" centers max. Joints shall extend from foundation to top of wall.
- Masonry net area compressive strength (Fm) = 1500 psi.
- All block mortar shall be Type M or S.
- Load bearing and exterior intersecting walls shall be bonded in an overlapping masonry bonding pattern or by steel connectors (1/4x1 1/2x24 W/2" bent-up ends) at 4'-0" centers. Horizontal joint reinforcing shall be continuous through the intersection.
- Non-load bearing intersecting walls shall be bonded with continuous joint reinforcing or 1/4" mesh galvanized hardware cloth at 16" centers.
- 6" CMU walls shall be vertically reinforced at end of walls with 2-#4 rebars in grouted cores. One #4 shall be located at all wall intersections. A vertical #4 rebar shall also be placed at 4'-0" centers along length of wall. All vertical rebars shall be epoxied into the concrete slab to a depth of 3 1/2".

WOOD TRUSSES:

- Truss shop drawings shall be submitted showing all dimensions and details. Drawings shall be stamped by a registered engineer certified to practice in the project state. Drawings shall include permanent and construction bracing recommendations.
- All roof trusses shall be designed to carry the following loads:
 - Top chord live load: 30 psf
 - Top chord dead load: 10 psf
 - Bottom chord dead load: 10 psf
 Roof or attic supported mechanical units. See Mechanical drawings for weight and locations.
 Spacing: 24 inches
 Live Load Deflection: L/360
 Wind loads shall be calculated in accordance with ASCE7-16 Figures 30.4B and 30-8.2.
- Diagonal and lateral bracing shall be installed in accordance with truss manufacturer's recommendations and these drawings.
- Shop drawings shall include setting plan detailing locations of all trusses.
- Roof trusses shall be connected to top plate of wall with the following Simpson, or equal, ties:
 - up to 320 lbs. uplift: H3
 - up to 535 lbs. uplift: H2.5AZ
 - up to 600 lbs. uplift: 2 ea. SDWC15600 screws
 - up to 850 lbs. uplift: H10
 850 lbs. uplift and above: H14
 Actual uplift loads shall be determined by truss manufacturer and shall be stated on shop drawings.
- Jack trusses shall be connected to girder truss with Simpson, or equal, joist hangers furnished by truss manufacturer.
- Roof sheathing shall be 19/32" or 5/8" APA Rated sheathing 40/20, Exposure 1, minimum 2 span staggered pattern, 4'x8" sheets with 8d common nails at 6" centers around perimeter and 12" centers at intermediate framing members. Use pliclips at mid-span.
- Shop drawings shall be submitted, by the Contractor after shop drawing approval, to the Building Official for review. (IBC 2303.4.1.1)

WOOD FRAMED CONSTRUCTION:


- Sill plates in contact with steel, masonry or concrete shall be #2 SYP pressure treated. All 1/2" bolts anchoring these treated sill plates shall be hot-dipped galvanized.
- Interior non-load-bearing wall sill plates shall be anchored to floor with power driven pins at 24" centers.
- At beam bearing points, install a number of 2x studs equal to the number of members in the built-up beam. Provide a minimum of 3-2x studs at bearing points of LVL beams. Built-up columns shall be nailed together with 16d nails at 20" centers, full height of the column.
- Double plates shall lap a minimum of 4'-0". Laps shall be located over studs.
- Bored holes in 2x4 studs shall not exceed 1 3/8" for load-bearing walls and 2 1/8" for non-load-bearing walls. Bored holes in 2x6 studs shall not exceed 2 1/8" for load-bearing walls and 3 1/4" for non-load-bearing walls. Bored holes shall be centered in the stud.
- All 2x lumber (shall conform to dressed sizes in Standard PS20) shown on drawings shall be #2 SPF or #2 SYP or better with moisture content less than 19 percent.
- All exterior walls shall be sheathed with 5/8" APA rated plywood sheathing. Exposure 1, T1-11.
- Plywood sheathing shall be nailed to outside face of pressure treated furring strips with 8d nails at 4" centers at all plywood edges and at 12" centers at intermediate supports.

DESIGN LOADS:


2018 Virginia Statewide Uniform Building Code & ASCE 7-16
 Roof Live Load: 30 psf
 Risk category: II
 Ultimate Design Wind Speed: 107 mph
 Nominal Design Wind Speed: 83 mph
 Exposure Category: B
 Internal pressure coefficients: +/-0.18
 Components and cladding: In accordance with ASCE 7-16 Chapter 30.
 Snow Load (ground): 15 psf Importance factor: 1.0
 (flat roof): 10.5 psf
 Snow exposure factor: 1.0
 Thermal factor: 1.0
 100 Year, Rainfall: 2.62 inches/hour
 Handrailings: 200 lb. horiz. or vert. load
 or: 50 plf horiz. or vert.
 Soil Bearing Pressure: 2000 psf (assumed)

SEISMIC DESIGN DATA:

Importance factor	1.0
Risk category	II
Spectral response acceleration, Ss	.27
Spectral response acceleration, S1	.08
Site class	D
Spectral response coefficient, SDS	.29
Spectral response coefficient, SD1	.135
Seismic design category	C
Basic seismic-force resisting system	Ordinary reinforced masonry shear walls
Response modification factor, R	25
Seismic response coefficient, Cs	.145
Design base shear (kips) (ASD)	8.0
Analysis procedure	Equivalent Lateral Force Procedure

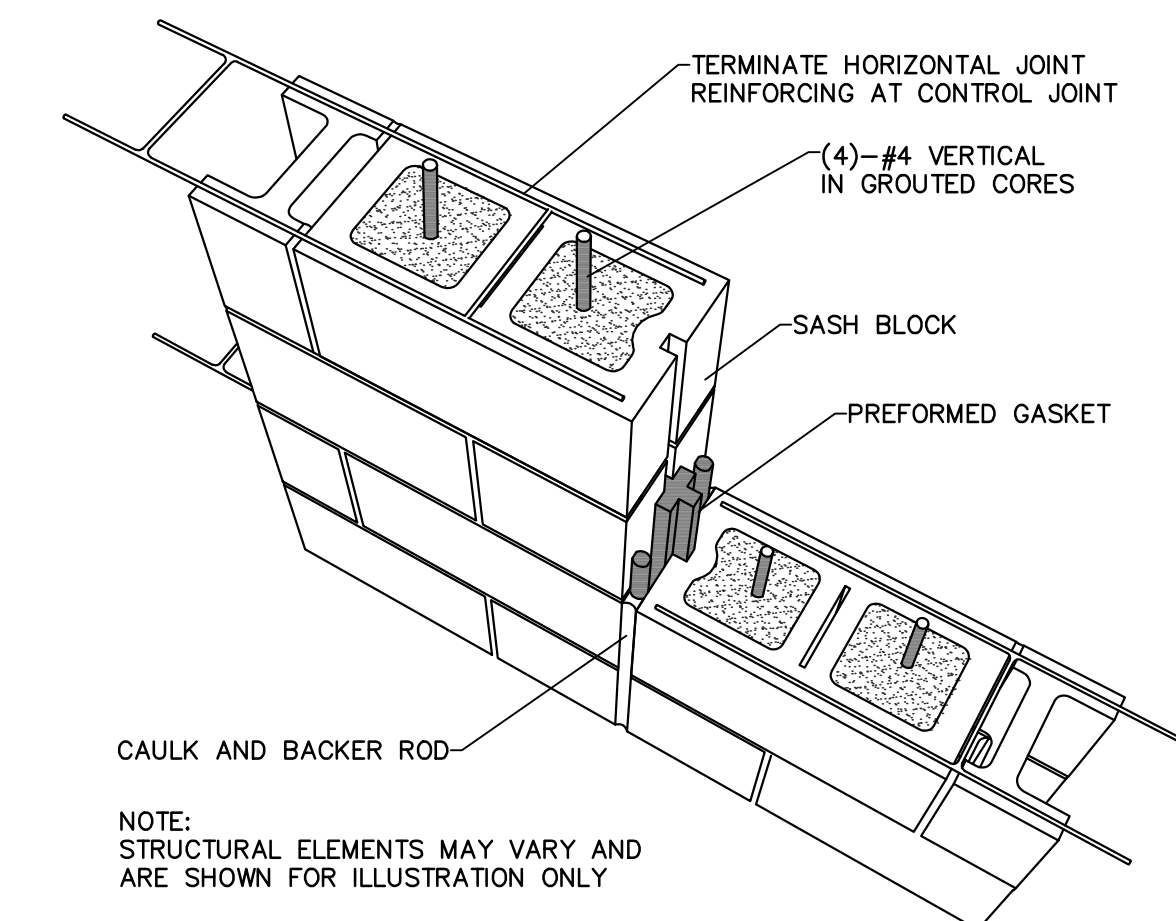

4 CONTROL JOINT
 S200 CMU WALL N.T.S.

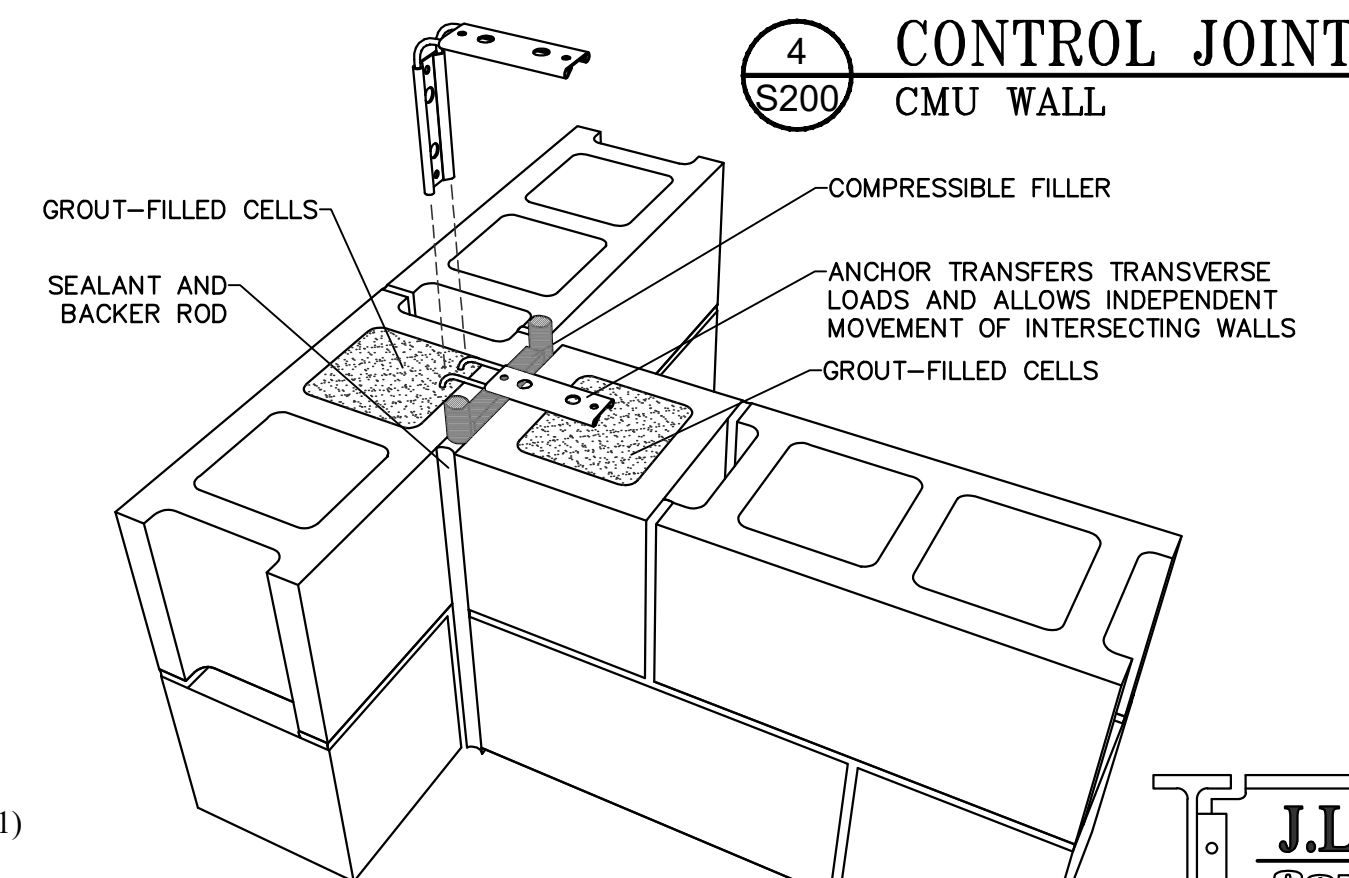

5 CONTROL JOINT
 S200 AT CMU WALL JOIN N.T.S.

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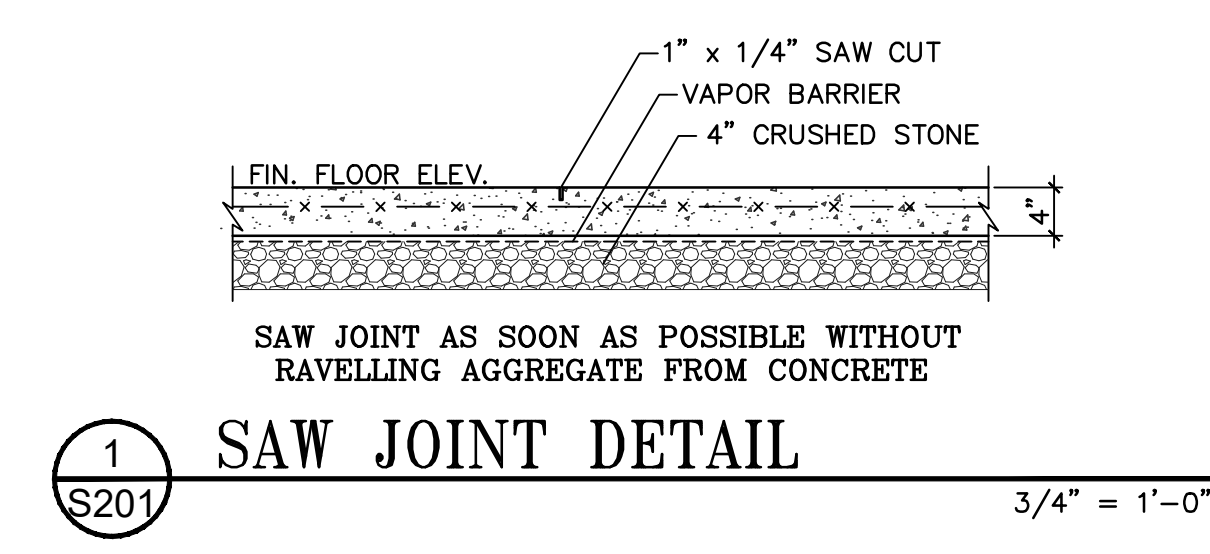
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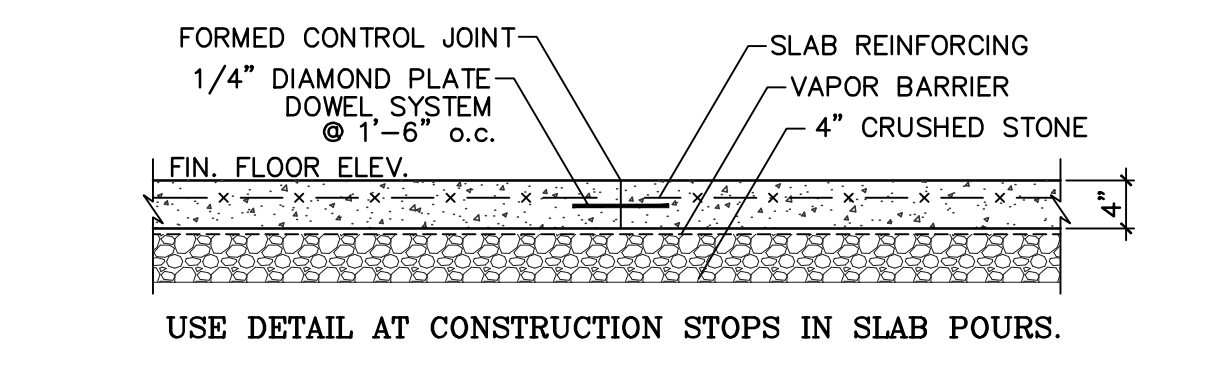
STRUCTURAL NOTES

COMMONWEALTH OF VIRGINIA
 PROFESSIONAL ENGINEER
 License No. 16810
 3-30-2023

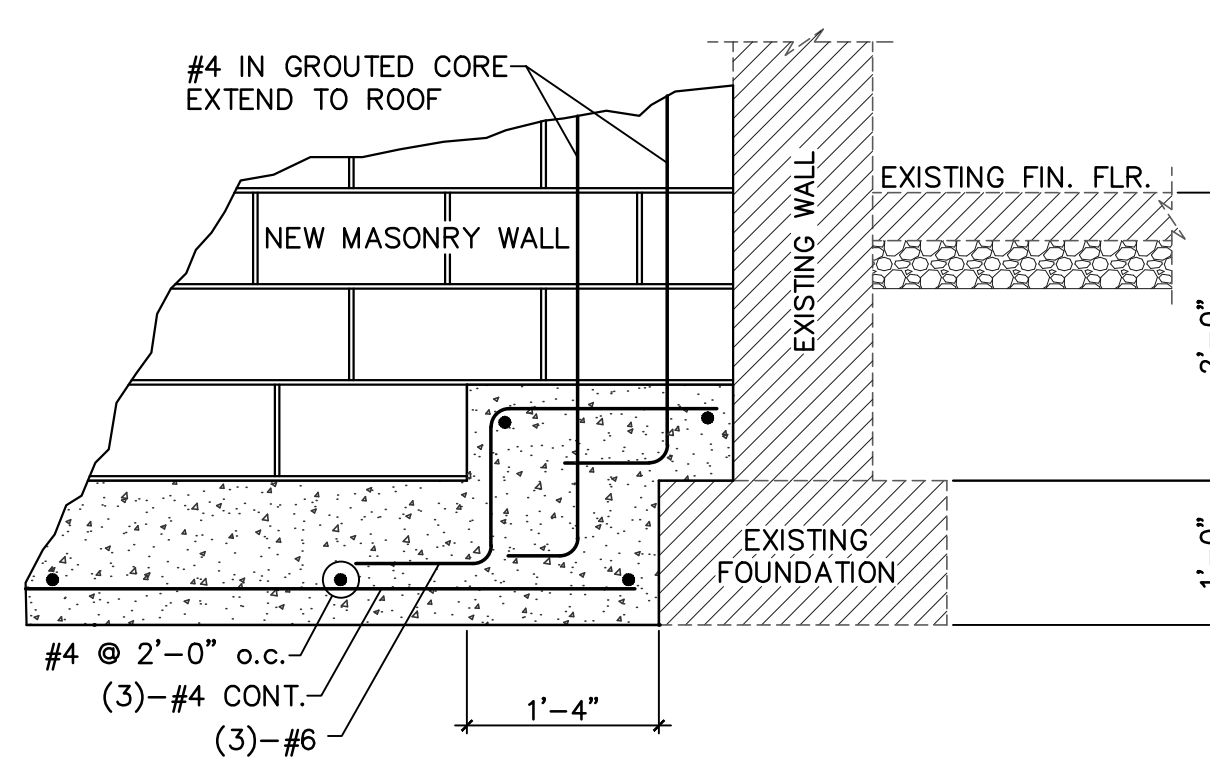
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CHECKED BY:	JLJ
PROJECT NO.	
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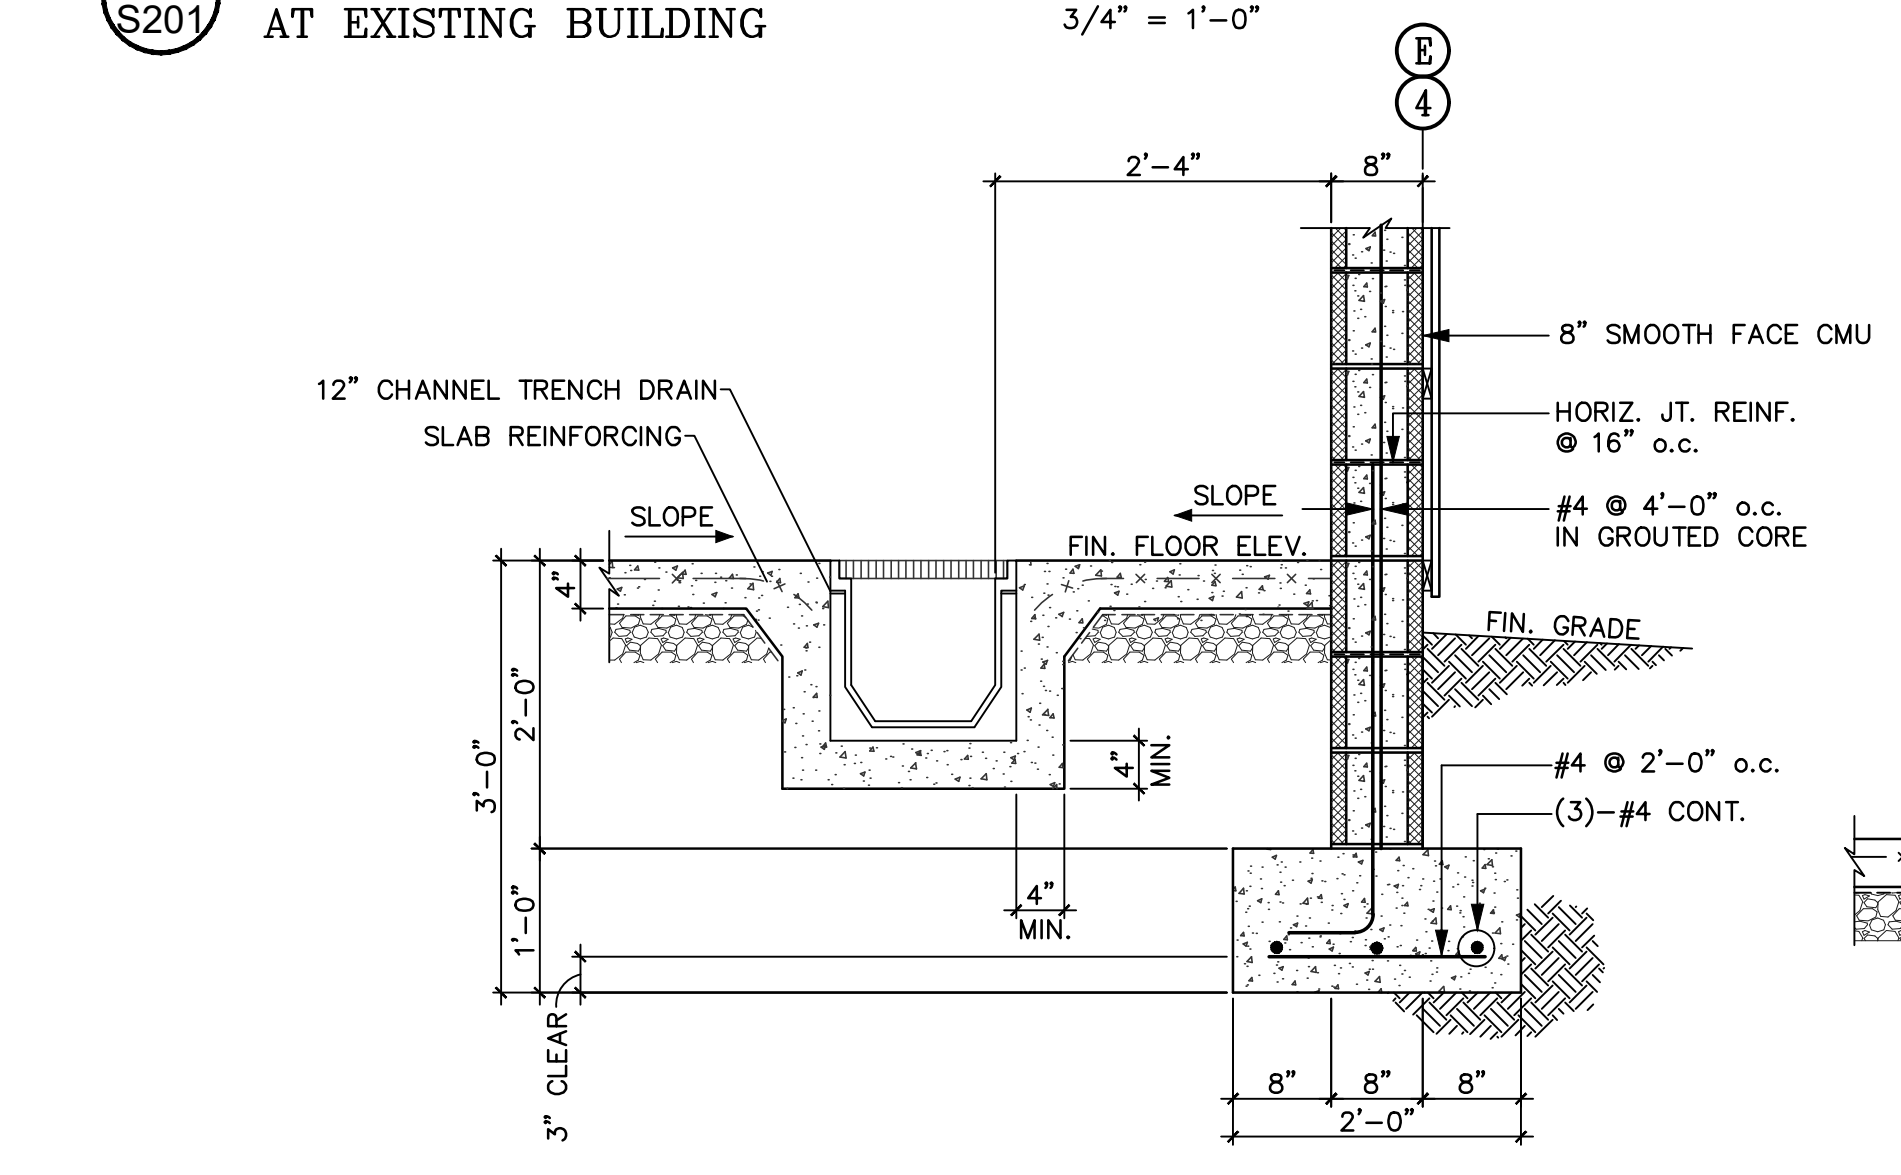
1 SAW JOINT DETAIL
S201 3/4" = 1'-0"




2 CONSTRUCTION JOINT DETAIL
S201 3/4" = 1'-0"




5 FOUNDATION WALL SECTION AT EXISTING BUILDING
S201 3/4" = 1'-0"



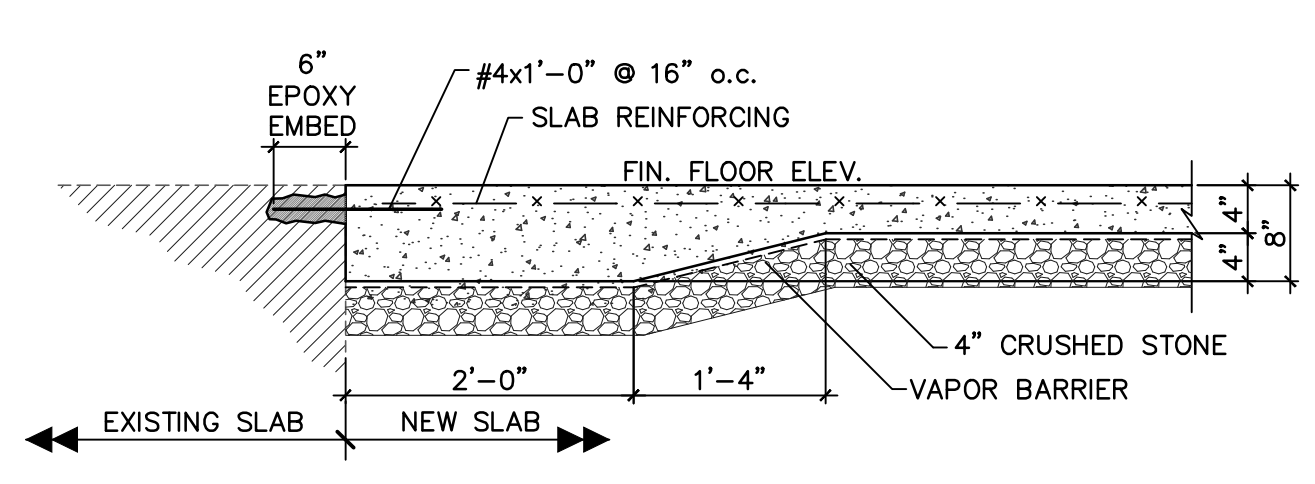
8 FOUNDATION WALL SECTION EXTERIOR MASONRY WALL
S201 3/4" = 1'-0"



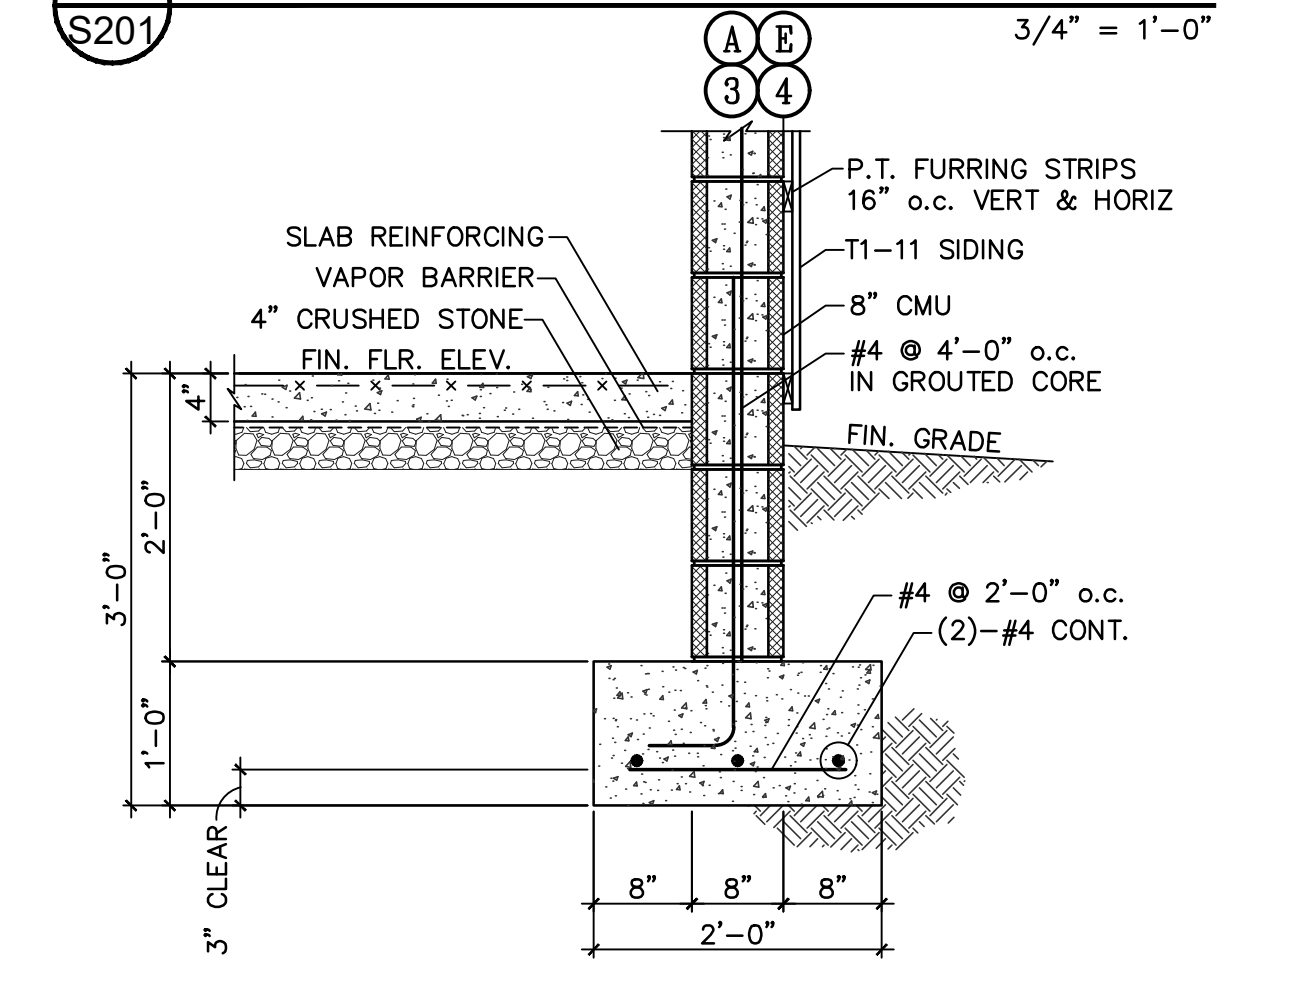
3 SLAB AT EXISTING BUILDING
S201 3/4" = 1'-0"



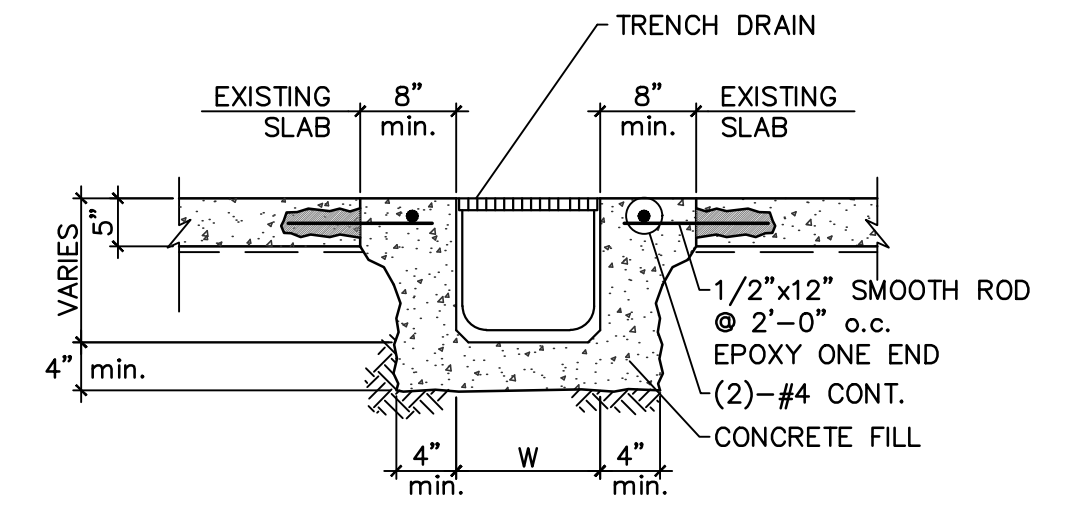
6 FOUNDATION WALL SECTION
S201 3/4" = 1'-0"



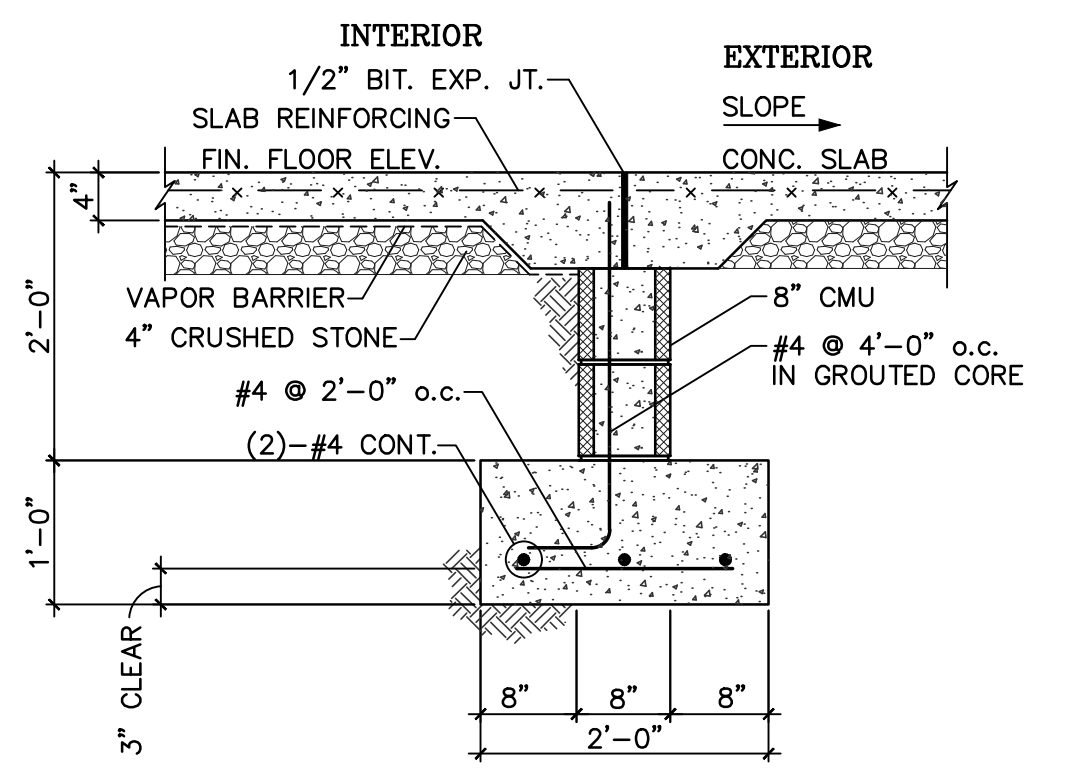
4 TRENCH DRAIN SECTION
S201 3/4" = 1'-0"



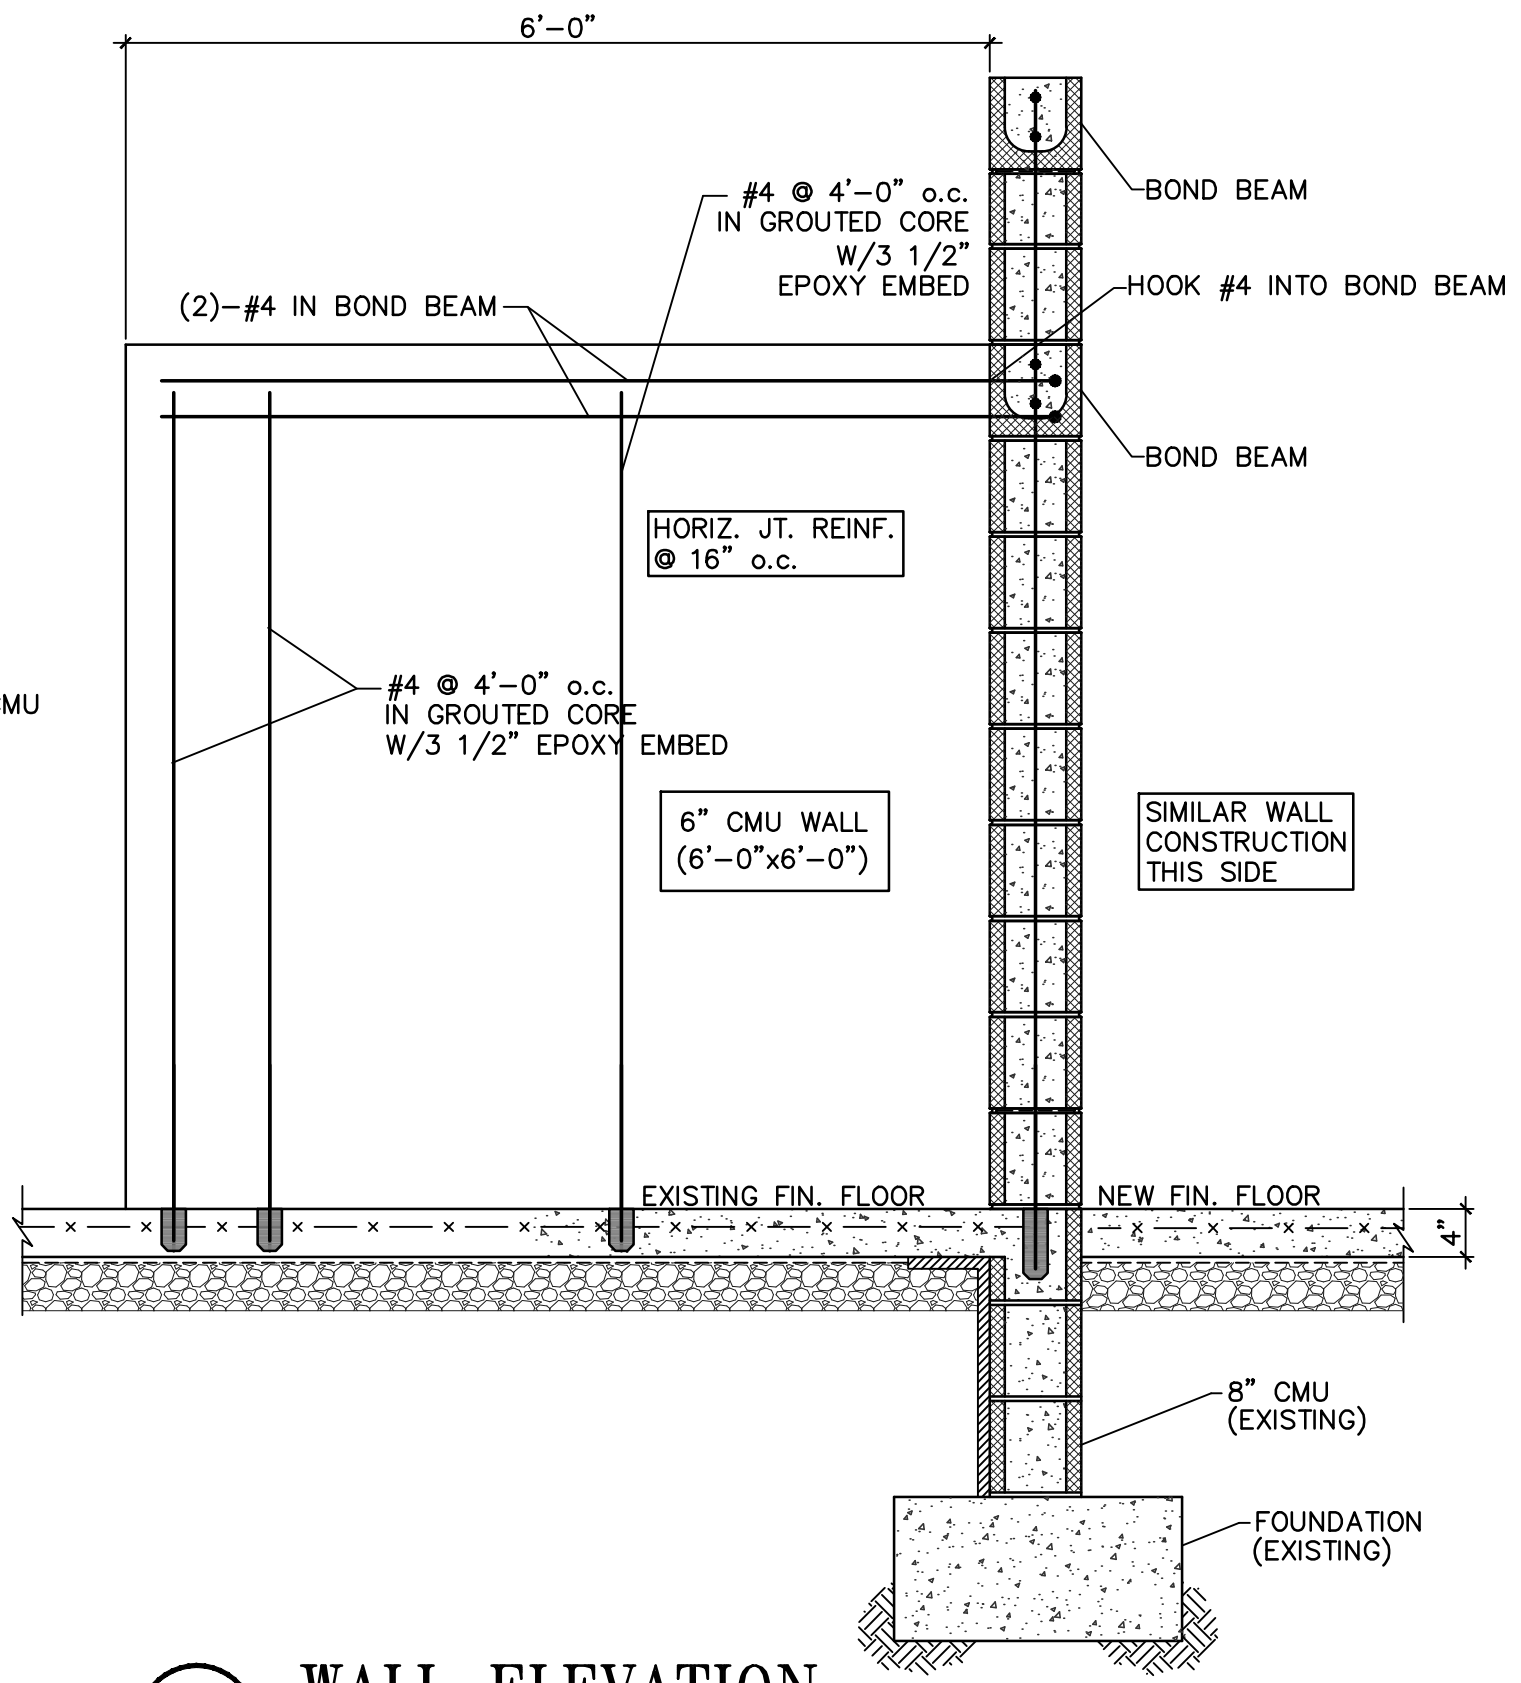
7 FOUNDATION WALL DETAIL AT DOOR OPENINGS
S201 3/4" = 1'-0"



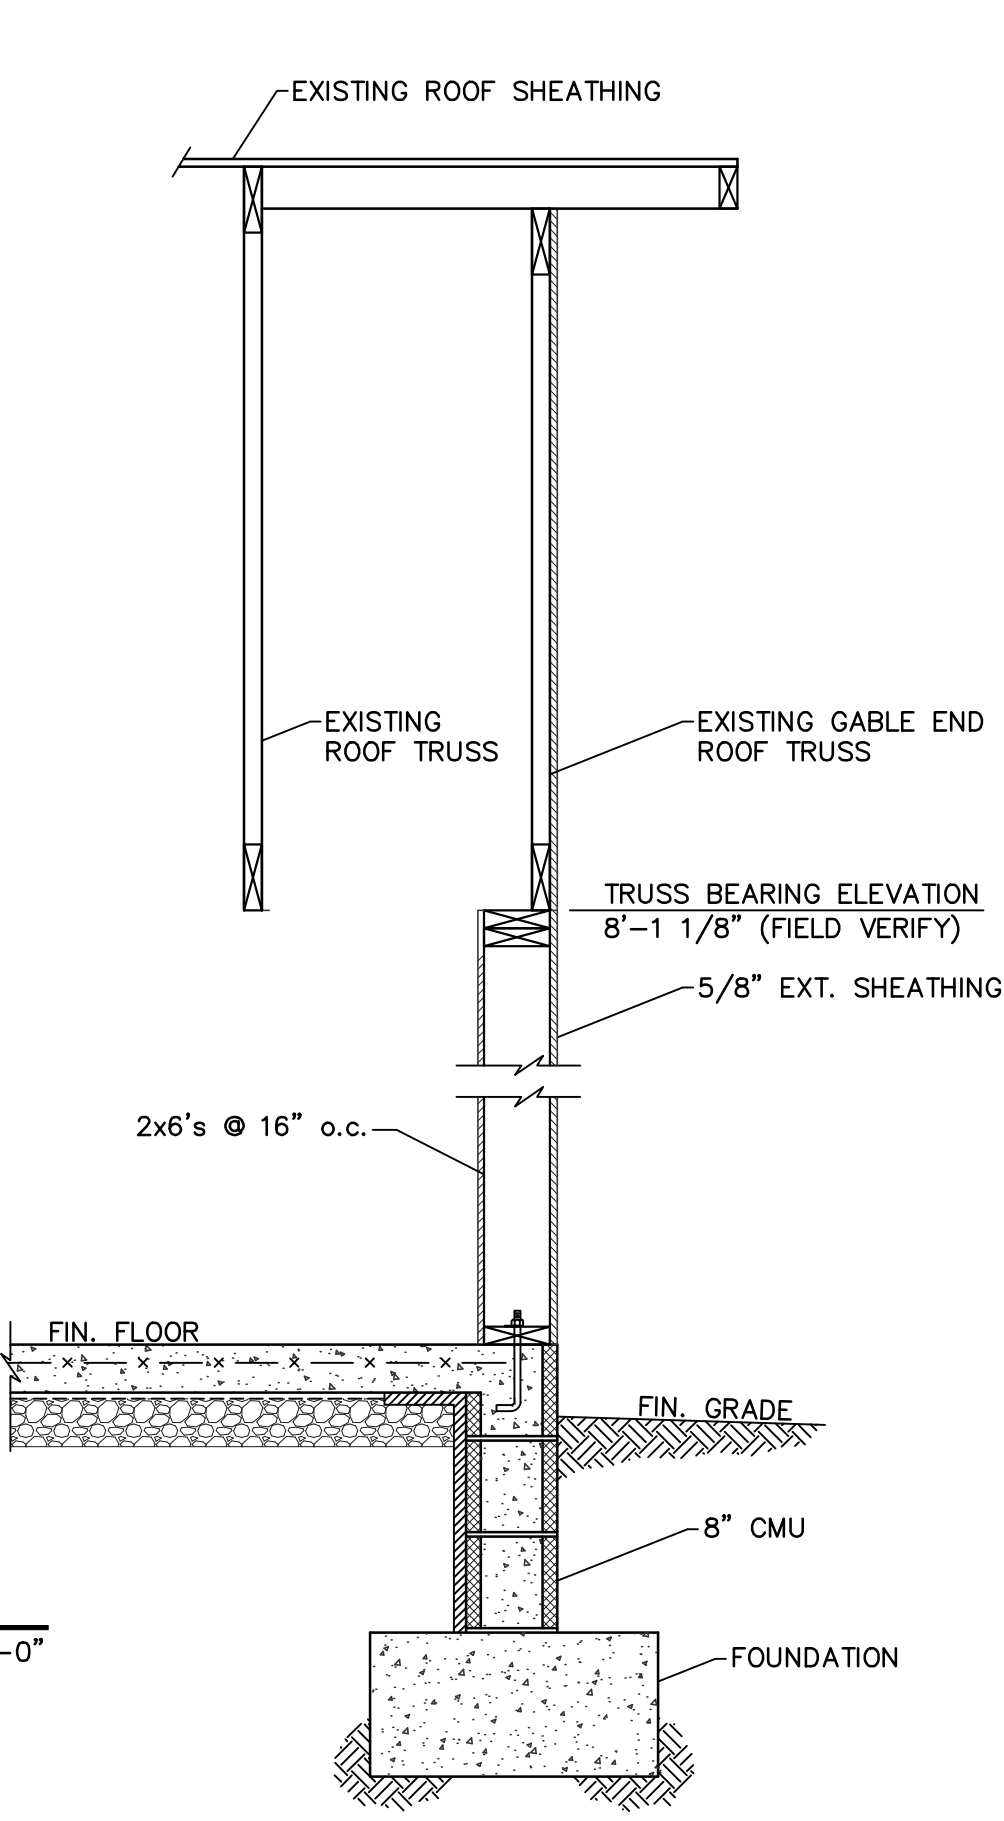
9 WALL ELEVATION KENNEL SEPARATION WALL
S201 3/4" = 1'-0"



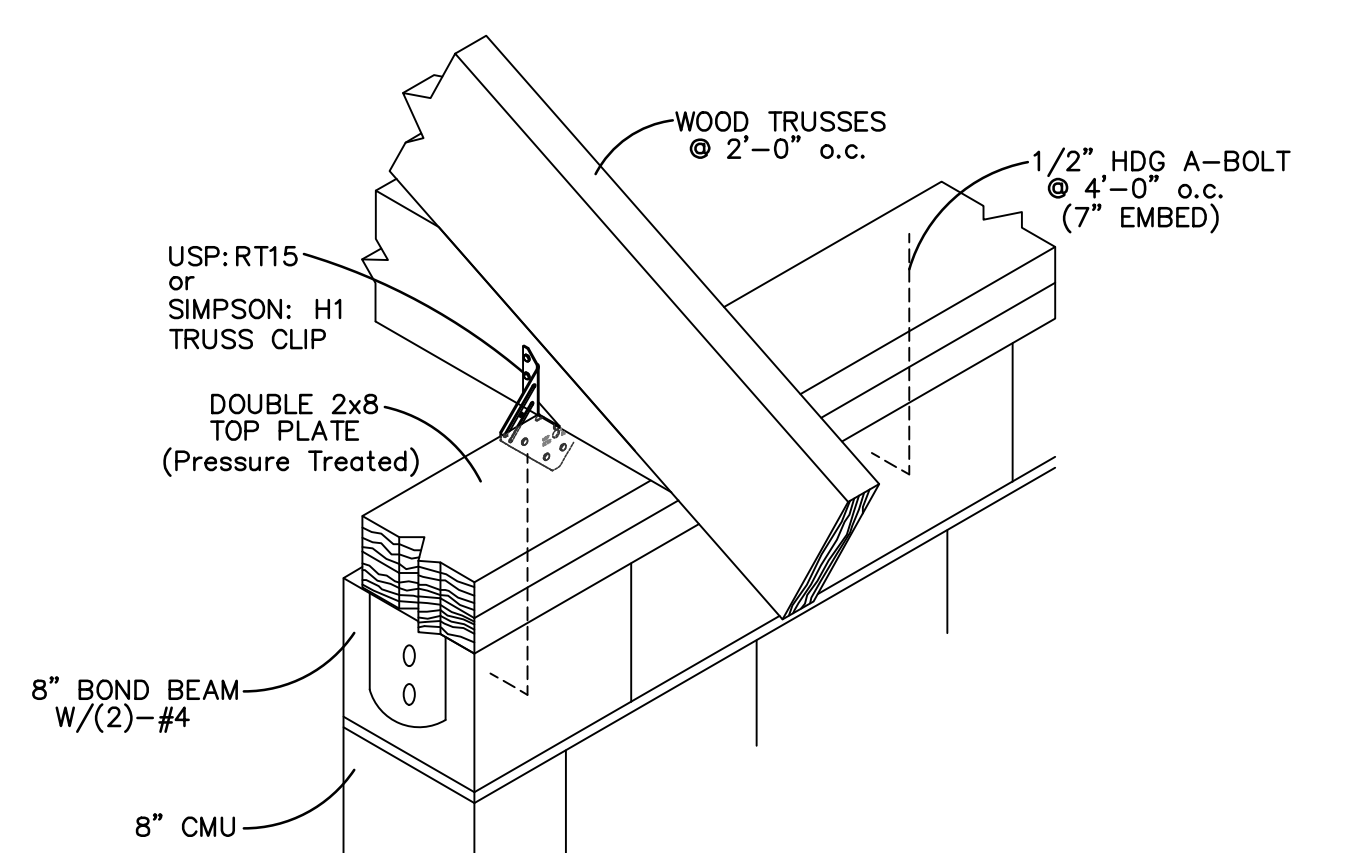
10 WALL SECTION EXISTING
S201 3/4" = 1'-0"



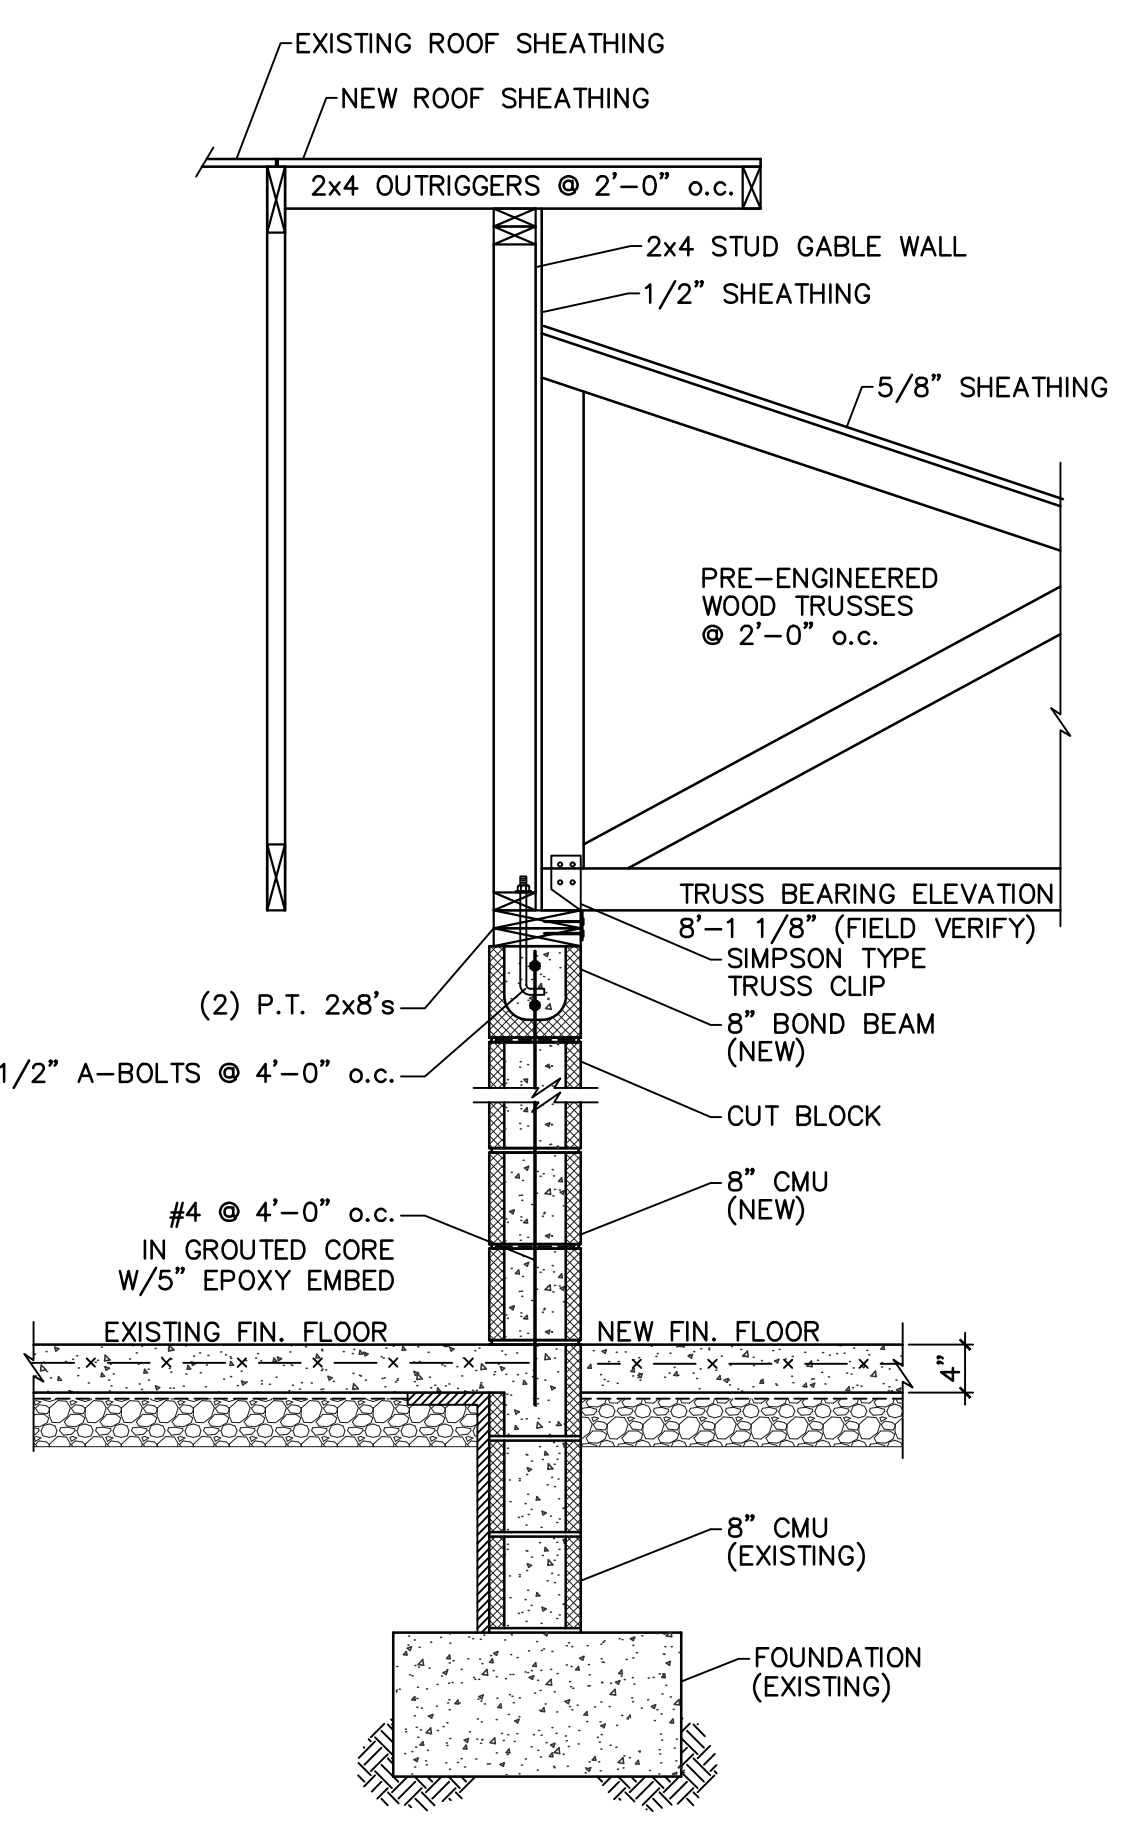
12 TRUSS CONNECTION DETAIL TO MASONRY WALL
S201 N.T.S.



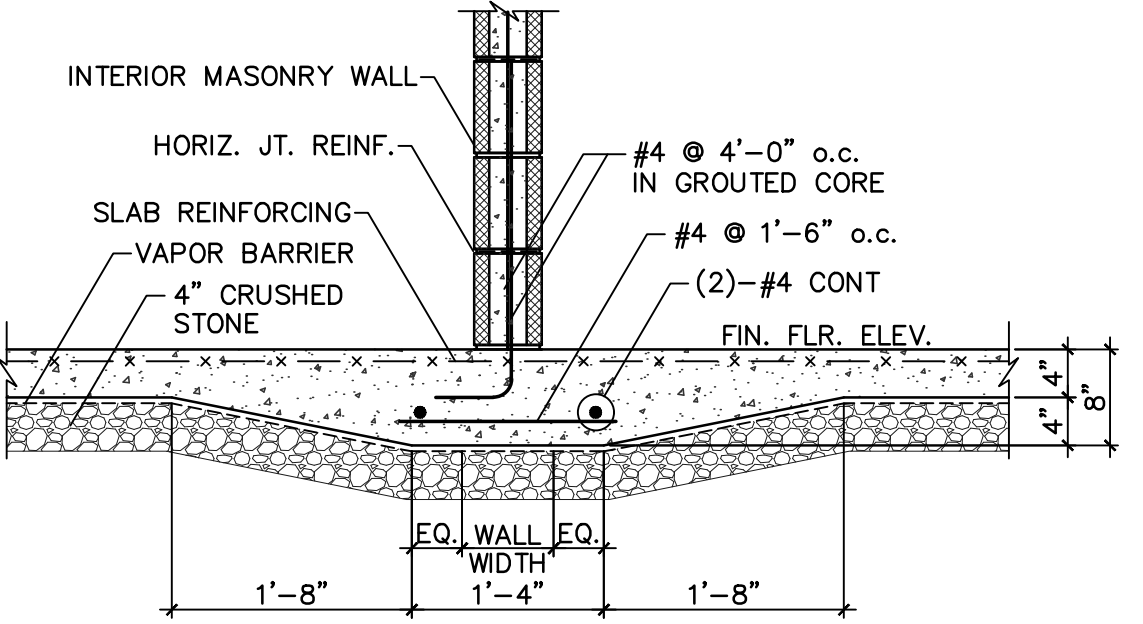11 WALL SECTION PROPOSED
S201 3/4" = 1'-0"



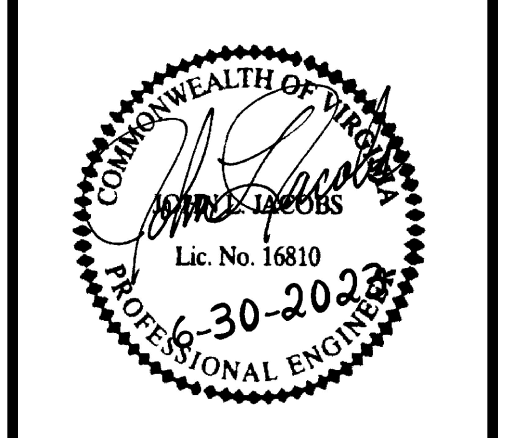13 THICKENED SLAB SECTION
S201 3/4" = 1'-0"



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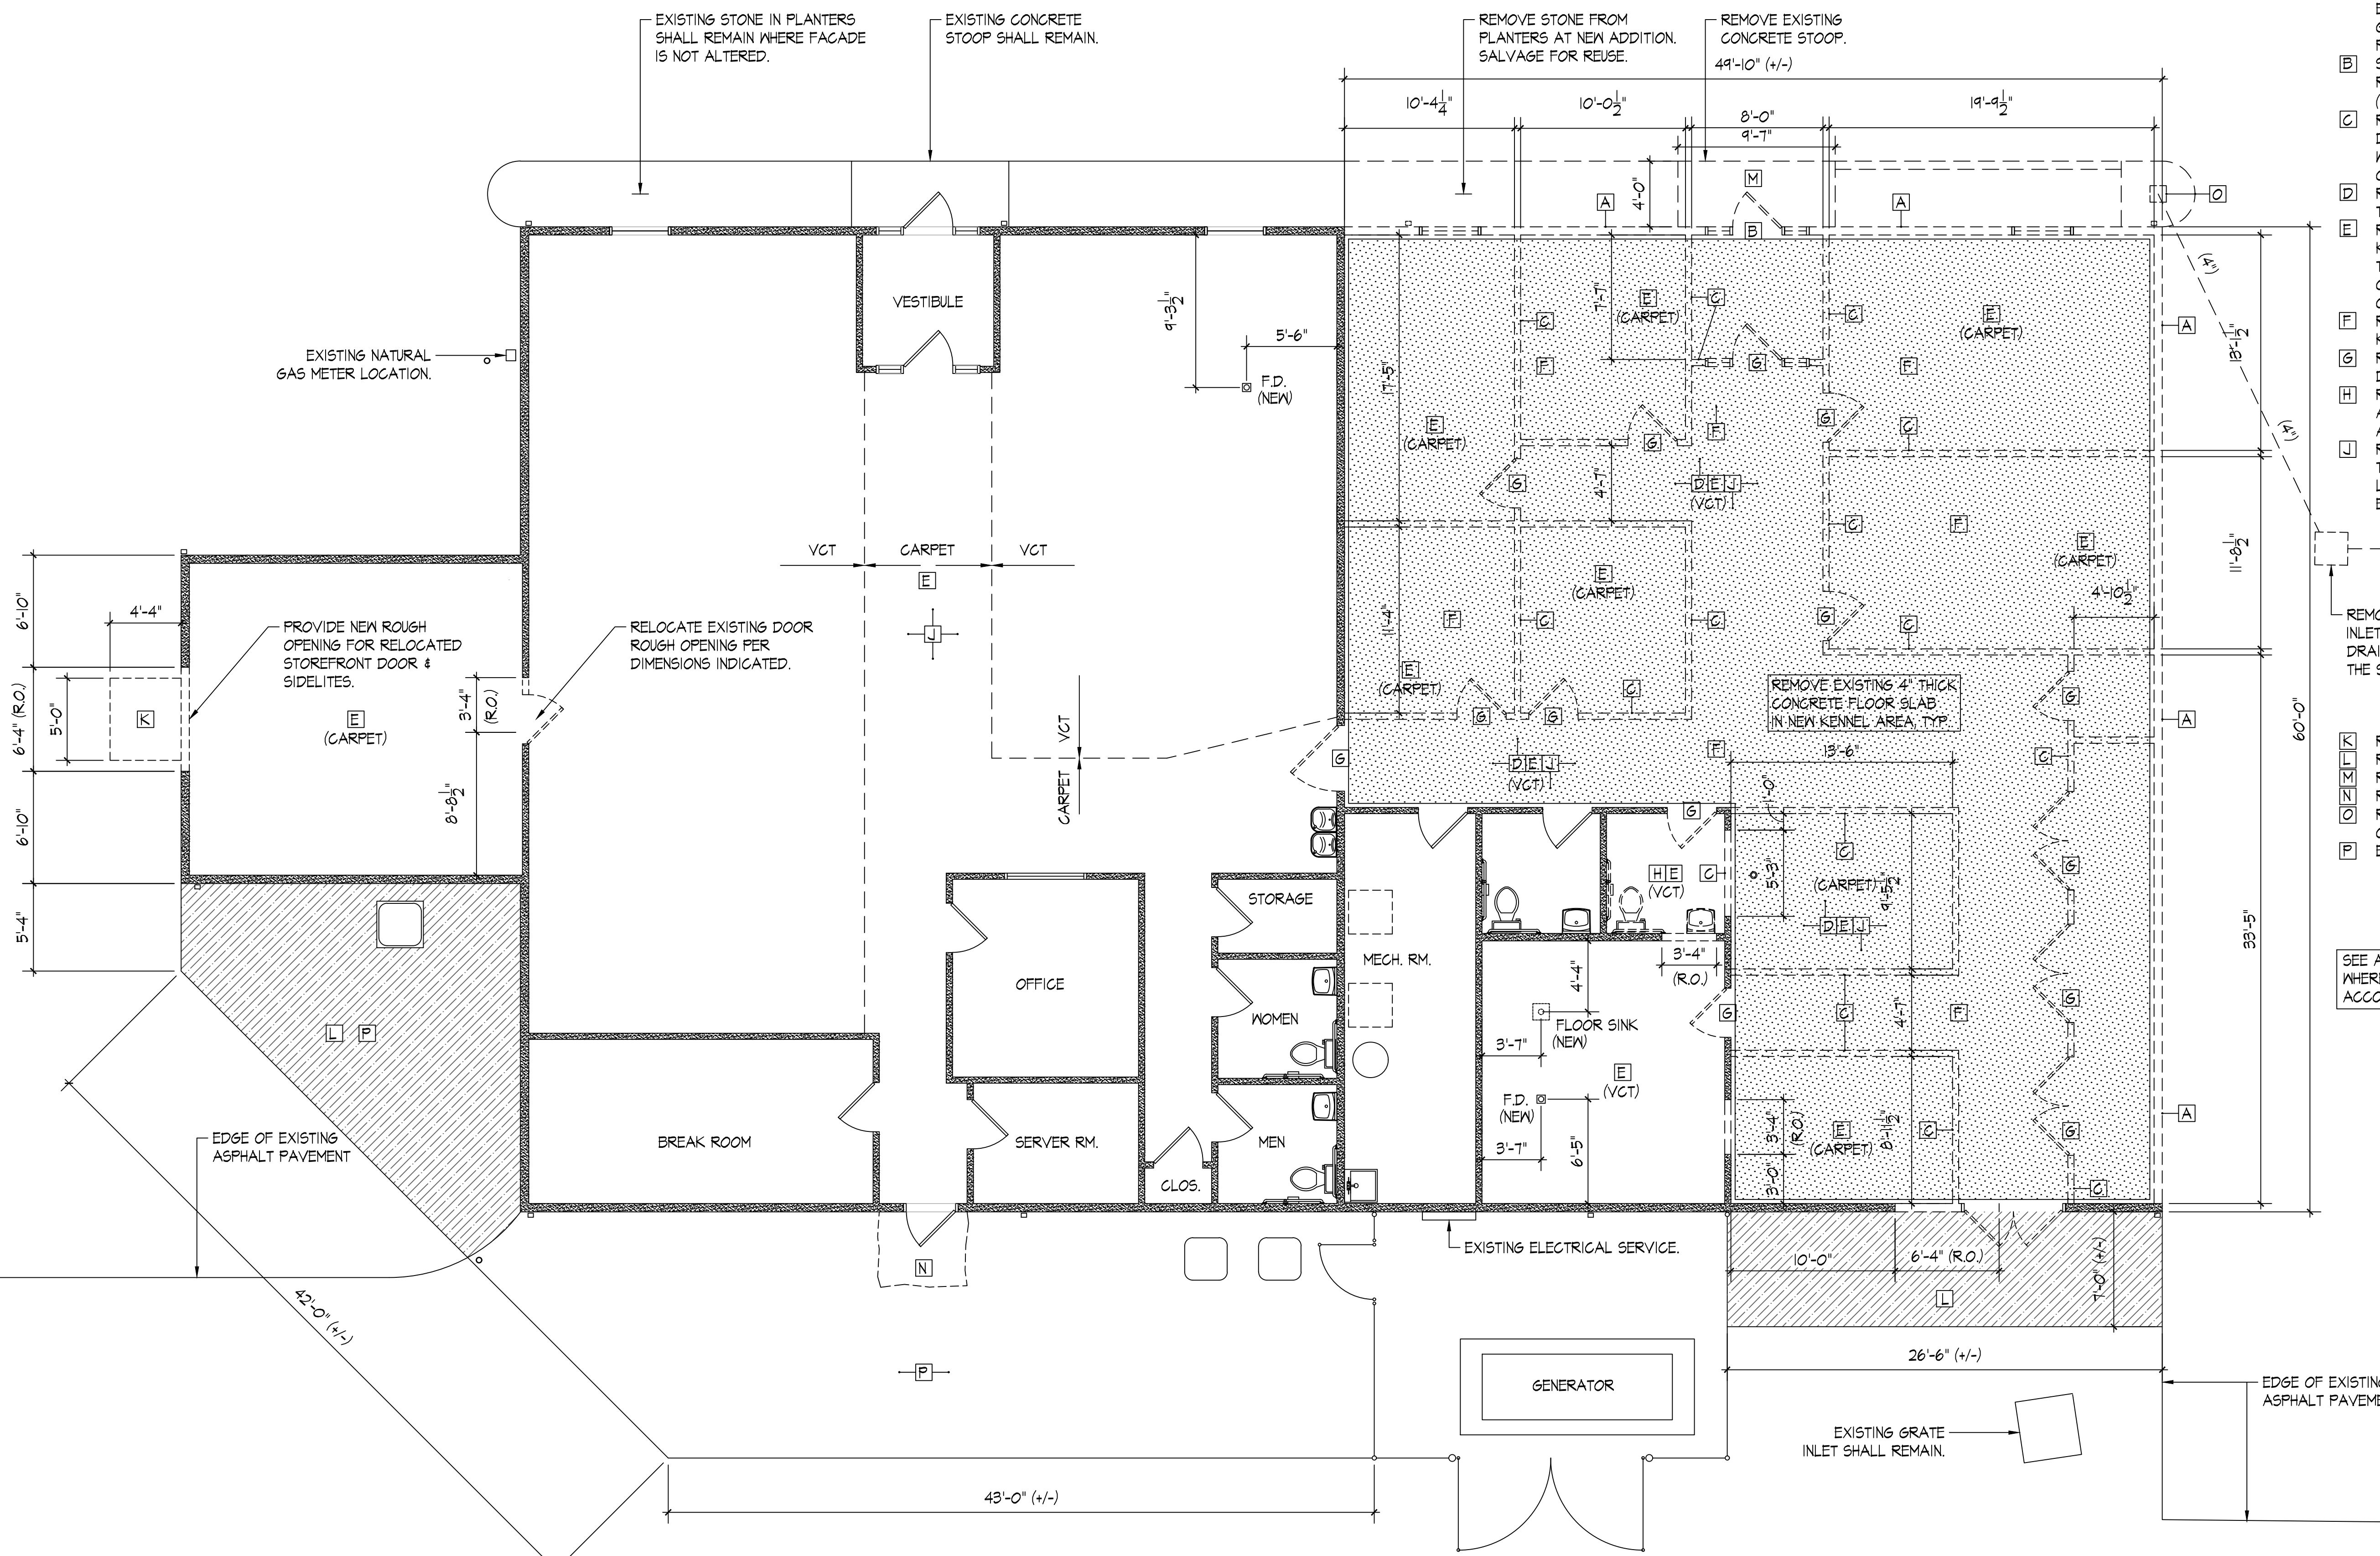
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PLT DATE 5/18/2023
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DEMOLITION PLAN KEY NOTES


- [A] PROVIDE TEMPORARY SHORING AS REQUIRED TO SUPPORT ROOF STRUCTURE WHERE EXTERIOR WALLS ARE REMOVED AT NEW KENNEL AREA. EXTERIOR WALLS ARE WOOD FRAMED WITH GYPSUM WALLBOARD INTERIOR AND T-11 PLYWOOD SIDING ON THE EXTERIOR.
- [B] SALVAGE STOREFRONT DOOR AND SIDELITES FOR REINSTALLATION AT SHERIFF'S OFFICE ENTRANCE, (DOOR #1).
- [C] REMOVE INTERIOR PARTITIONS SHOWN WITH DASHED LINES. PARTITIONS ARE GYPSUM WALLBOARD ON 2 X 4 WOOD FRAMING @ 16" ON CENTER.
- [D] REMOVE EXISTING GYPSUM WALLBOARD CEILINGS THROUGHOUT THE NEW KENNEL AREA.
- [E] REMOVE EXISTING FLOOR COVERINGS IN NEW KENNEL AREA AND ALL CARPET THROUGHOUT THE BUILDING. GRIND ADHESIVES FROM CONCRETE SUBFLOOR SURFACE AND PREPARE CONCRETE FOR NEW FINISH.
- [F] REMOVE EXISTING CONCRETE SLAB IN NEW KENNEL AREA.
- [G] REMOVE ALL 1 1/4" THICK SOLID CORE WOOD DOORS AND WOOD FRAMES SHOWN DASHED.
- [H] REMOVE EXISTING TOILET FIXTURES AND ACCESSORIES. SALVAGE FOR REINSTALLATION AS INDICATED ON PLUMBING DRAWINGS.
- [J] REMOVE EXISTING FLUORESCENT LIGHT FIXTURES THROUGHOUT THE BUILDING. PROVIDE NEW LED LIGHT FIXTURES AS INDICATED ON THE ELECTRICAL DRAWINGS.
- [K] REMOVE EXISTING ASPHALT RAMP.
- [L] REMOVE EXISTING BROKEN ASPHALT PAVEMENT.
- [M] REMOVE EXISTING CONCRETE STOOP.
- [N] REMOVE EXISTING BROKEN CONCRETE PAVEMENT.
- [O] REMOVE EXISTING 12" X 12" SUMP AND ADJACENT CONCRETE APRON.
- [P] EXCAVATE FOR NEW SODDED PLAY AREA.


SEE ALSO DRAWINGS P101 AND P102 FOR AREAS WHERE EXISTING FLOOR SLAB IS TO BE REMOVED TO ACCOMMODATE NEW PLUMBING WASTE LINES.




DEMOLITION FLOOR PLAN

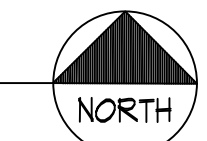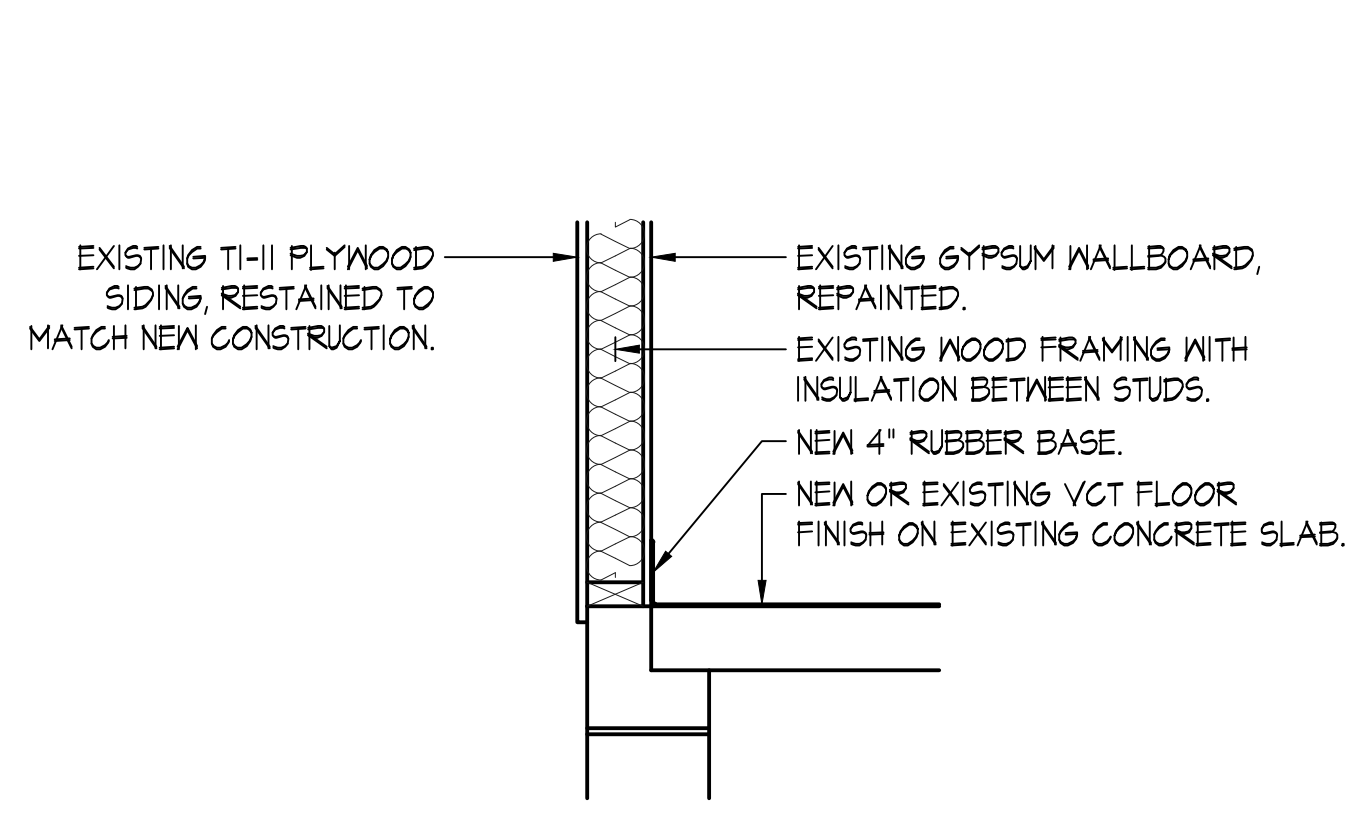SCALE: 3/16" = 1'-0"
0 4 8 12







A

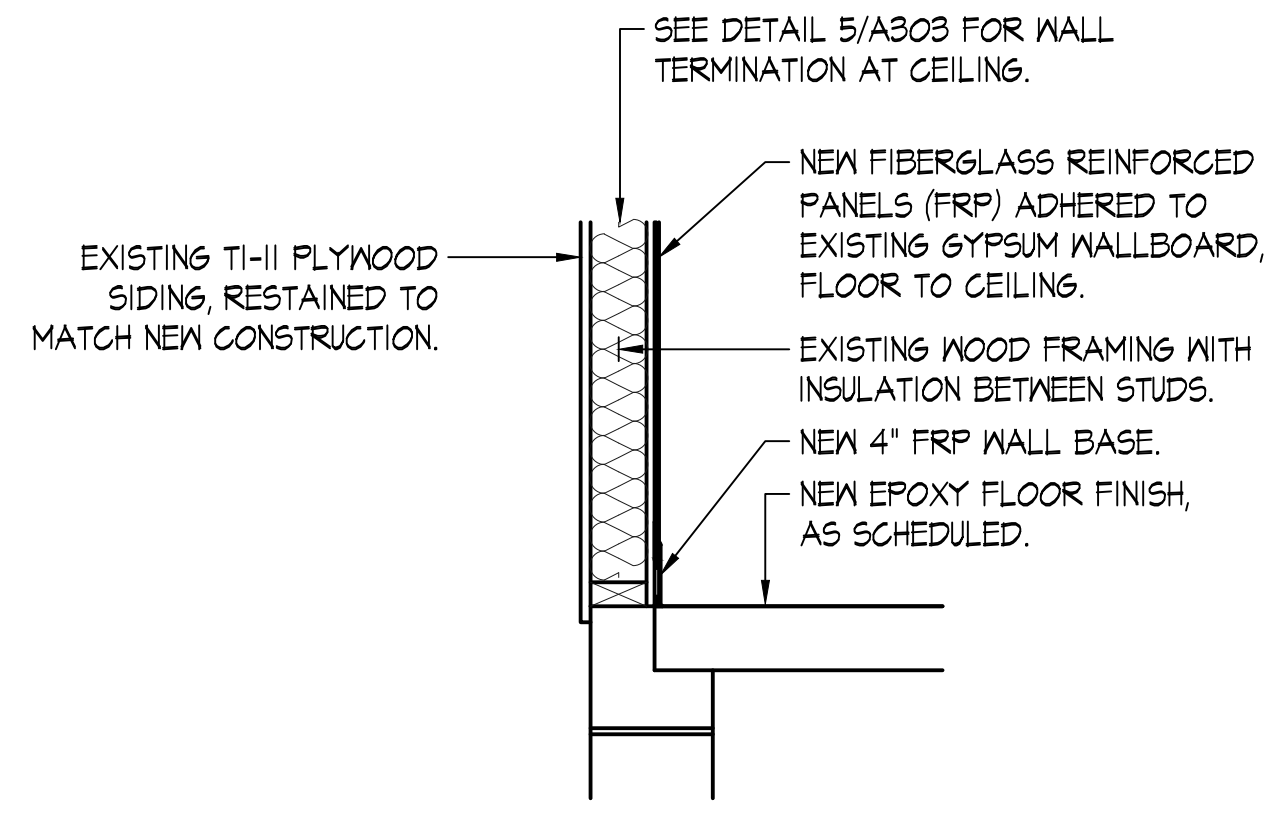


B

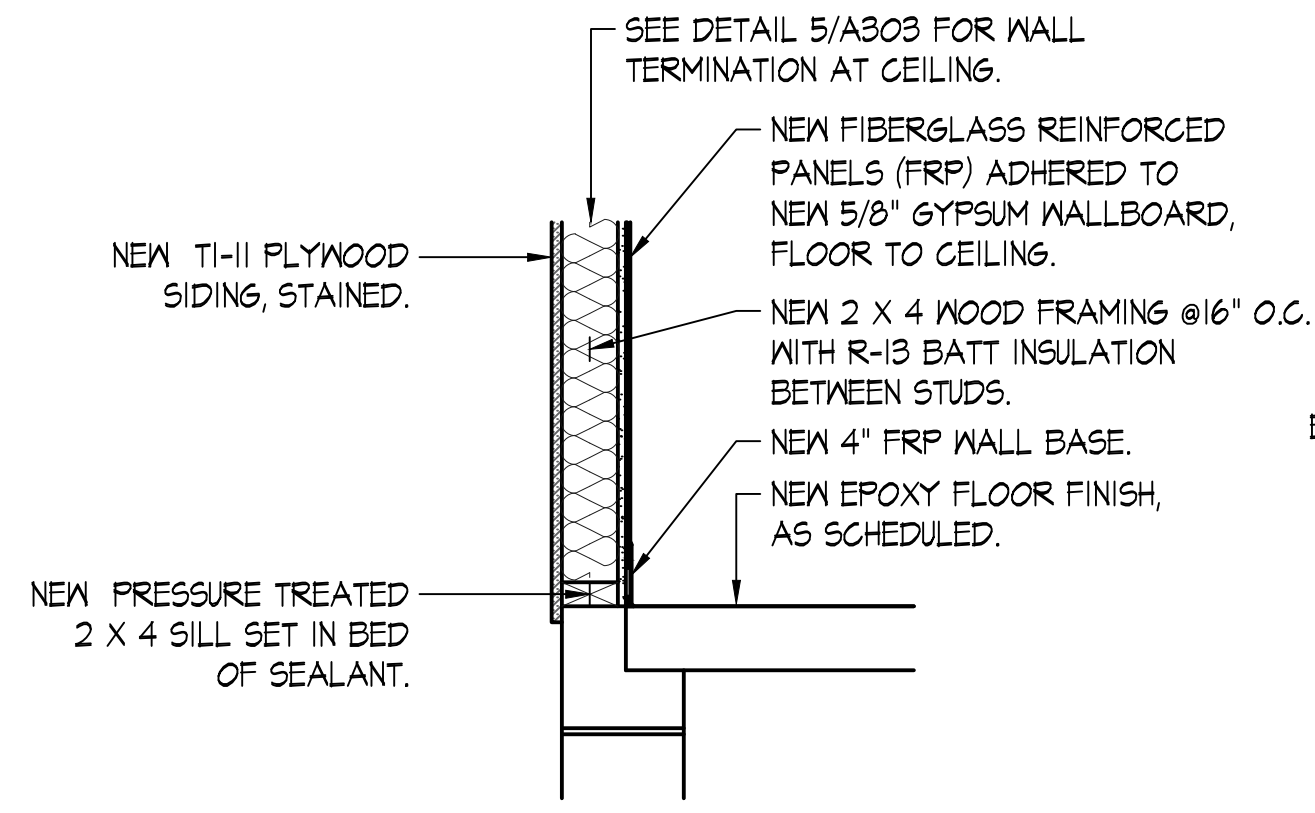


C

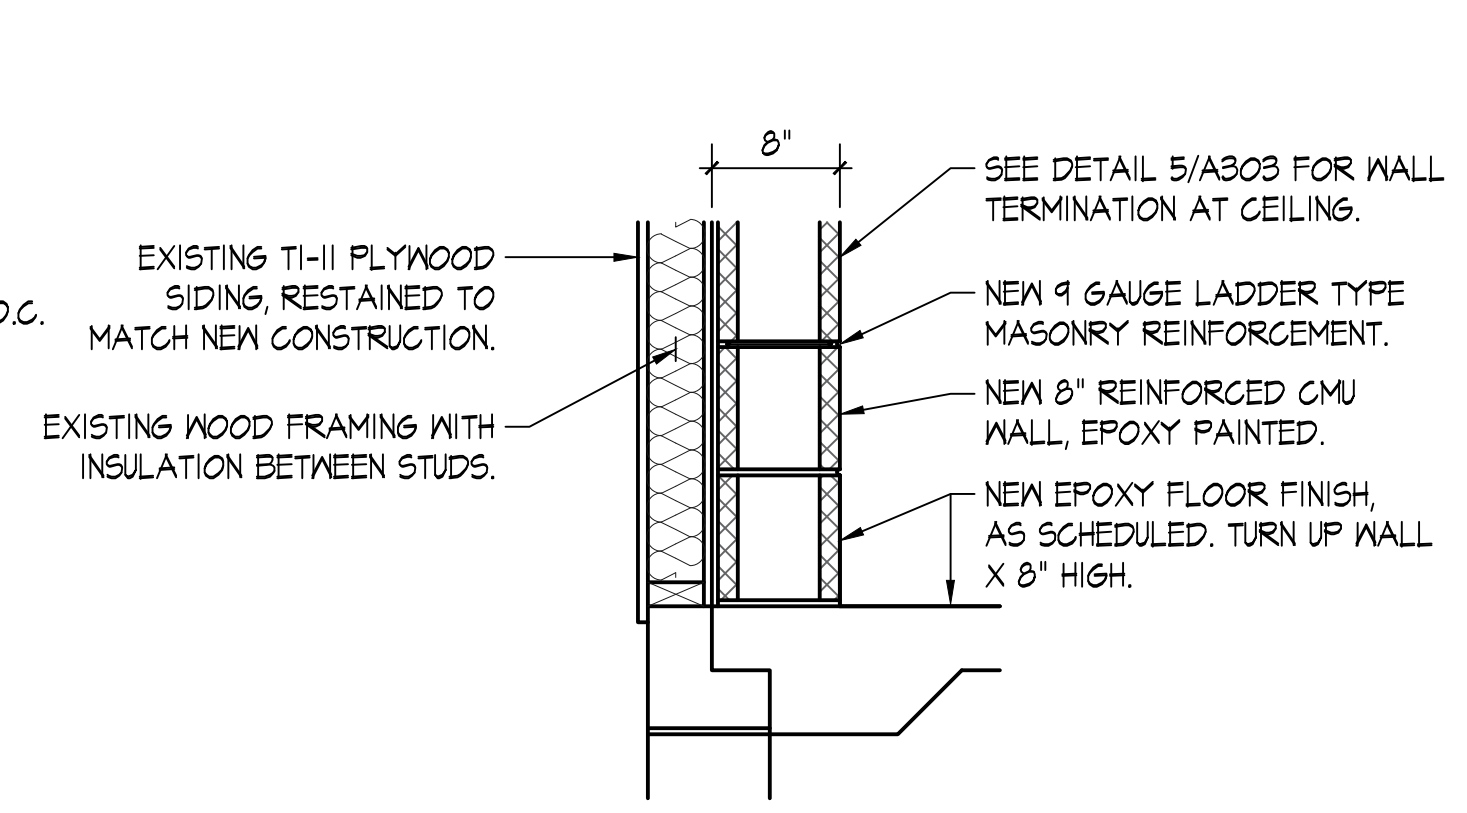

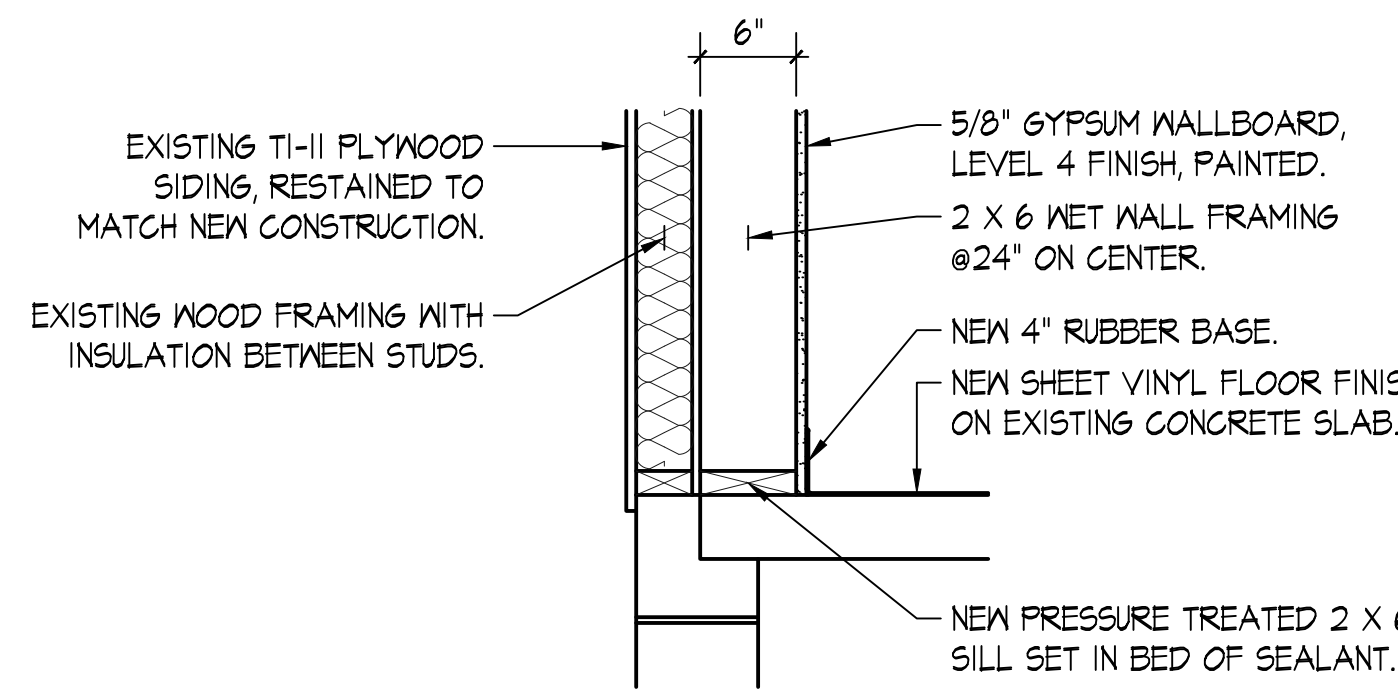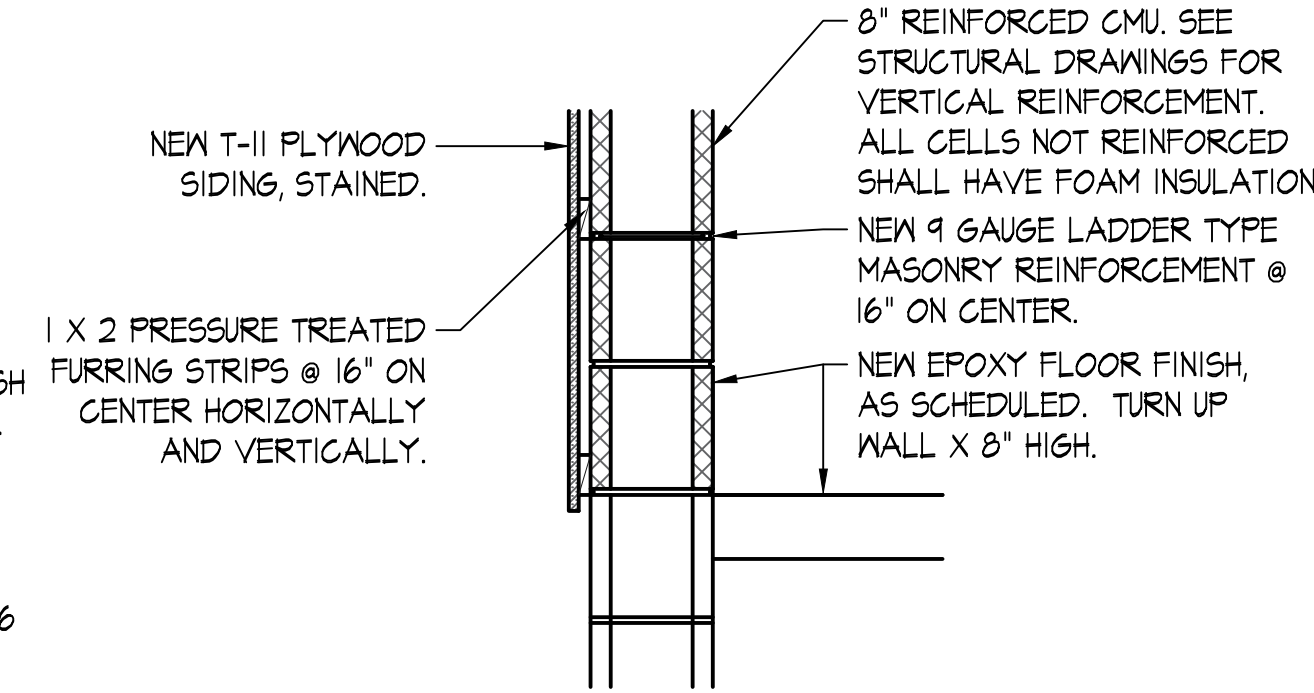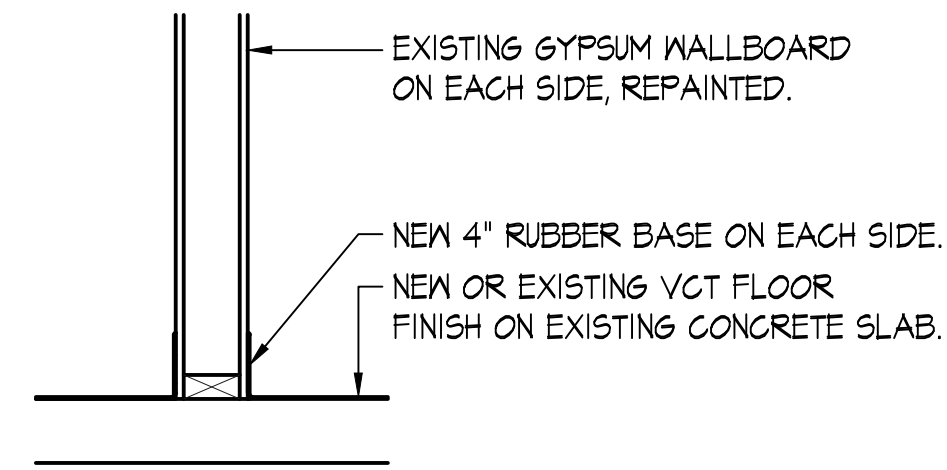
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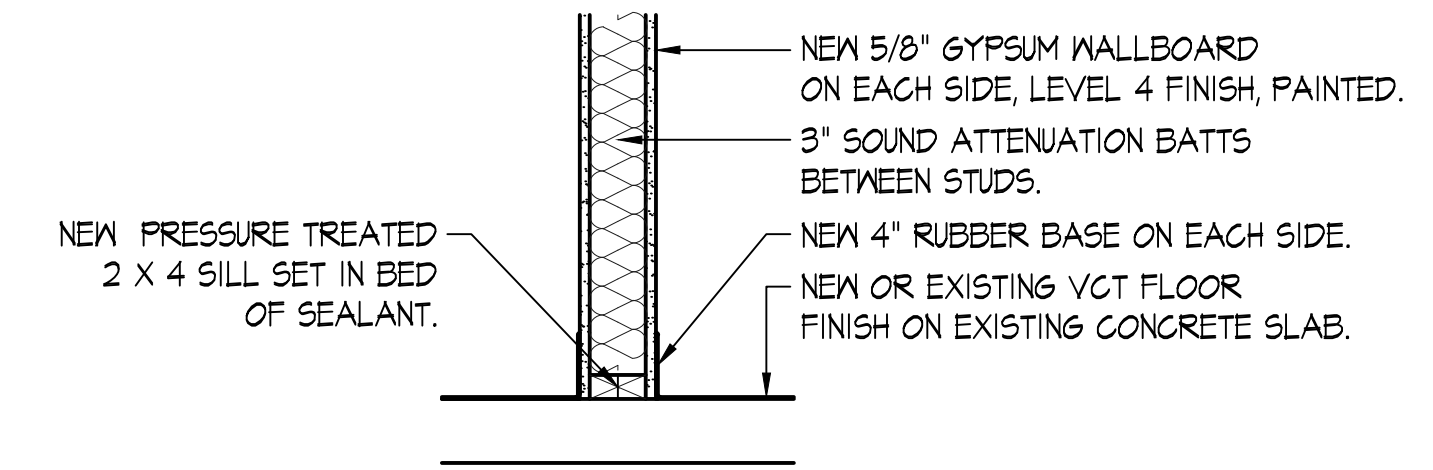
E



F



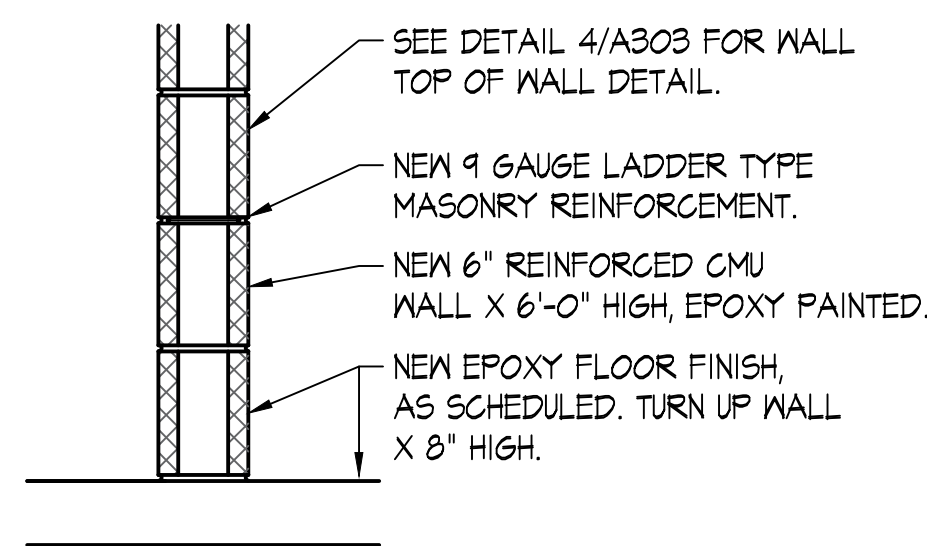
G




H

G1 SAME AS TYPE G EXCEPT WITH FRP AND FRP WALL BASE ON DOG KENNEL SIDE.

H1 SAME AS TYPE H EXCEPT WITH FRP AND FRP WALL BASE ON DOG KENNEL SIDE.




J

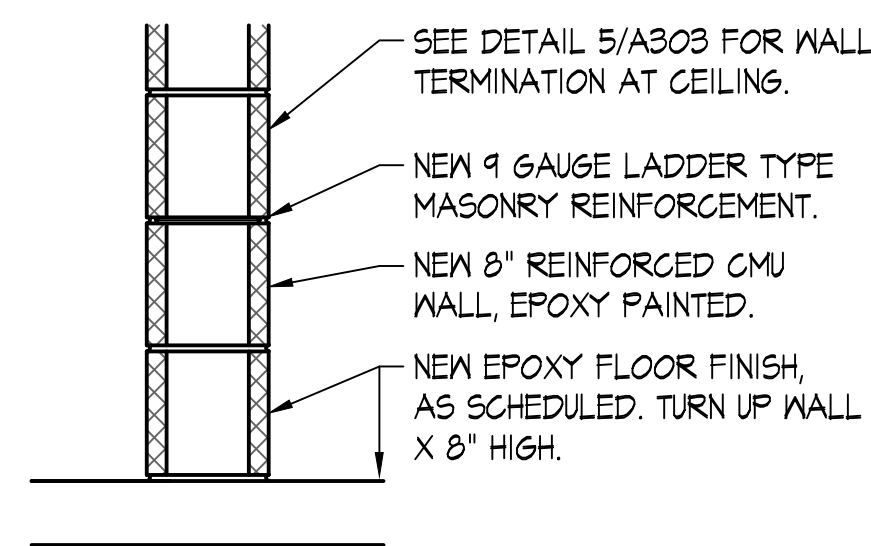

K

PARTITION TYPES

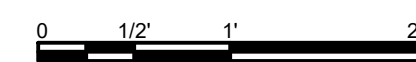SCALE: 1" = 1'-0"




BUILDING RENOVATION FOR
WASHINGTON COUNTY, VIRGINIA
ANIMAL SHELTER
15050 LEE HIGHWAY
BRISTOL, VIRGINIA 24201

PARTITION TYPES



DATE:	06-30-2023
NO.	REVISION DATE
1	*
2	
3	
SHEET:	A010
DRAWN BY:	CHECKED BY:
PROJECT NO:	TLG-22136
THE LANE GROUP INC.	

the LANE GROUP
engineering architecture environmental
310 Valley Street NW
Abingdon, VA 24210
276.206.8571 - office
Abingdon | Big Stone Gap | Galax
www.thelanegrp.com

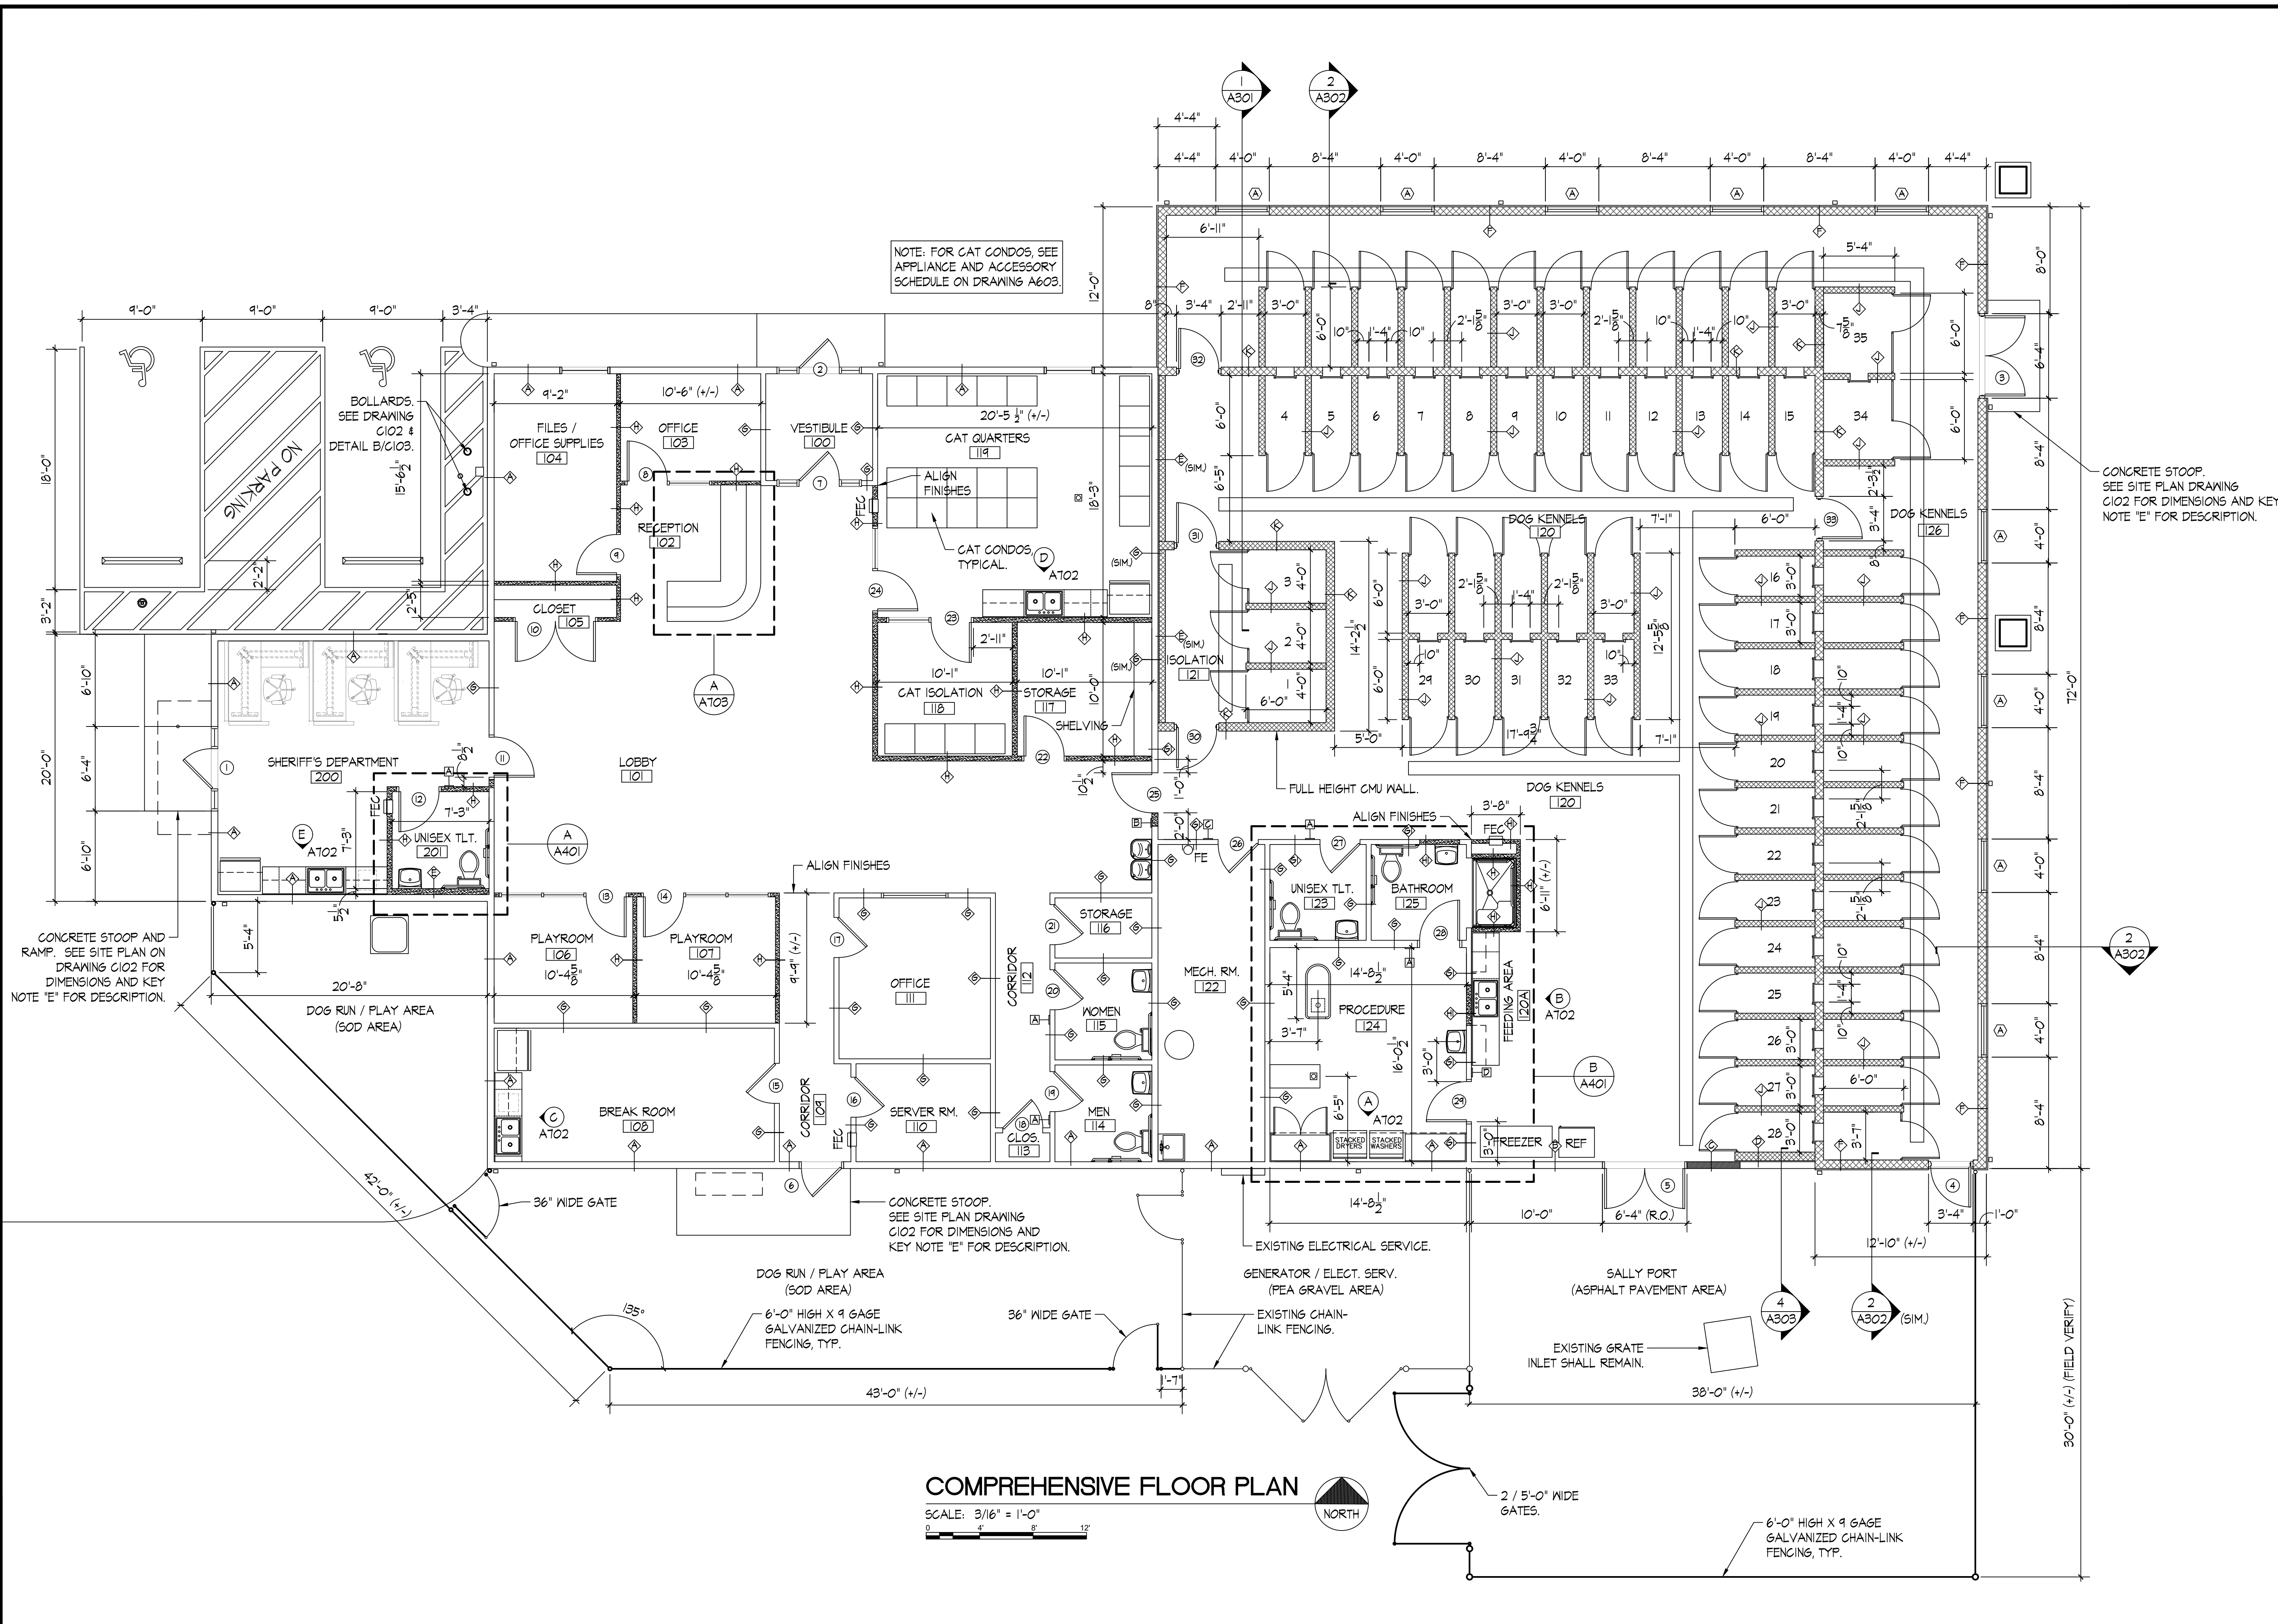

NOTE: FOR CAT CONDOS, SEE AFFLIANCE AND ACCESSORY SCHEDULE ON DRAWING A603.

CONCRETE STOOP. SEE SITE PLAN DRAWING C102 FOR DIMENSIONS AND KEY NOTE 'E' FOR DESCRIPTION.

CONCRETE STOOP AND RAMP. SEE SITE PLAN ON DRAWING C102 FOR DIMENSIONS AND KEY NOTE 'E' FOR DESCRIPTION.


CONCRETE STOOP. SEE SITE PLAN DRAWING C102 FOR DIMENSIONS AND KEY NOTE 'E' FOR DESCRIPTION.

COMPREHENSIVE FLOOR PLAN

SCALE: 3/16" = 1'-0"
 0 4 8 12




DATE:	06-30-2023
NO.	REVISION DATE
1	
2	
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SHEET:	A101
DRAWN BY:	CHECKED BY:
PROJECT NO.:	TLG-22136
THE LANE GROUP INC.	

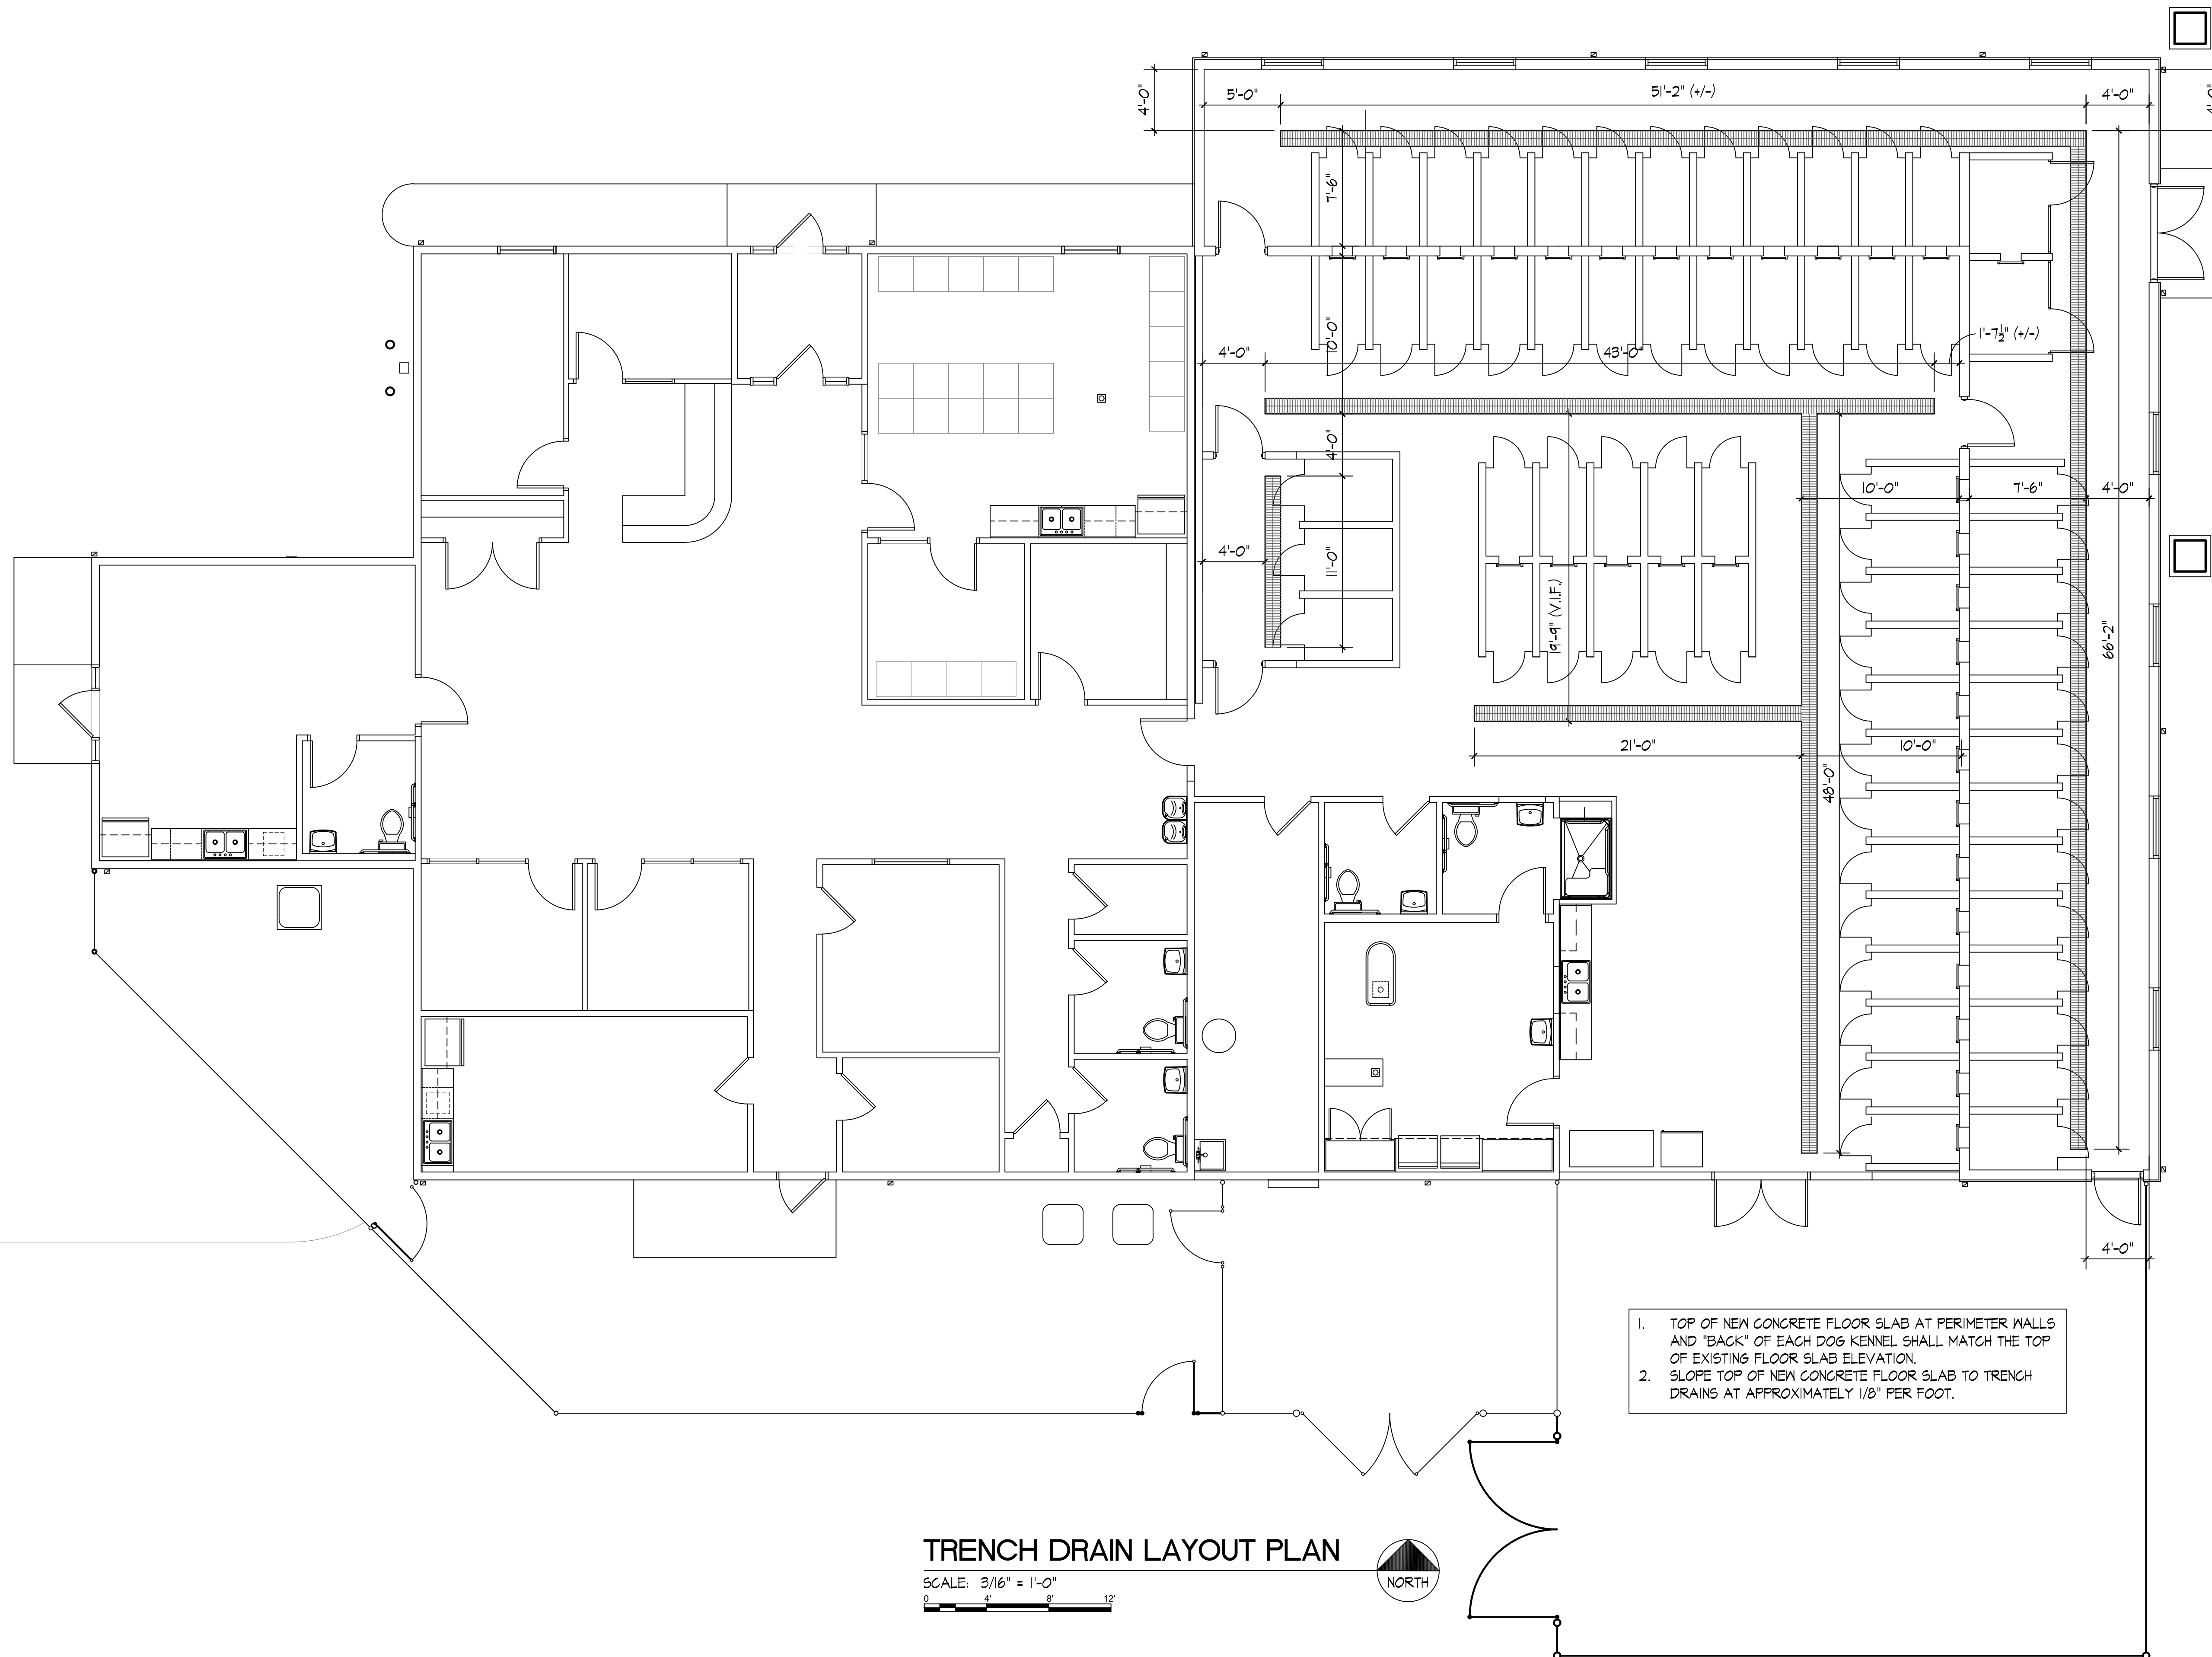

TRENCH DRAIN LAYOUT PLAN

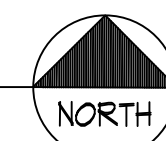SCALE: 3/16" = 1'-0"
 0 4' 8' 12'




1. TOP OF NEW CONCRETE FLOOR SLAB AT PERIMETER WALLS AND "BACK" OF EACH DOG KENNEL SHALL MATCH THE TOP OF EXISTING FLOOR SLAB ELEVATION.
2. SLOPE TOP OF NEW CONCRETE FLOOR SLAB TO TRENCH DRAINS AT APPROXIMATELY 1/8" PER FOOT.

TRENCH DRAIN
LAYOUT PLAN



DATE:	06-30-2023
NO.	REVISION DATE
1	
2	
3	
SHEET:	A102
DRAWN BY:	CHECKED BY:
PROJECT NO.:	TLG-22136
THE LANE GROUP INC.	

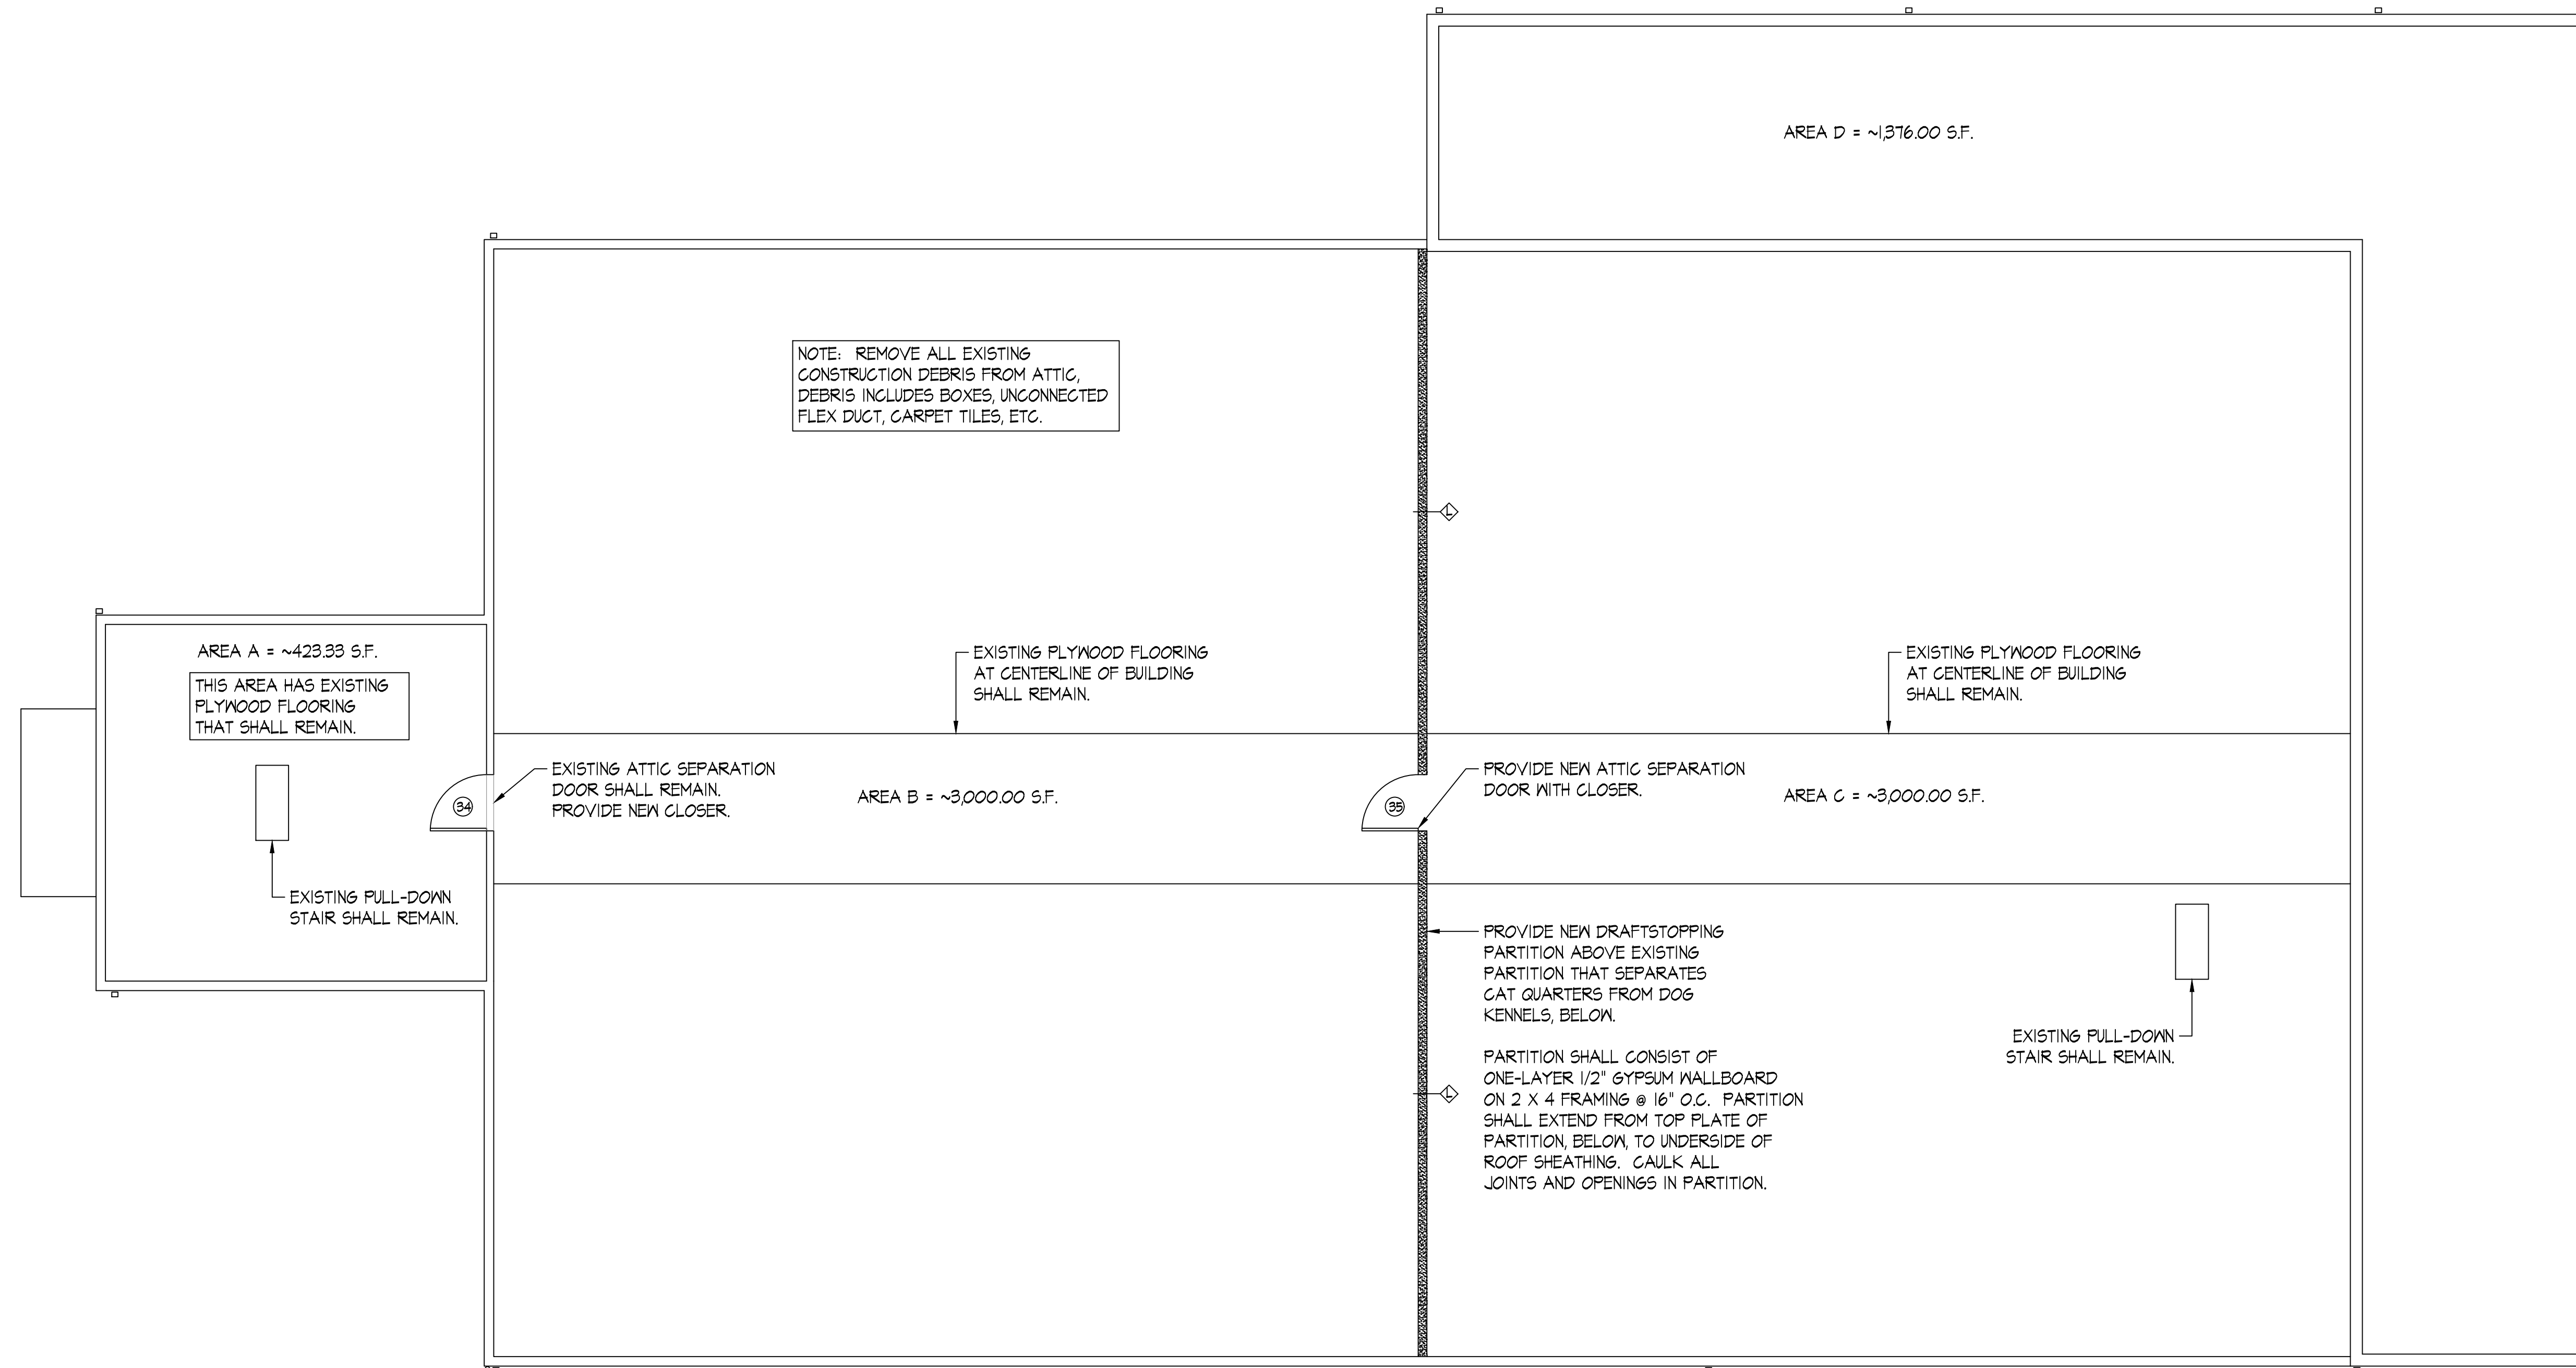

IBC SECTION 718.4, "DRAFTSTOPPING IN ATTICS".

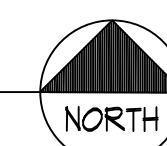
DRAFTSTOPPING SHALL BE INSTALLED TO SUBDIVIDE ATTIC SPACES.

DRAFTSTOPPING SHALL BE INSTALLED TO SUBDIVIDE COMBUSTIBLE ATTIC SPACES AND COMBUSTIBLE CONCEALED ROOF SPACES SUCH THAT ANY HORIZONTAL AREA DOES NOT EXCEED 3,000 SQUARE FEET. VENTILATION OF CONCEALED ROOF SPACES SHALL BE MAINTAINED IN ACCORDANCE WITH IBC 1202.2.1.

OPENINGS IN THE PARTITIONS SHALL BE PROTECTED BY SELF-CLOSING DOORS WITH AUTOMATIC LATCHES.

ATTIC FLOOR PLAN

SCALE: 3/16" = 1'-0"
0 4 8 12



**BUILDING RENOVATION FOR
WASHINGTON COUNTY, VIRGINIA
ANIMAL SHELTER**
15050 LEE HIGHWAY
BRISTOL, VIRGINIA 24201

ATTIC FLOOR PLAN



DATE: 06-30-2023

NO.	REVISION DATE
1	
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SHEET: A103


DRAWN BY: CHECKED BY:

PROJECT NO. TLG-22136

THE LANE GROUP INC.


the LANE GROUP
engineering
architecture
environmental
Abingdon | Big Stone Gap | Galax
www.thelaneinc.com

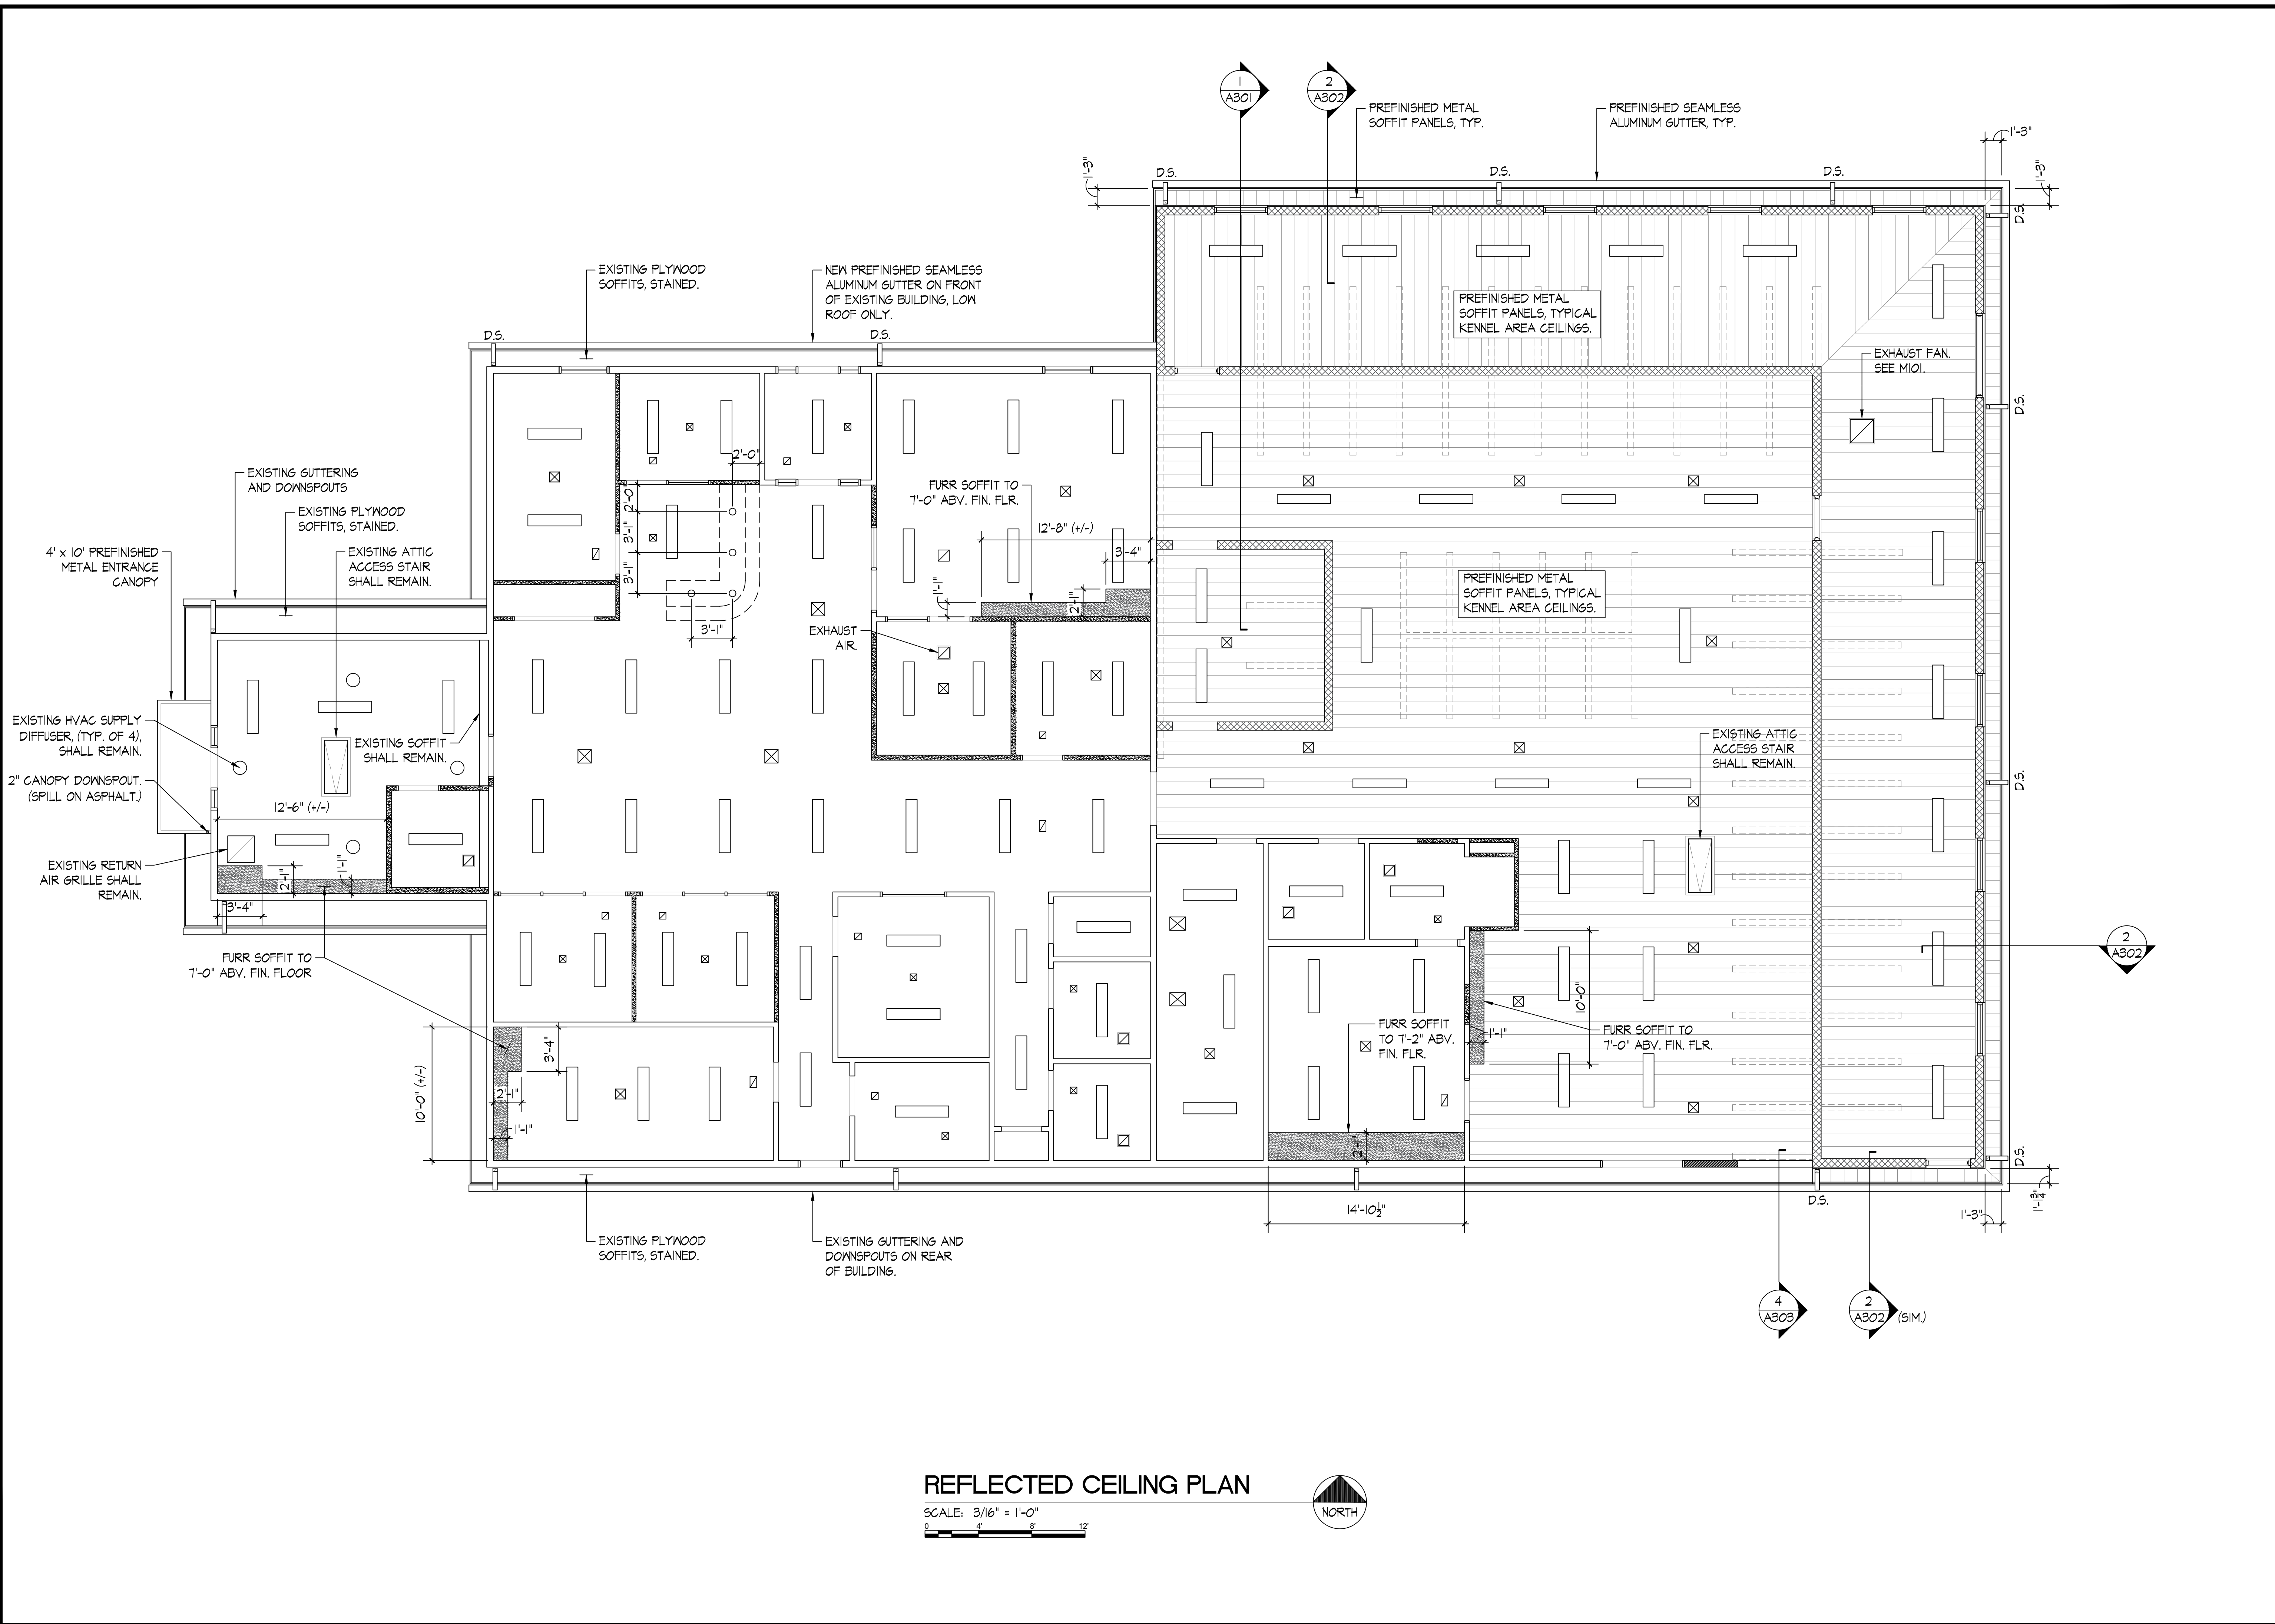310 Valley Street NW
Abingdon, VA 24210
276.206.8571 - office




REFLECTED CEILING PLAN

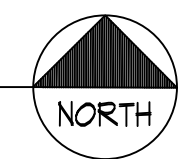
SCALE: 3/16" = 1'-0"
 0 4 8 12



DATE:	06-30-2023
NO.	REVISION DATE
1	
2	
3	
SHEET:	A111
DRAWN BY:	CHECKED BY:
PROJECT NO.:	TLG-22136
THE LANE GROUP INC.	

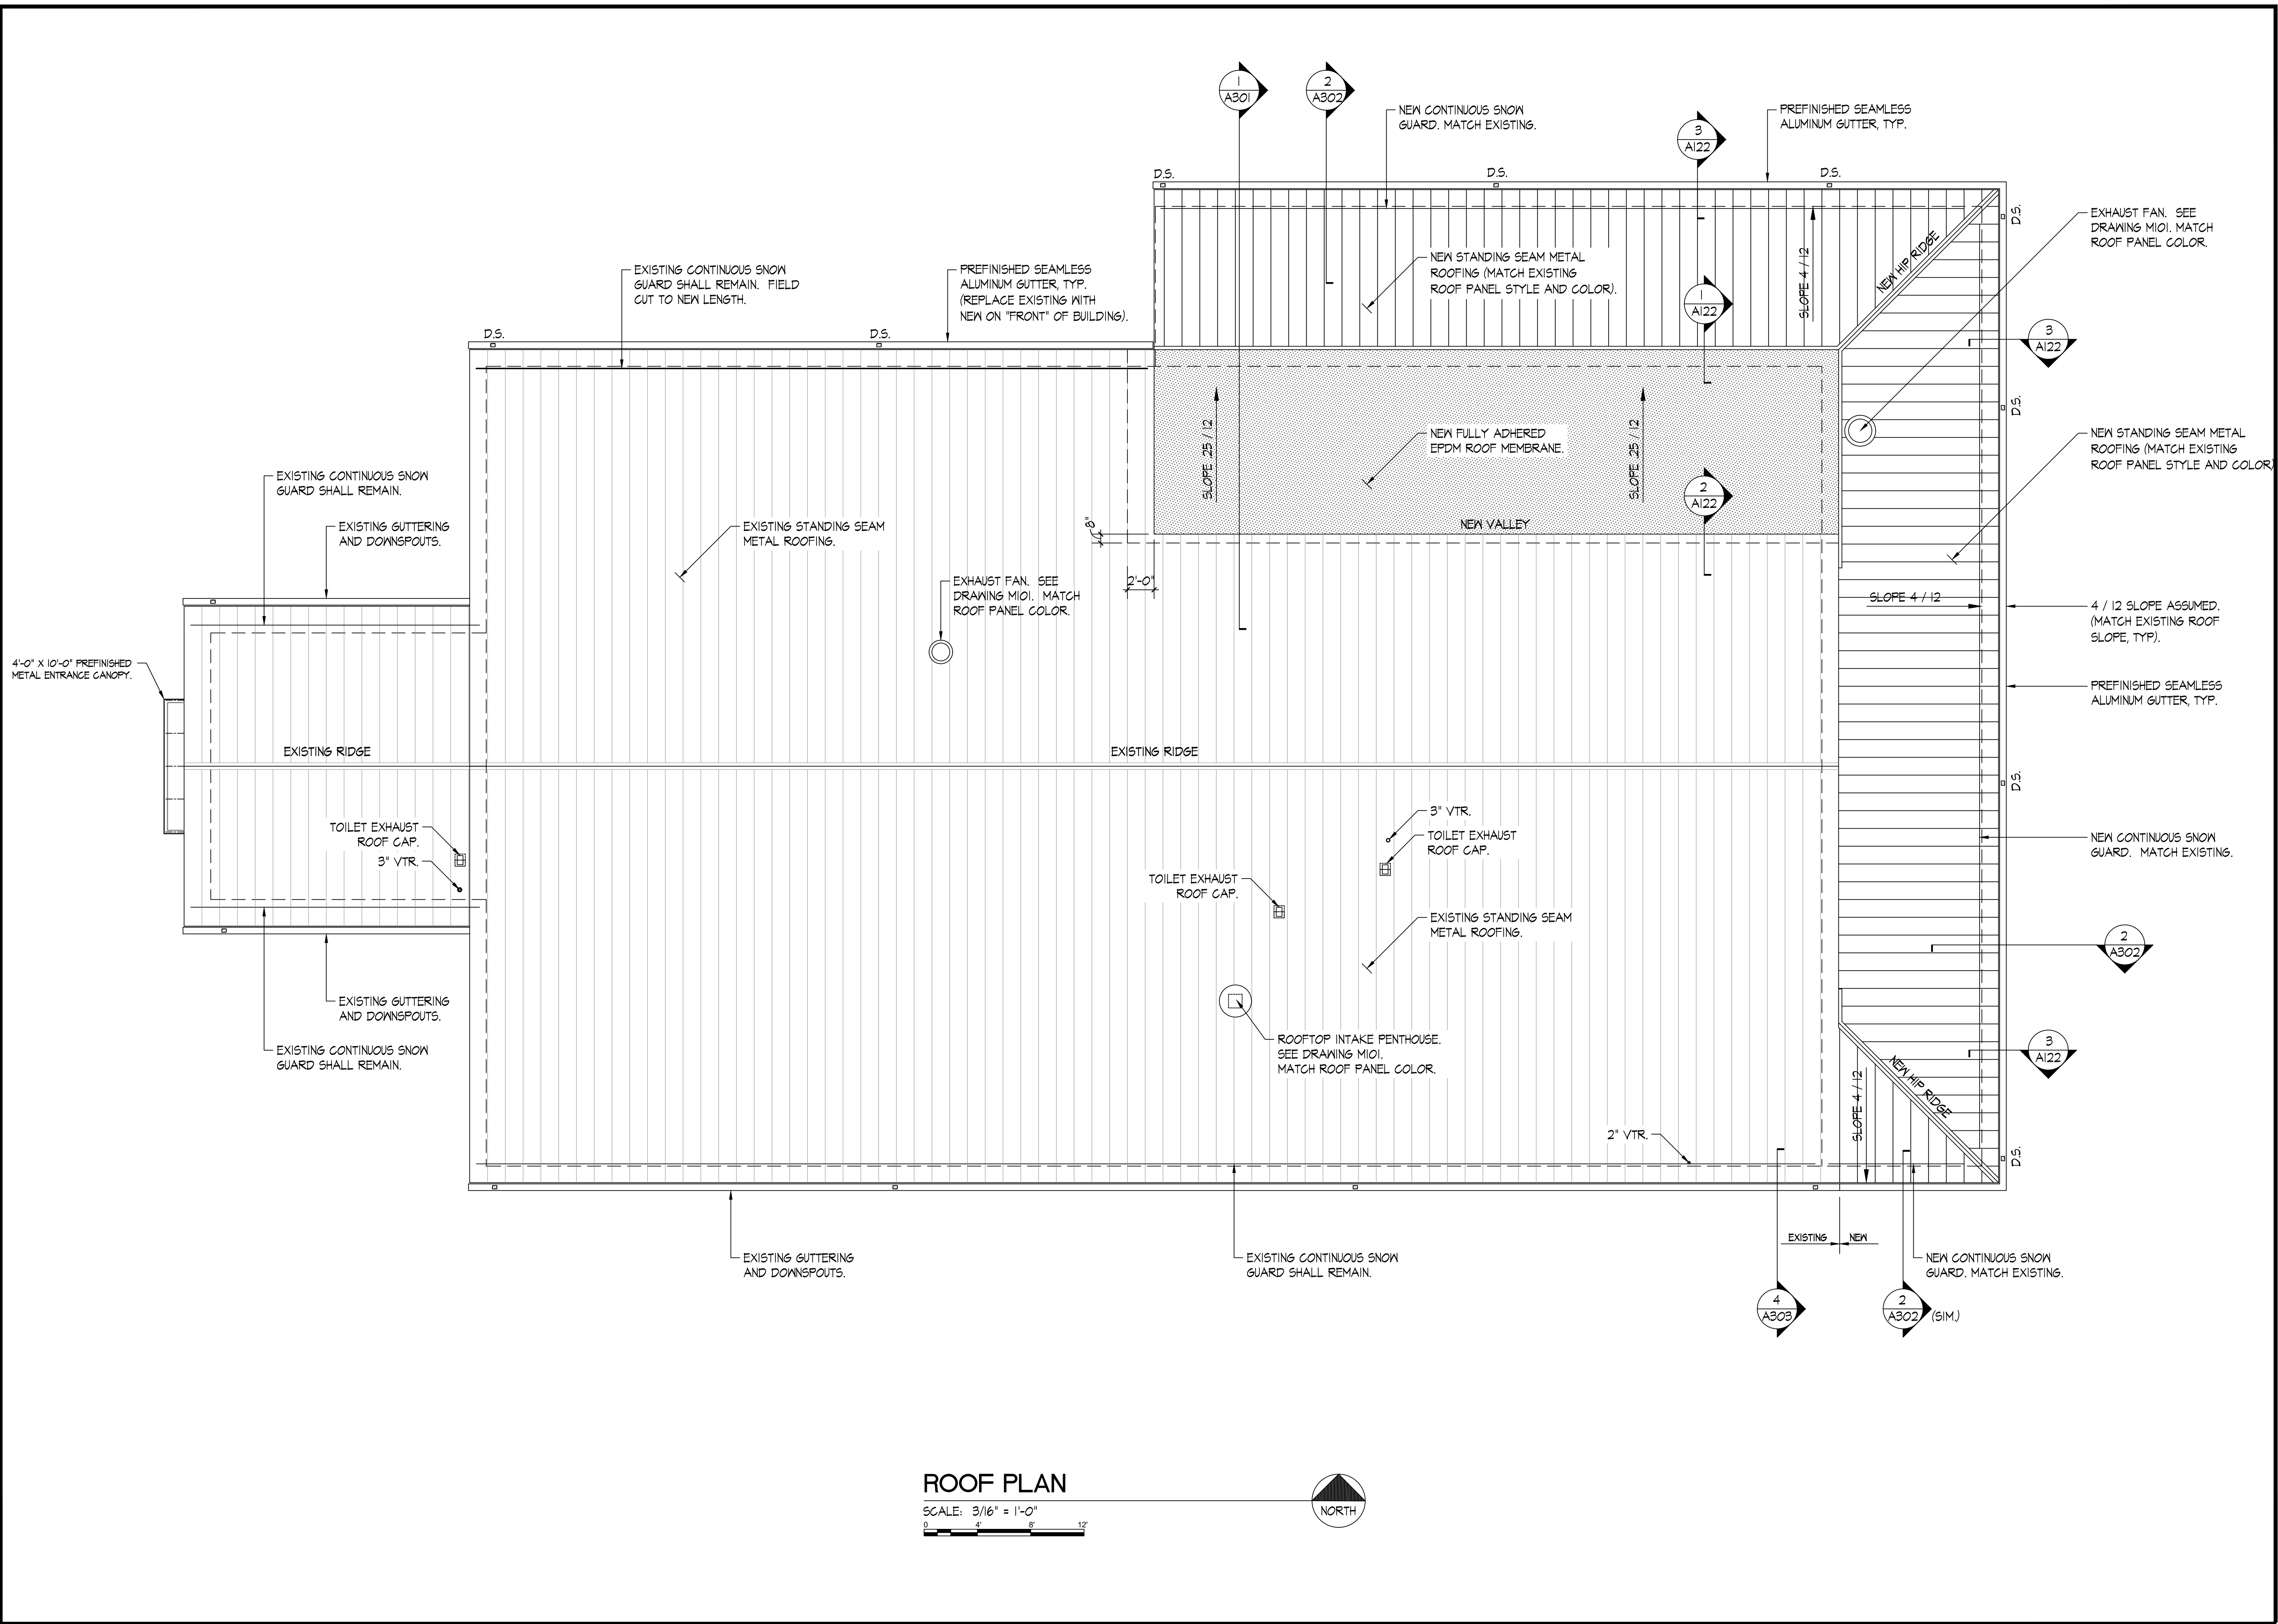

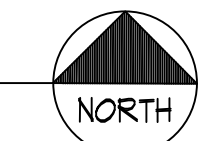ROOF PLAN
 SCALE: 3/16" = 1'-0"
 0 4 8 12



**BUILDING RENOVATION FOR
 WASHINGTON COUNTY, VIRGINIA
 ANIMAL SHELTER**
 15050 LEE HIGHWAY
 BRISTOL, VIRGINIA 24201


ROOF PLAN




DATE:	06-30-2023
NO.	REVISION DATE
1	
2	
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SHEET:	A121
DRAWN BY:	CHECKED BY:
PROJECT NO.	TLG-22136
THE LANE GROUP INC.	

ROOF DETAIL NOTES

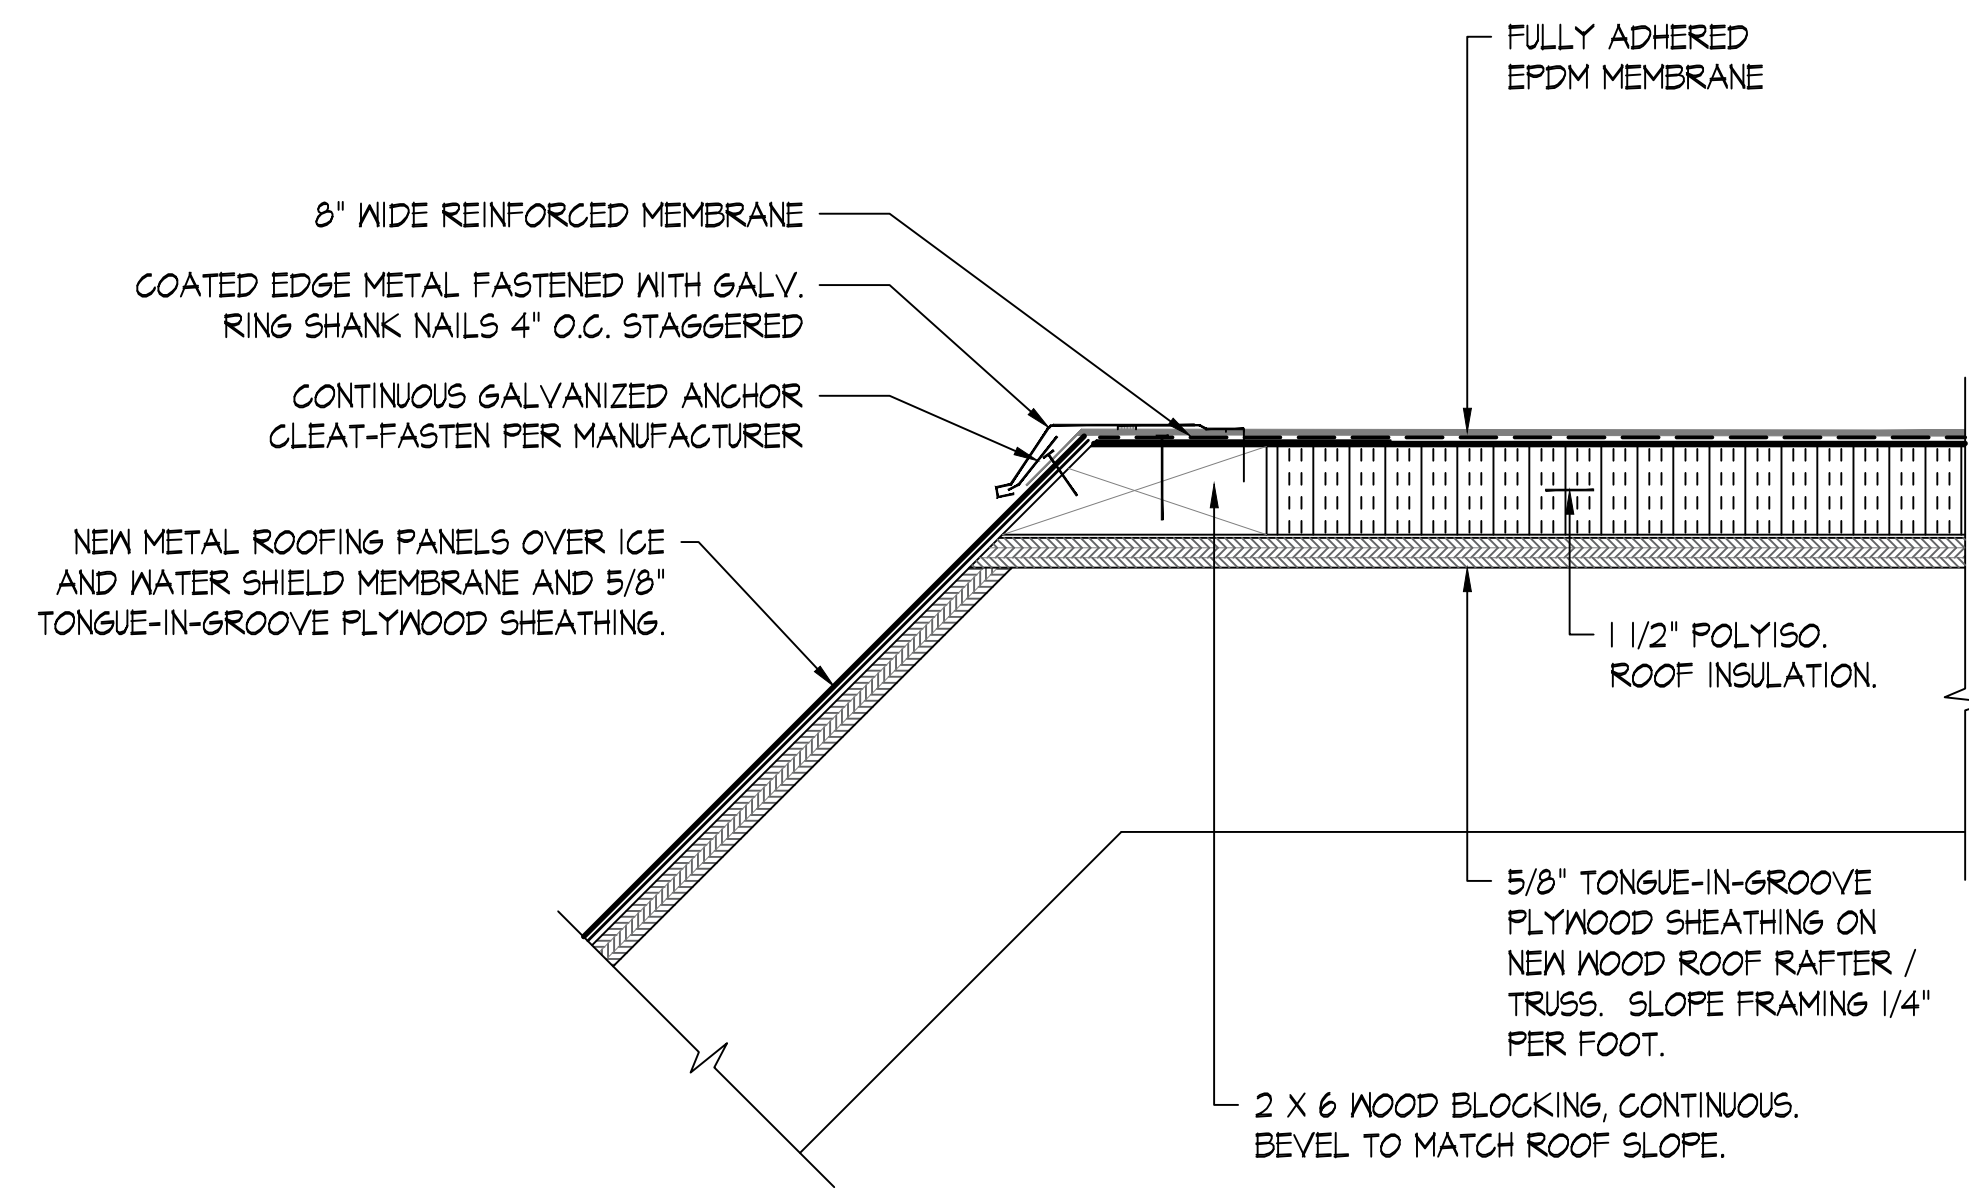
1. ROOF SLOPES ARE EXAGGERATED IN DETAILS 1 AND 2. THE INTENT IS FOR NEW ROOF SLOPES TO MATCH EXISTING SLOPES, BELIEVED TO BE 4 / 12 SLOPES. FIELD VERIFY SLOPE PRIOR TO FABRICATING NEW TRUSSES.
2. DETAIL 2 / A122 IS INTENDED TO CONVEY AN EXISTING METAL ROOF TO NEW FULLY ADHERED EPDM ROOF MEMBRANE TRANSITION. EXISTING ROOF PANELS WILL NEED TO BE DISMANTLED, TRIMMED, AND REINSTALLED. UTILIZATION OF EPDM MANUFACTURER'S DETAIL FOR THIS TRANSITION MAY SUPERSEDE THE DETAIL DRAWN, AS REQUIRED TO ACHIEVE THE EPDM MEMBRANE ROOF WARRANTY SPECIFIED.
3. DETAIL 1 / A122 IS INTENDED TO CONVEY A NEW FULLY ADHERED EPDM MEMBRANE ROOF TO NEW METAL ROOF TRANSITION. UTILIZATION OF EPDM MANUFACTURER'S DETAIL FOR THIS TRANSITION MAY SUPERSEDE THE DETAIL DRAWN, AS REQUIRED TO ACHIEVE THE EPDM MEMBRANE ROOF WARRANTY SPECIFIED.
4. BONDING ADHESIVE IS REQUIRED BETWEEN EPDM MEMBRANE AND INSULATION FOR FULLY ADHERED SYSTEMS.



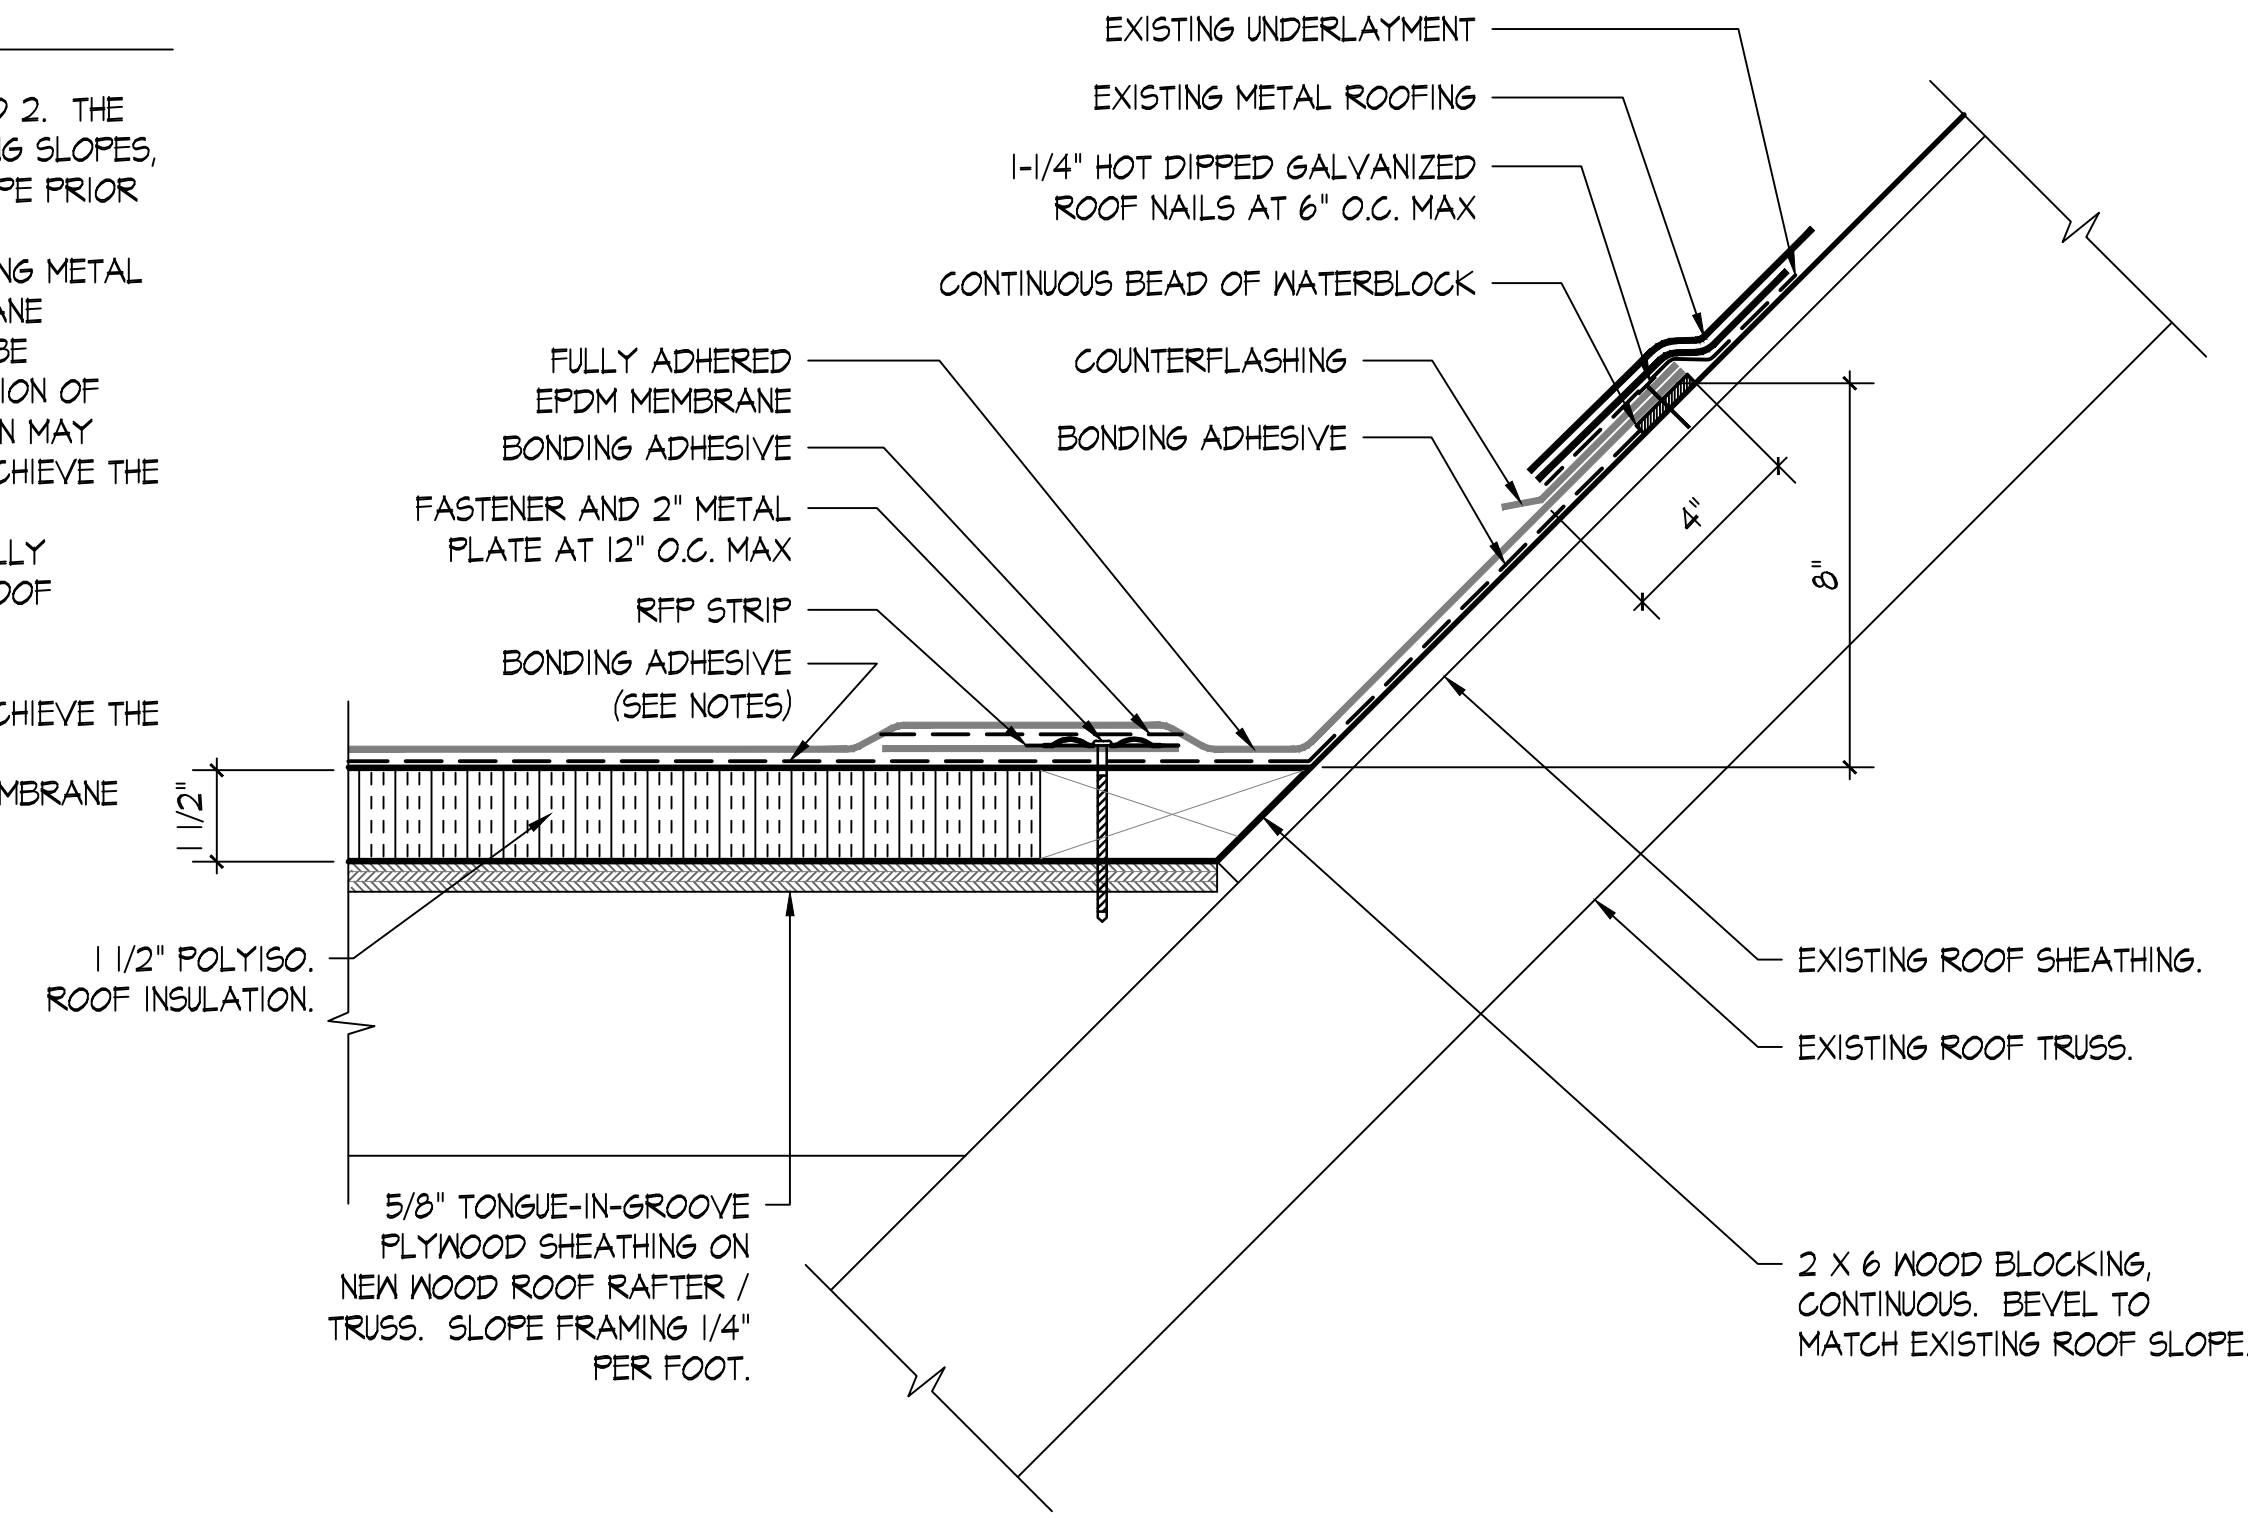
1 EPDM MEMBRANE TO NEW METAL ROOFING SCALE: 3"=1'-0"



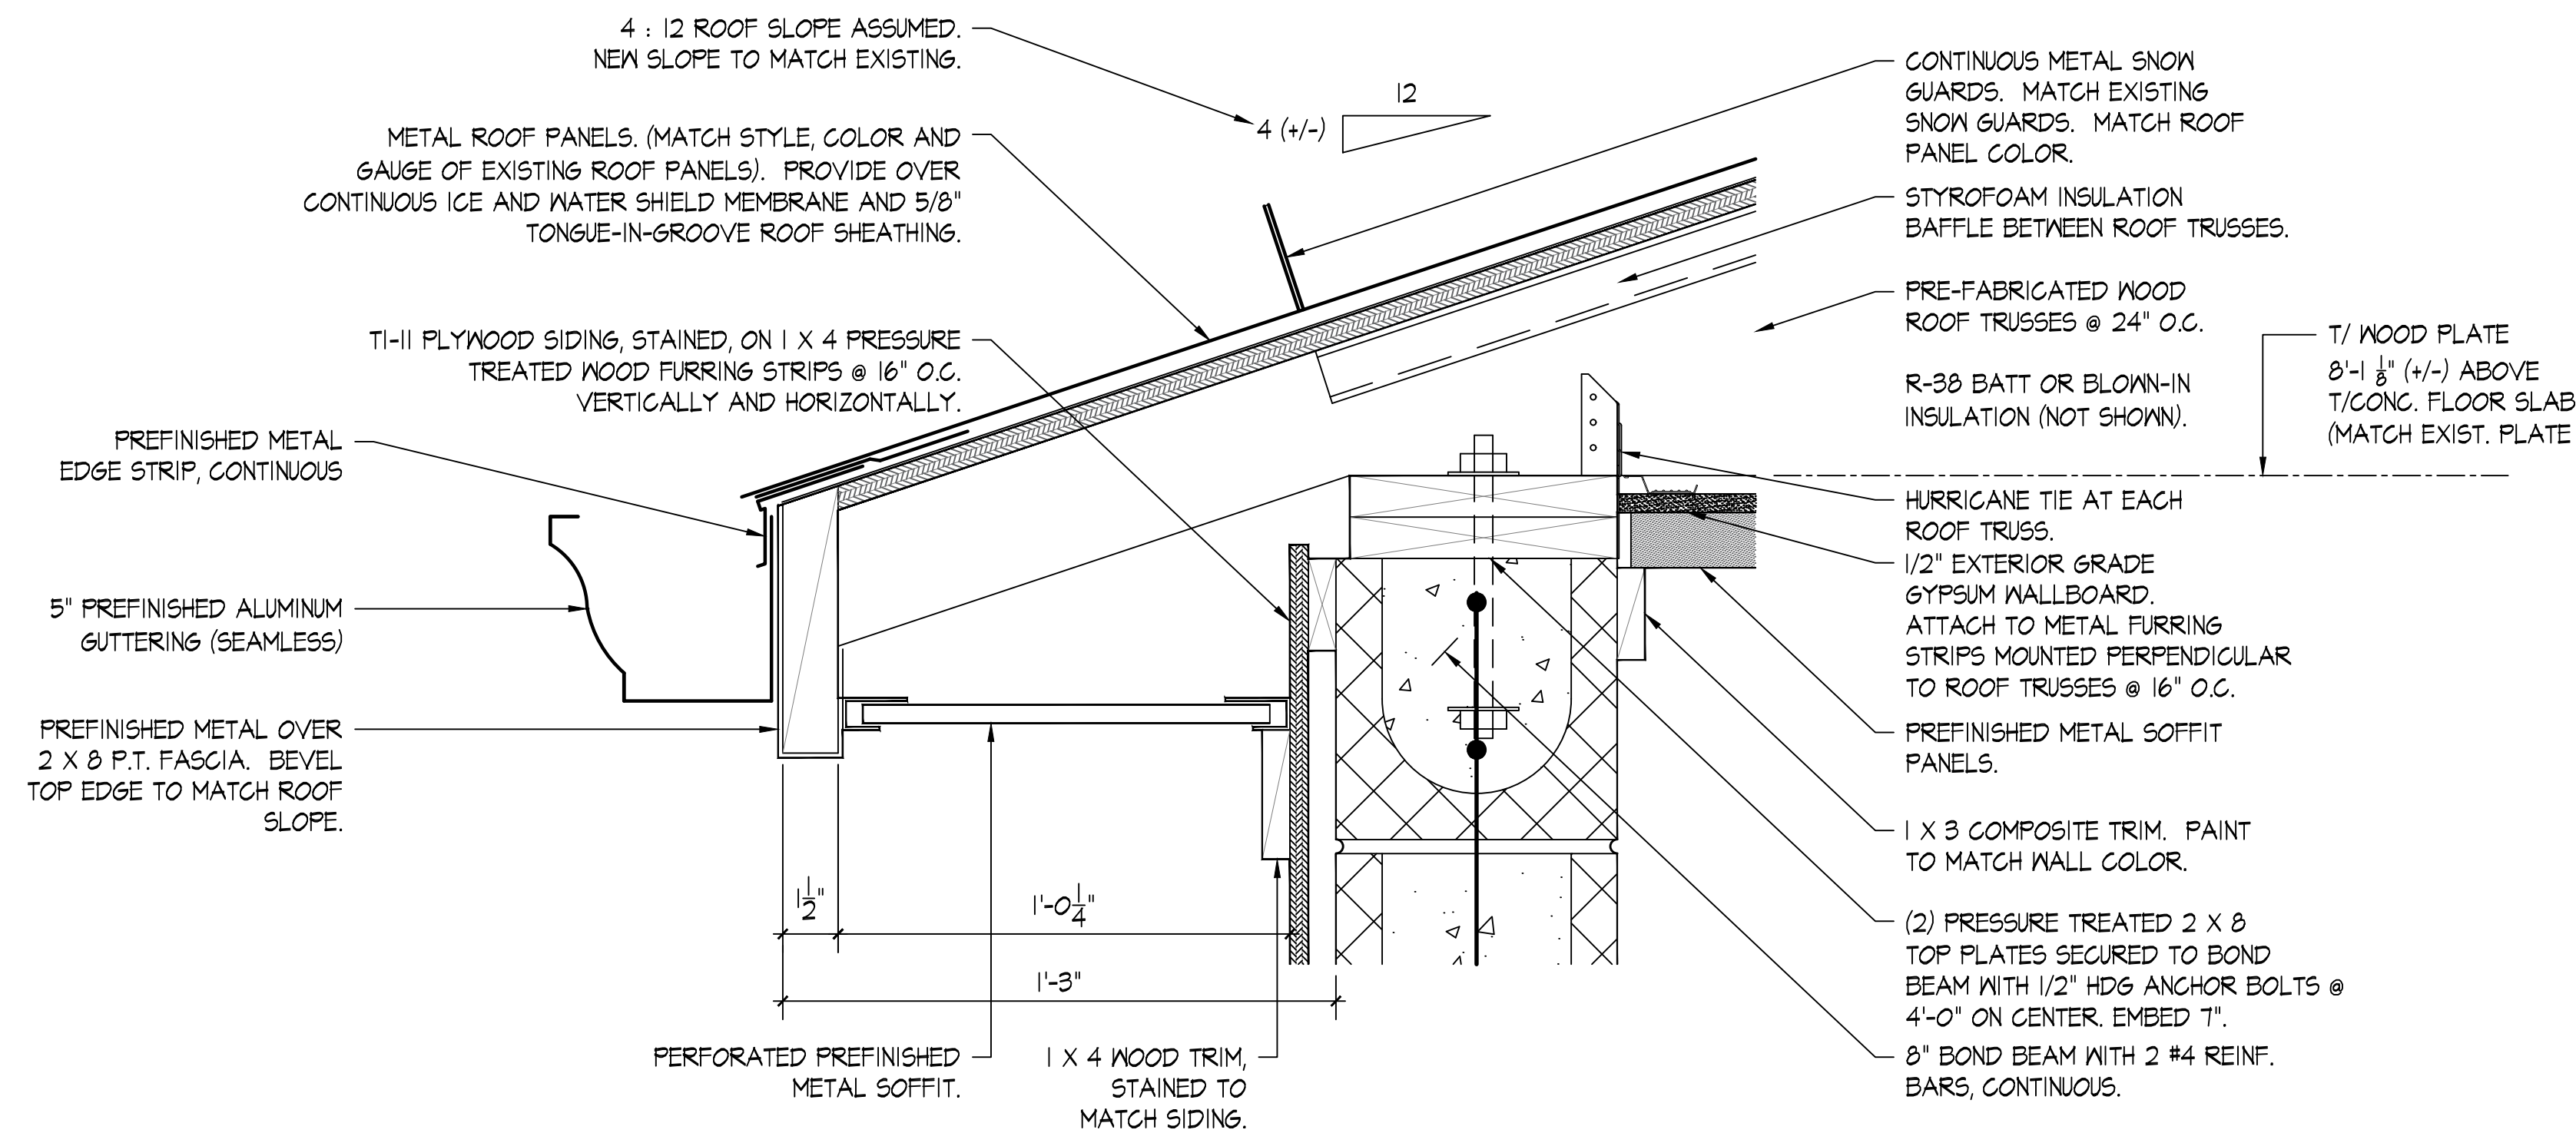2 EXISTING METAL ROOFING TO NEW EPDM MEMBRANE SCALE: 3"=1'-0"




3 TYPICAL EAVE DETAIL SCALE: 3"=1'-0"

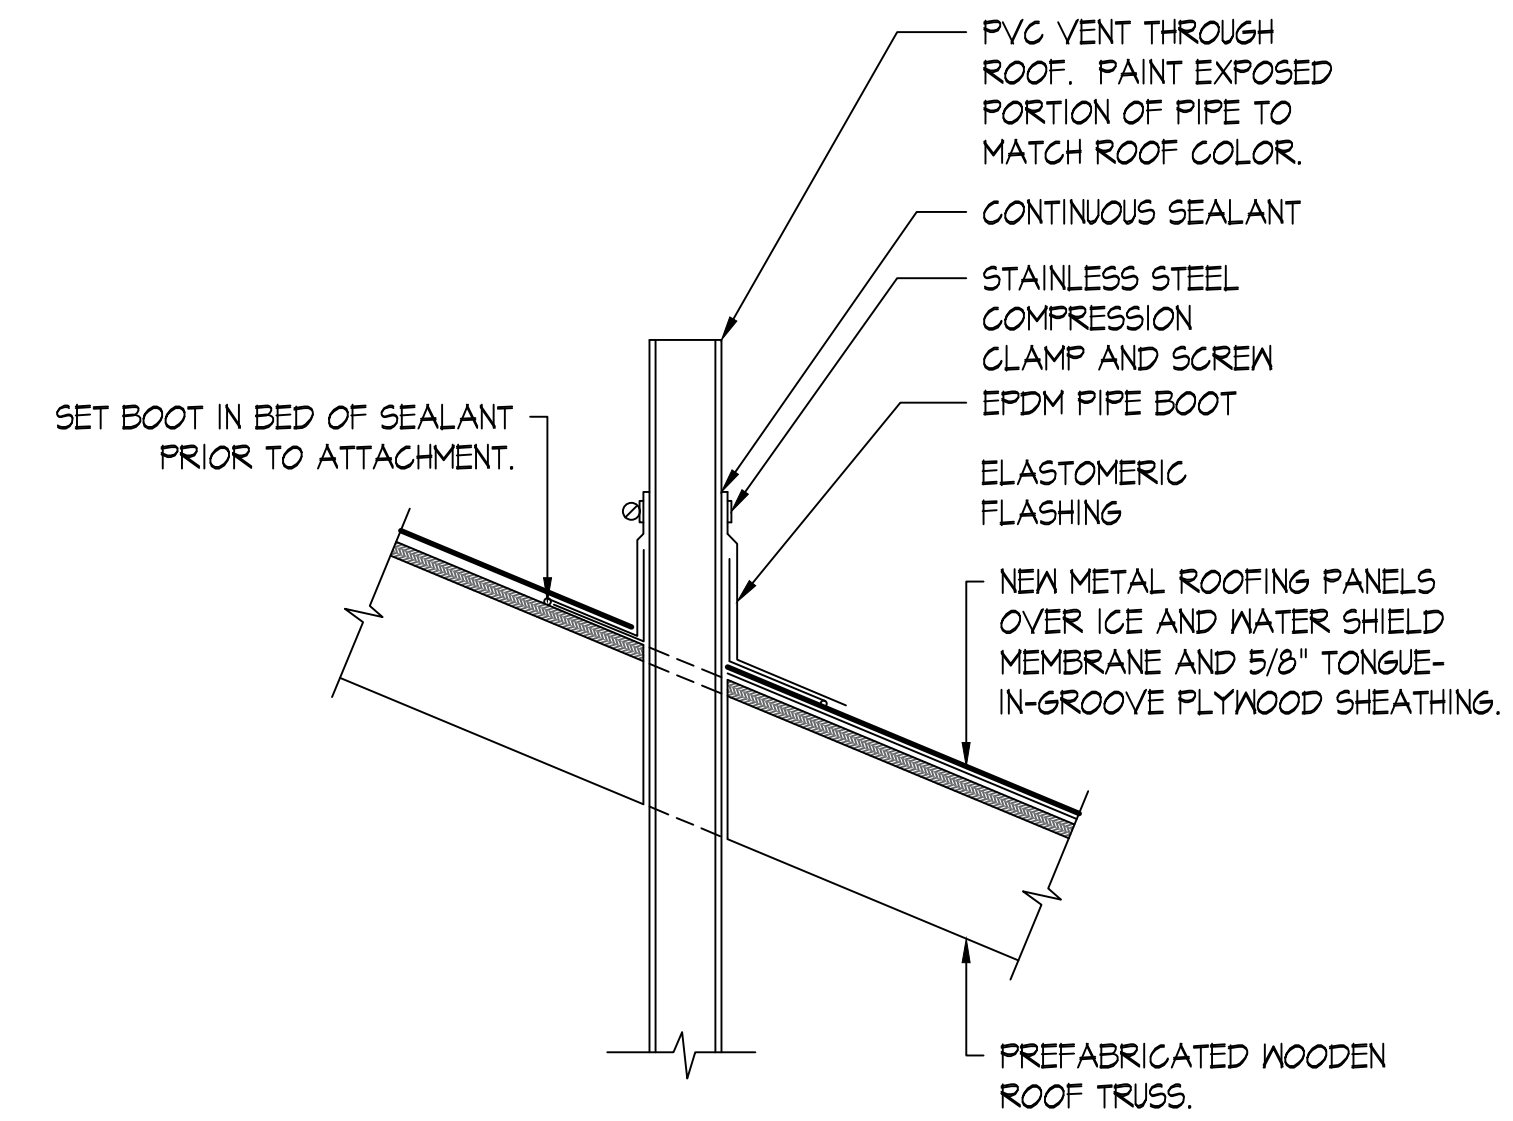


4 TYPICAL PIPE PENETRATION DETAIL AT METAL ROOFING SCALE: 1-1/2"=1'-0"

DATE:	06-30-2023
NO.	REVISION DATE
1	
2	
3	
SHEET:	A122
DRAWN BY:	CHECKED BY:
PROJECT NO.:	TLG-22136
THE LANE GROUP INC.	

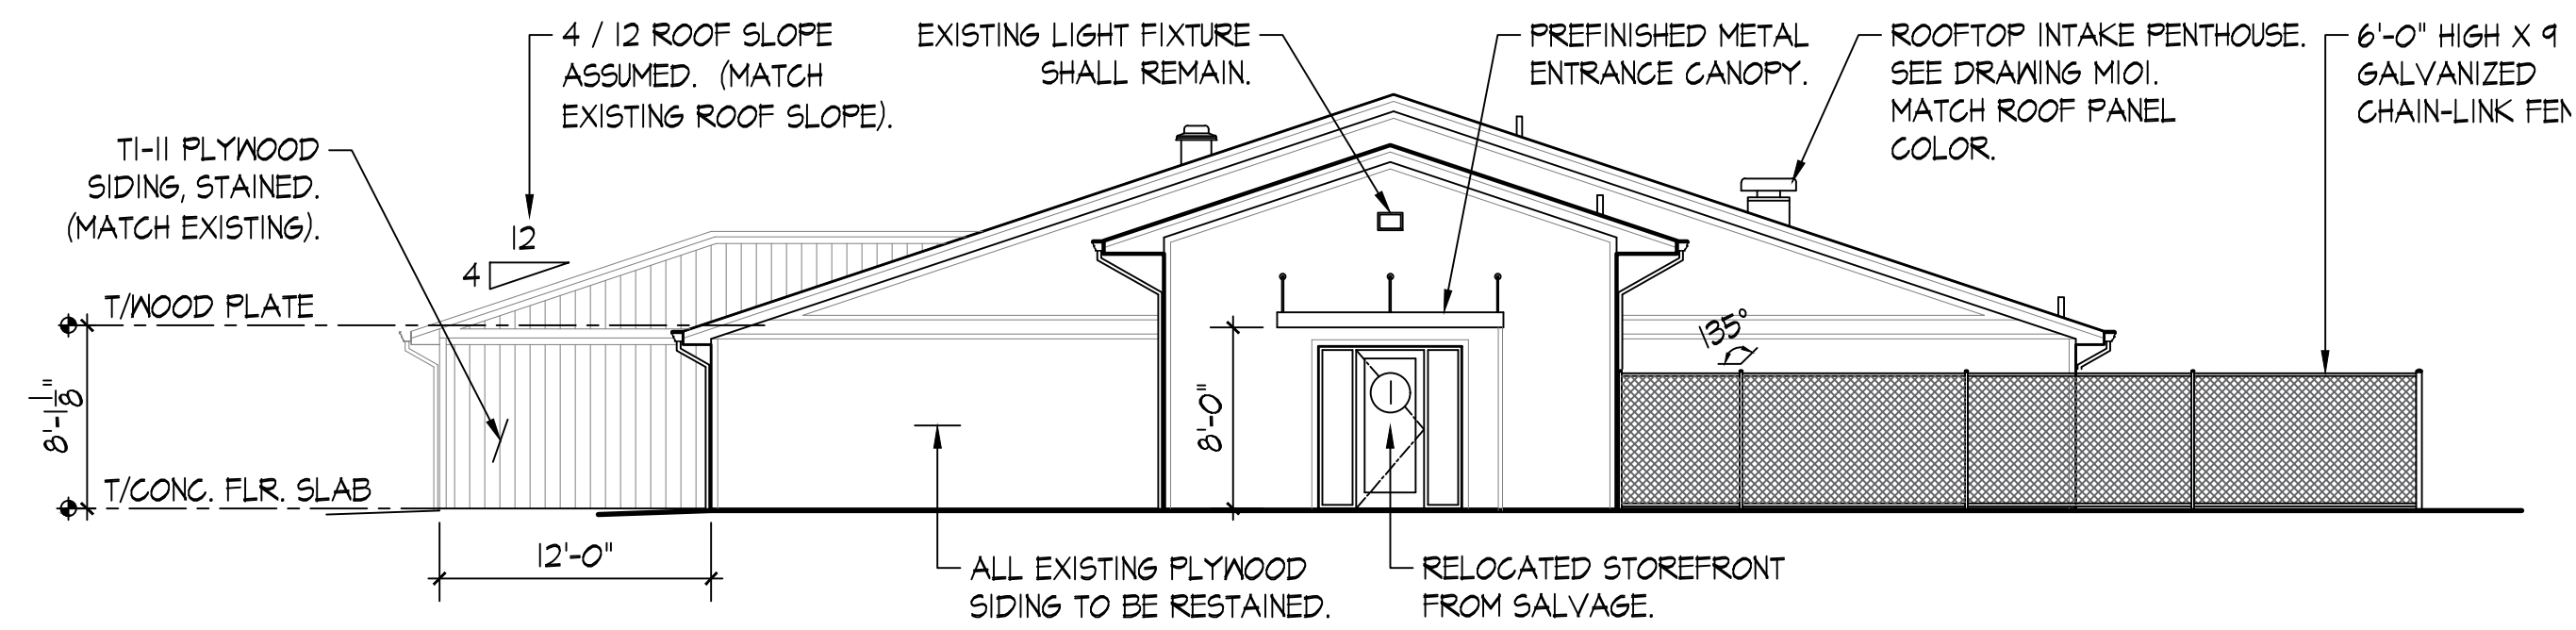

SIDE ELEVATION - WEST

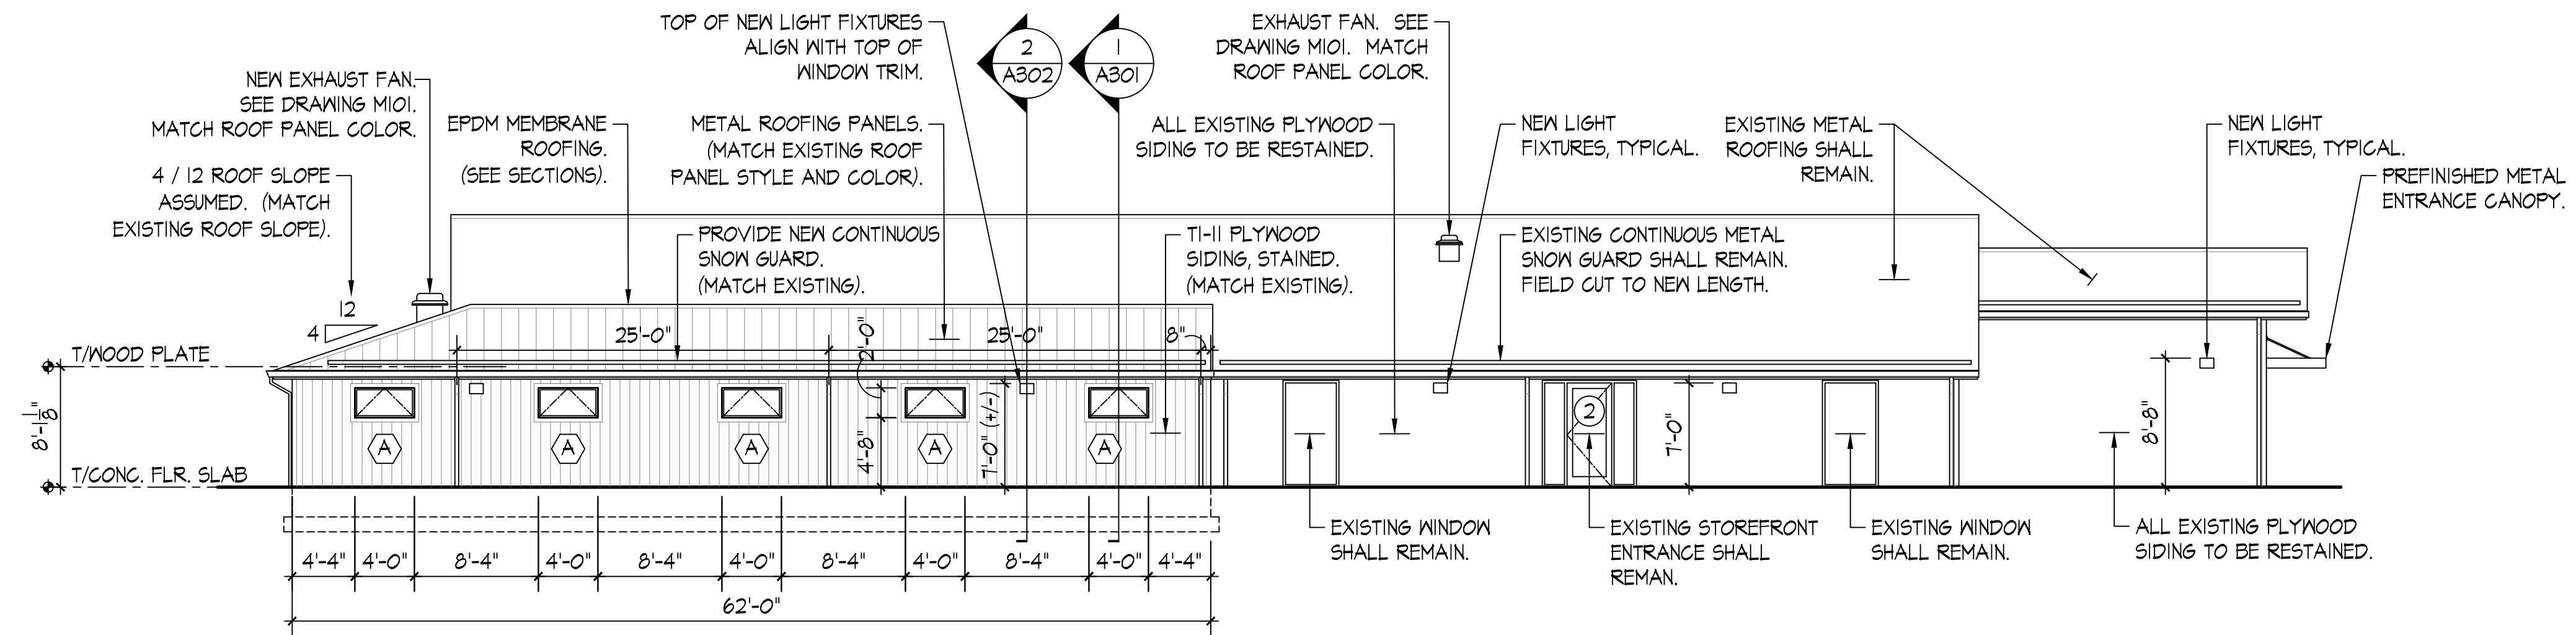SCALE: 1/8" = 1'-0"
 0 4' 8' 16'




FRONT ELEVATION - NORTH (FACING LEE HIGHWAY)

SCALE: 1/8" = 1'-0"
 0 4' 8' 16'

ELEVATIONS




DATE:	06-30-2023
NO.	REVISION DATE
1	
2	
3	
SHEET:	A201
DRAWN BY	CHECKED BY
PROJECT NO.	TLG-22136
THE LANE GROUP INC.	

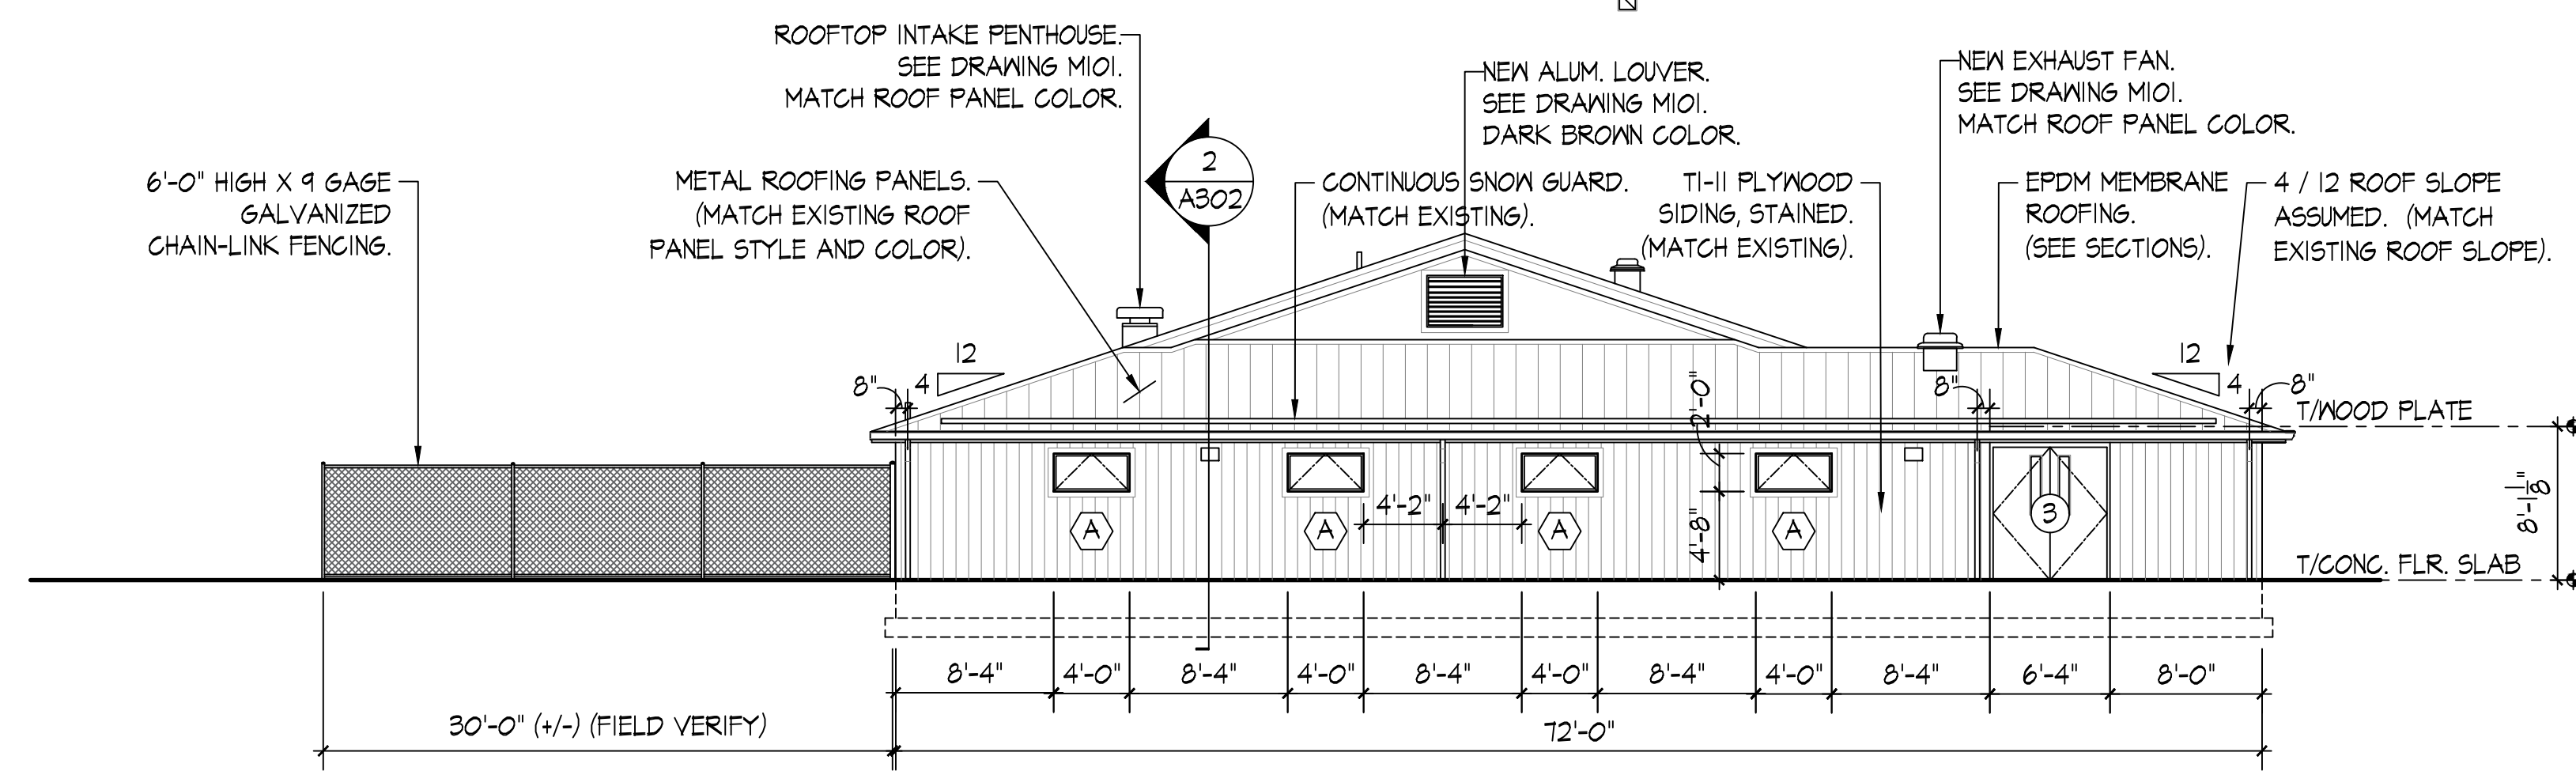

SIDE ELEVATION - EAST

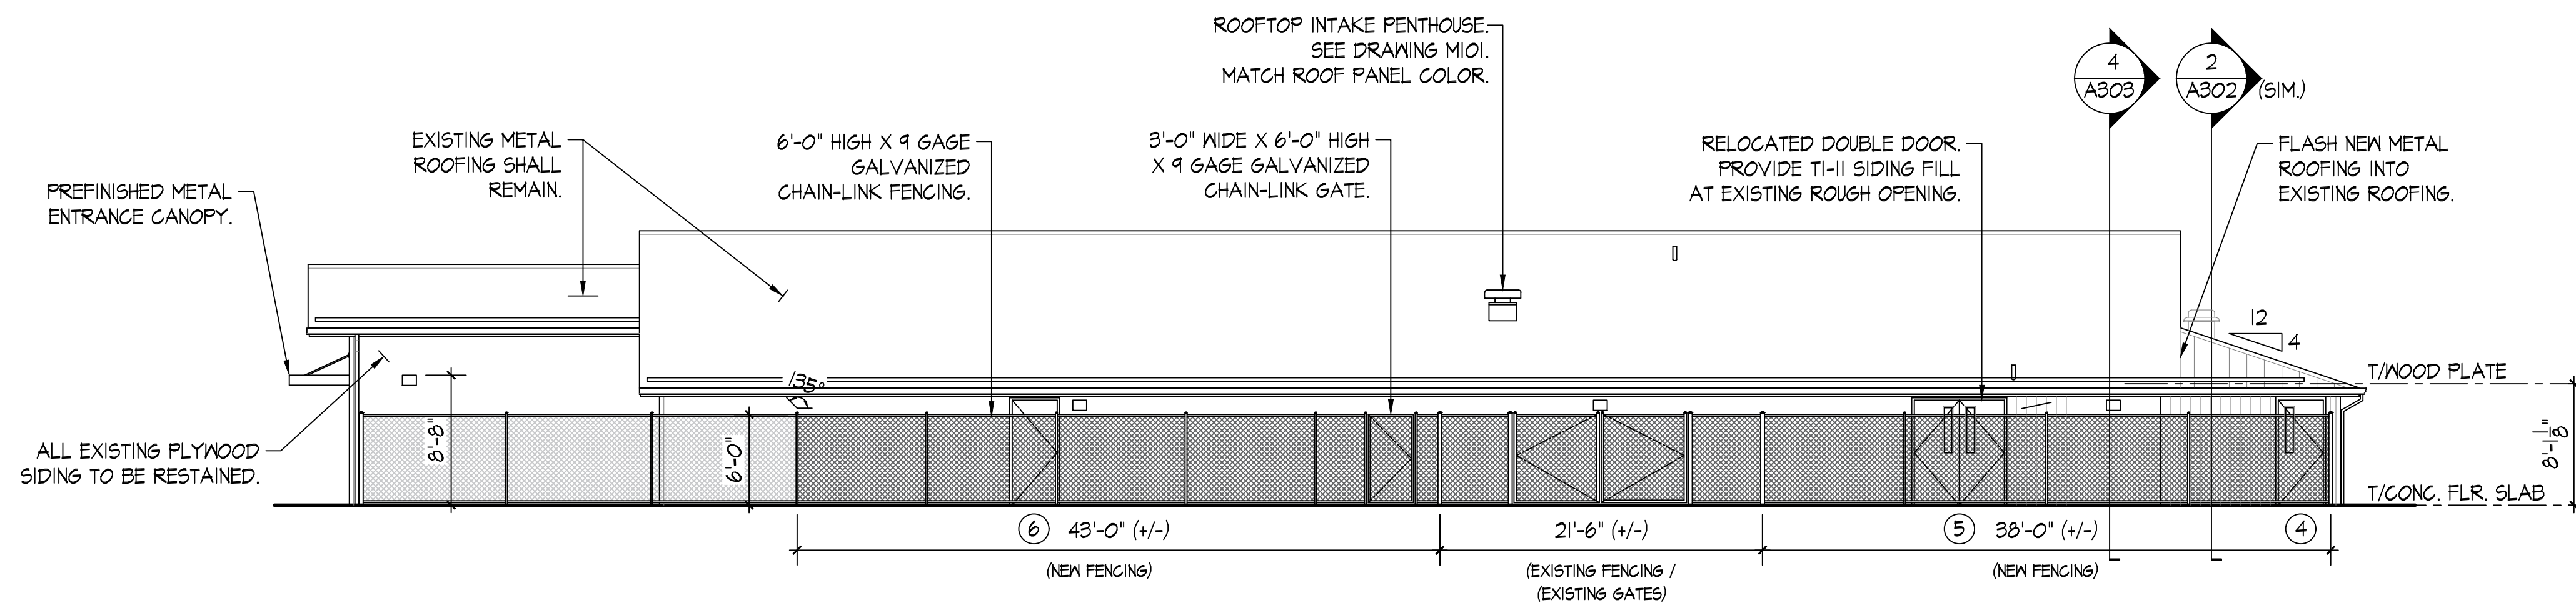SCALE: 1/8" = 1'-0"
 0 4 8 16



REAR ELEVATION - SOUTH

SCALE: 1/8" = 1'-0"
 0 4 8 16



DATE: 06-30-2023

NO.	REVISION DATE
1	
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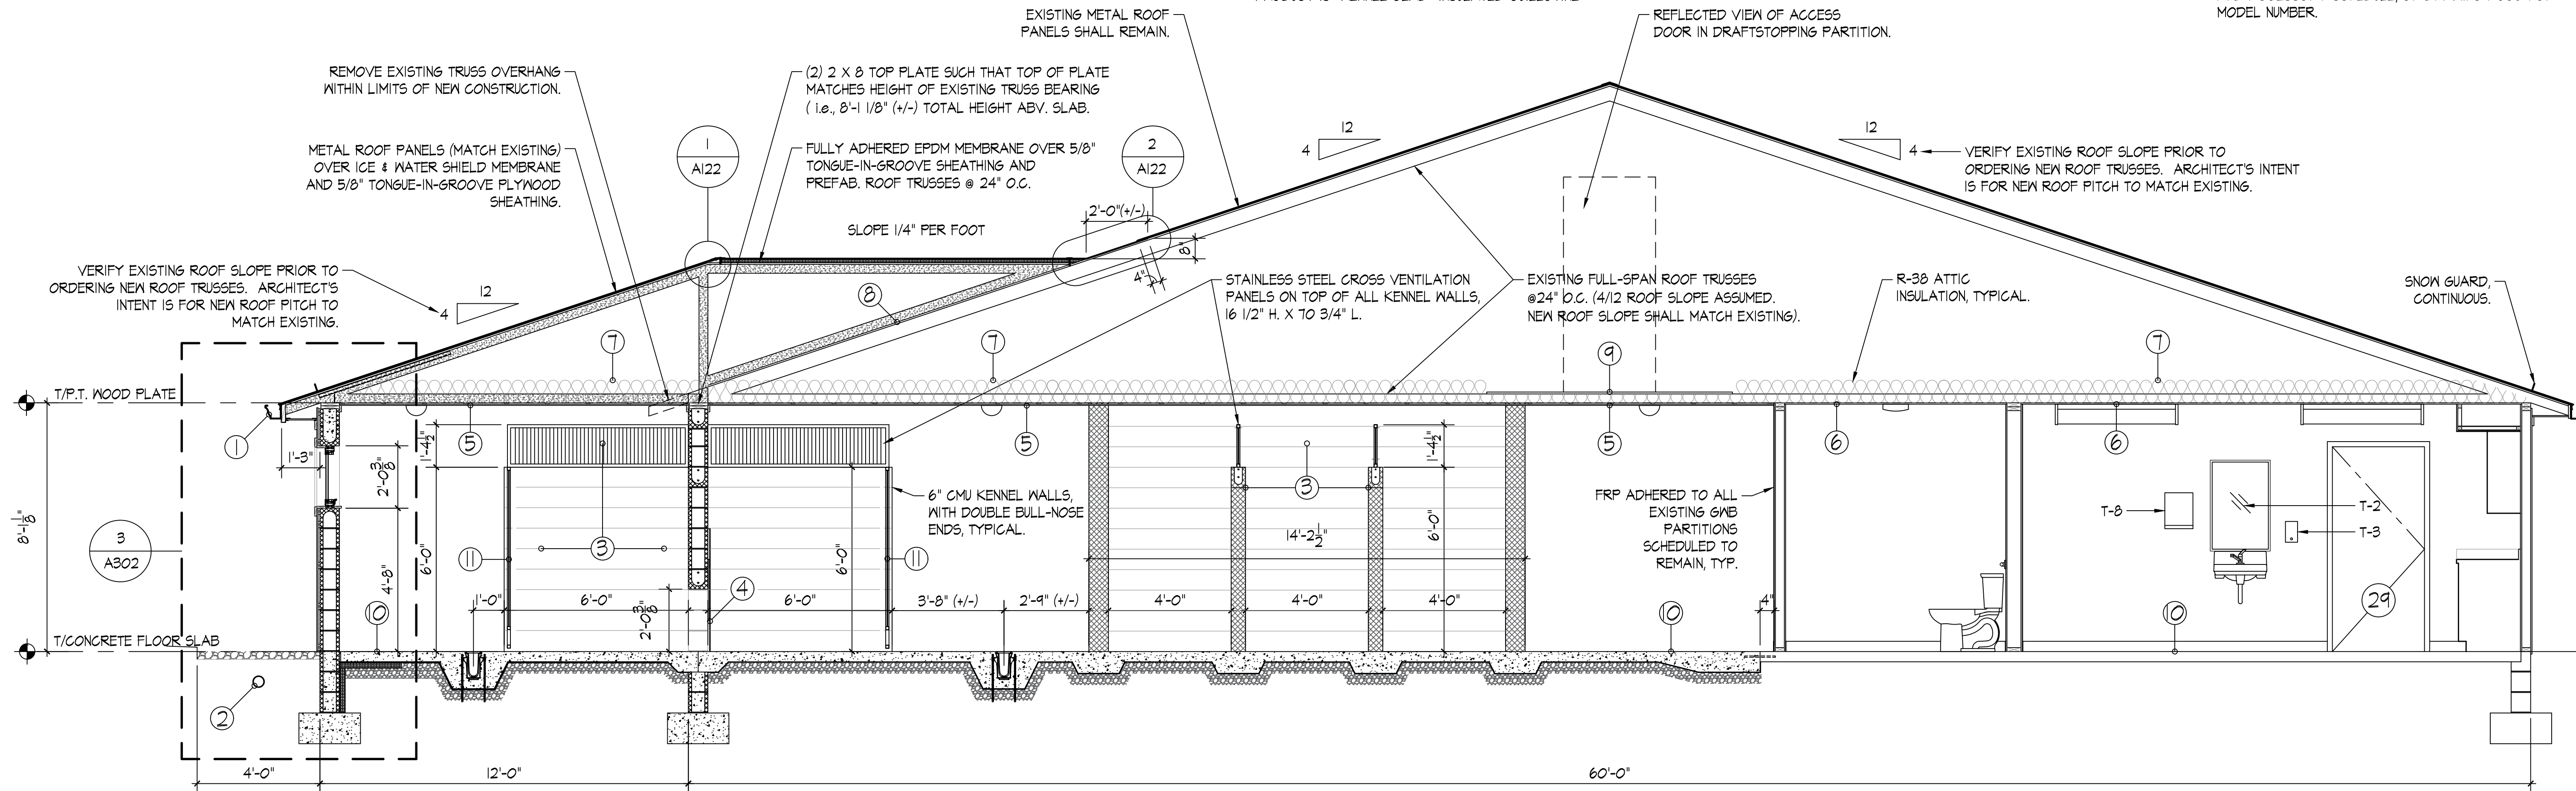
SHEET: **A202**

DRAWN BY: _____ CHECKED BY: _____

PROJECT NO: TLG-22136

BUILDING SECTION KEY NOTES

- ① 6" PREFINISHED ALUMINUM DOWNSPOUT AND SEAMLESS GUTTERING, TYPICAL. CONNECT EACH NEW DOWNSPOUT TO A PVC BOOT. CONNECT PVC BOOT TO UNDERGROUND PVC STORM DRAIN. SEE DRAWING C102 FOR STORM DRAIN LAYOUT.
- ② 4" DIAMETER PVC STORM DRAIN. SEE DRAWING C102 FOR LAYOUT.
- ③ 6" x 6'-0" HIGH EPOXY PAINTED CMU. PROVIDE BULL-NOSED ENDS. PROVIDE STAINLESS STEEL CROSS VENTILATION PANELS TO FROM TOP OF CMU TO 1'-4 1/2" ABOVE TOP OF CONCRETE FLOOR SLAB.
- ④ INSULATED GUILLOTINE TYPE DOG DOORS AT CENTERLINE OF EACH KENNEL. PROVIDE 16" WIDE x 24" HIGH MASONRY OPENING. USE END BLOCKS AT EACH OPENING. BEAR LINTEL ABOVE OPENINGS 1'-0 3/4" ON EACH JAMB. BASIS OF DESIGN PRODUCT IS "KENNEL CLAD" INSULATED GUILLOTINE
- ⑤ KENNEL DOORS AS MANUFACTURED BY SECURITY BOSS. PROVIDE 18 GA. ALUMINUM CLAD INSULATED PANEL DOOR WITH A HIDDEN FLOOR SEAL AND A HIDDEN TOP WALL SEAL. PROVIDE HEAVY-DUTY CHANNEL SIDE RAILS, 2 1/2" WIDE x 48" LONG.
- ⑥ PROVIDE PREFINISHED PERFORATED METAL SOFFIT BOARD CEILINGS IN DOG KENNEL AREAS, TYP.
- ⑦ PROVIDE 1/2" EXTERIOR SOFFIT GYPSUM BOARD, SMOOTH PAINTED FINISH. AT INTERIOR, ATTACH SOFFIT BOARD TO METAL FURRING CHANNELS LOCATED PERPENDICULAR TO ROOF TRUSSES @ 16" ON CENTER.
- ⑧ R-38 BATT INSULATION ABOVE ALL OCCUPIED AREAS. PROVIDE INSULATION BAFFLE BETWEEN WOOD ROOF TRUSSES AT THE TOP OF EACH EXTERIOR WALL.
- ⑨ DRILL (2) 2" DIAMETER HOLES IN EXISTING SHEATHING BETWEEN EACH NEW TRUSS TO VENT NEW ATTIC AREA BELOW EPDM MEMBRANE. STAPLE 18 X 16 SCREEN MESH OVER EACH HOLE.
- ⑩ EXISTING PLYWOOD WALKWAY IN EXISTING ATTIC. SWEEP / VACUUM TO REMOVE ALL DEBRIS.
- ⑪ PROVIDE RESINOUS FLOOR FINISH ON SMOOTH CONCRETE FLOOR SLAB. BASIS OF DESIGN PRODUCT IS "RESUFLOOR TOPCOAT TX" AS MANUFACTURED BY THE SHERWIN WILLIAMS COMPANY. TURN FINISH UP 8" AT EACH CMU WALL.
- ⑫ STAINLESS STEEL KENNEL DOOR WITH ROTATING FOOD BOWL SYSTEM SHALL BE AS MANUFACTURED BY DIRECT ANIMAL PRODUCTS, INC. SEE APPLIANCE AND ACCESSORY SCHEDULE, ON DRAWING A603 FOR MODEL NUMBER.




1 BUILDING SECTION
 A301 SCALE: 3/8" = 1'-0"
 0 2 4 6

BUILDING RENOVATION FOR
WASHINGTON COUNTY, VIRGINIA
ANIMAL SHELTER
 15050 LEE HIGHWAY
 BRISTOL, VIRGINIA 24201


BUILDING SECTION



DATE: 06-30-2023	
NO.	REVISION DATE
1	
2	
3	
SHEET: A301	
DRAWN BY	CHECKED BY
PROJECT NO. TLG-22136	
THE LANE GROUP INC.	

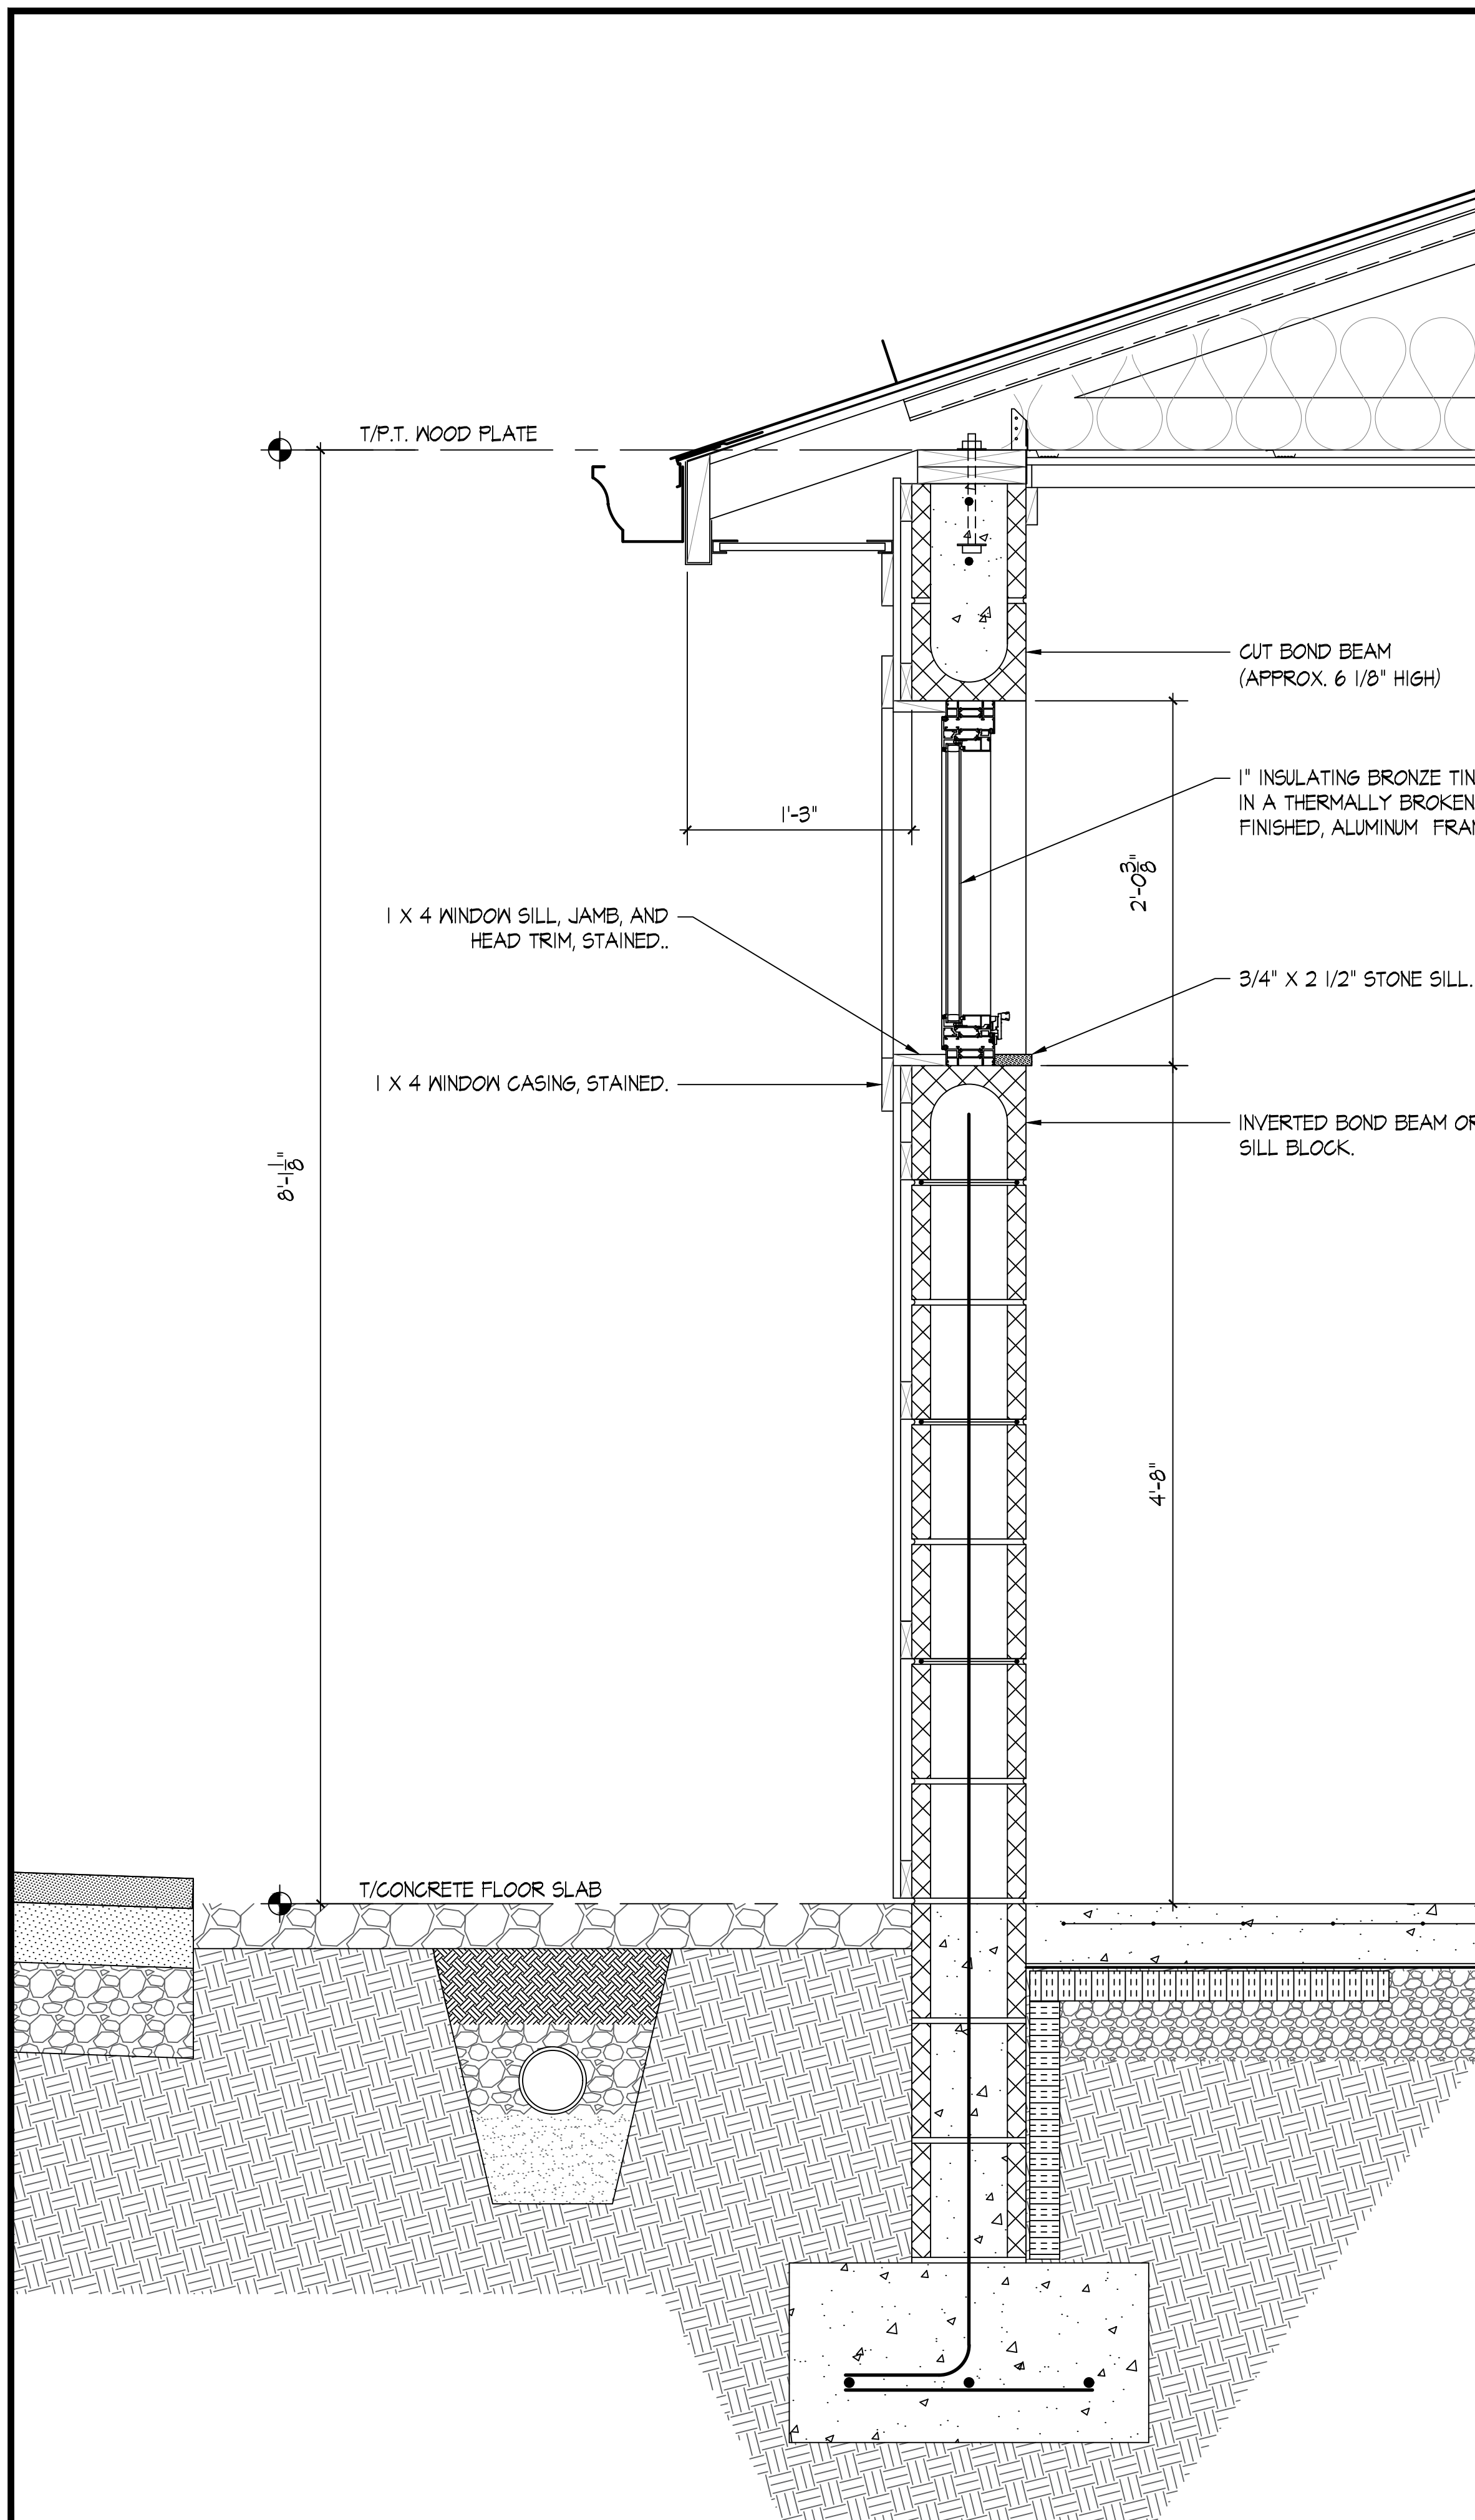


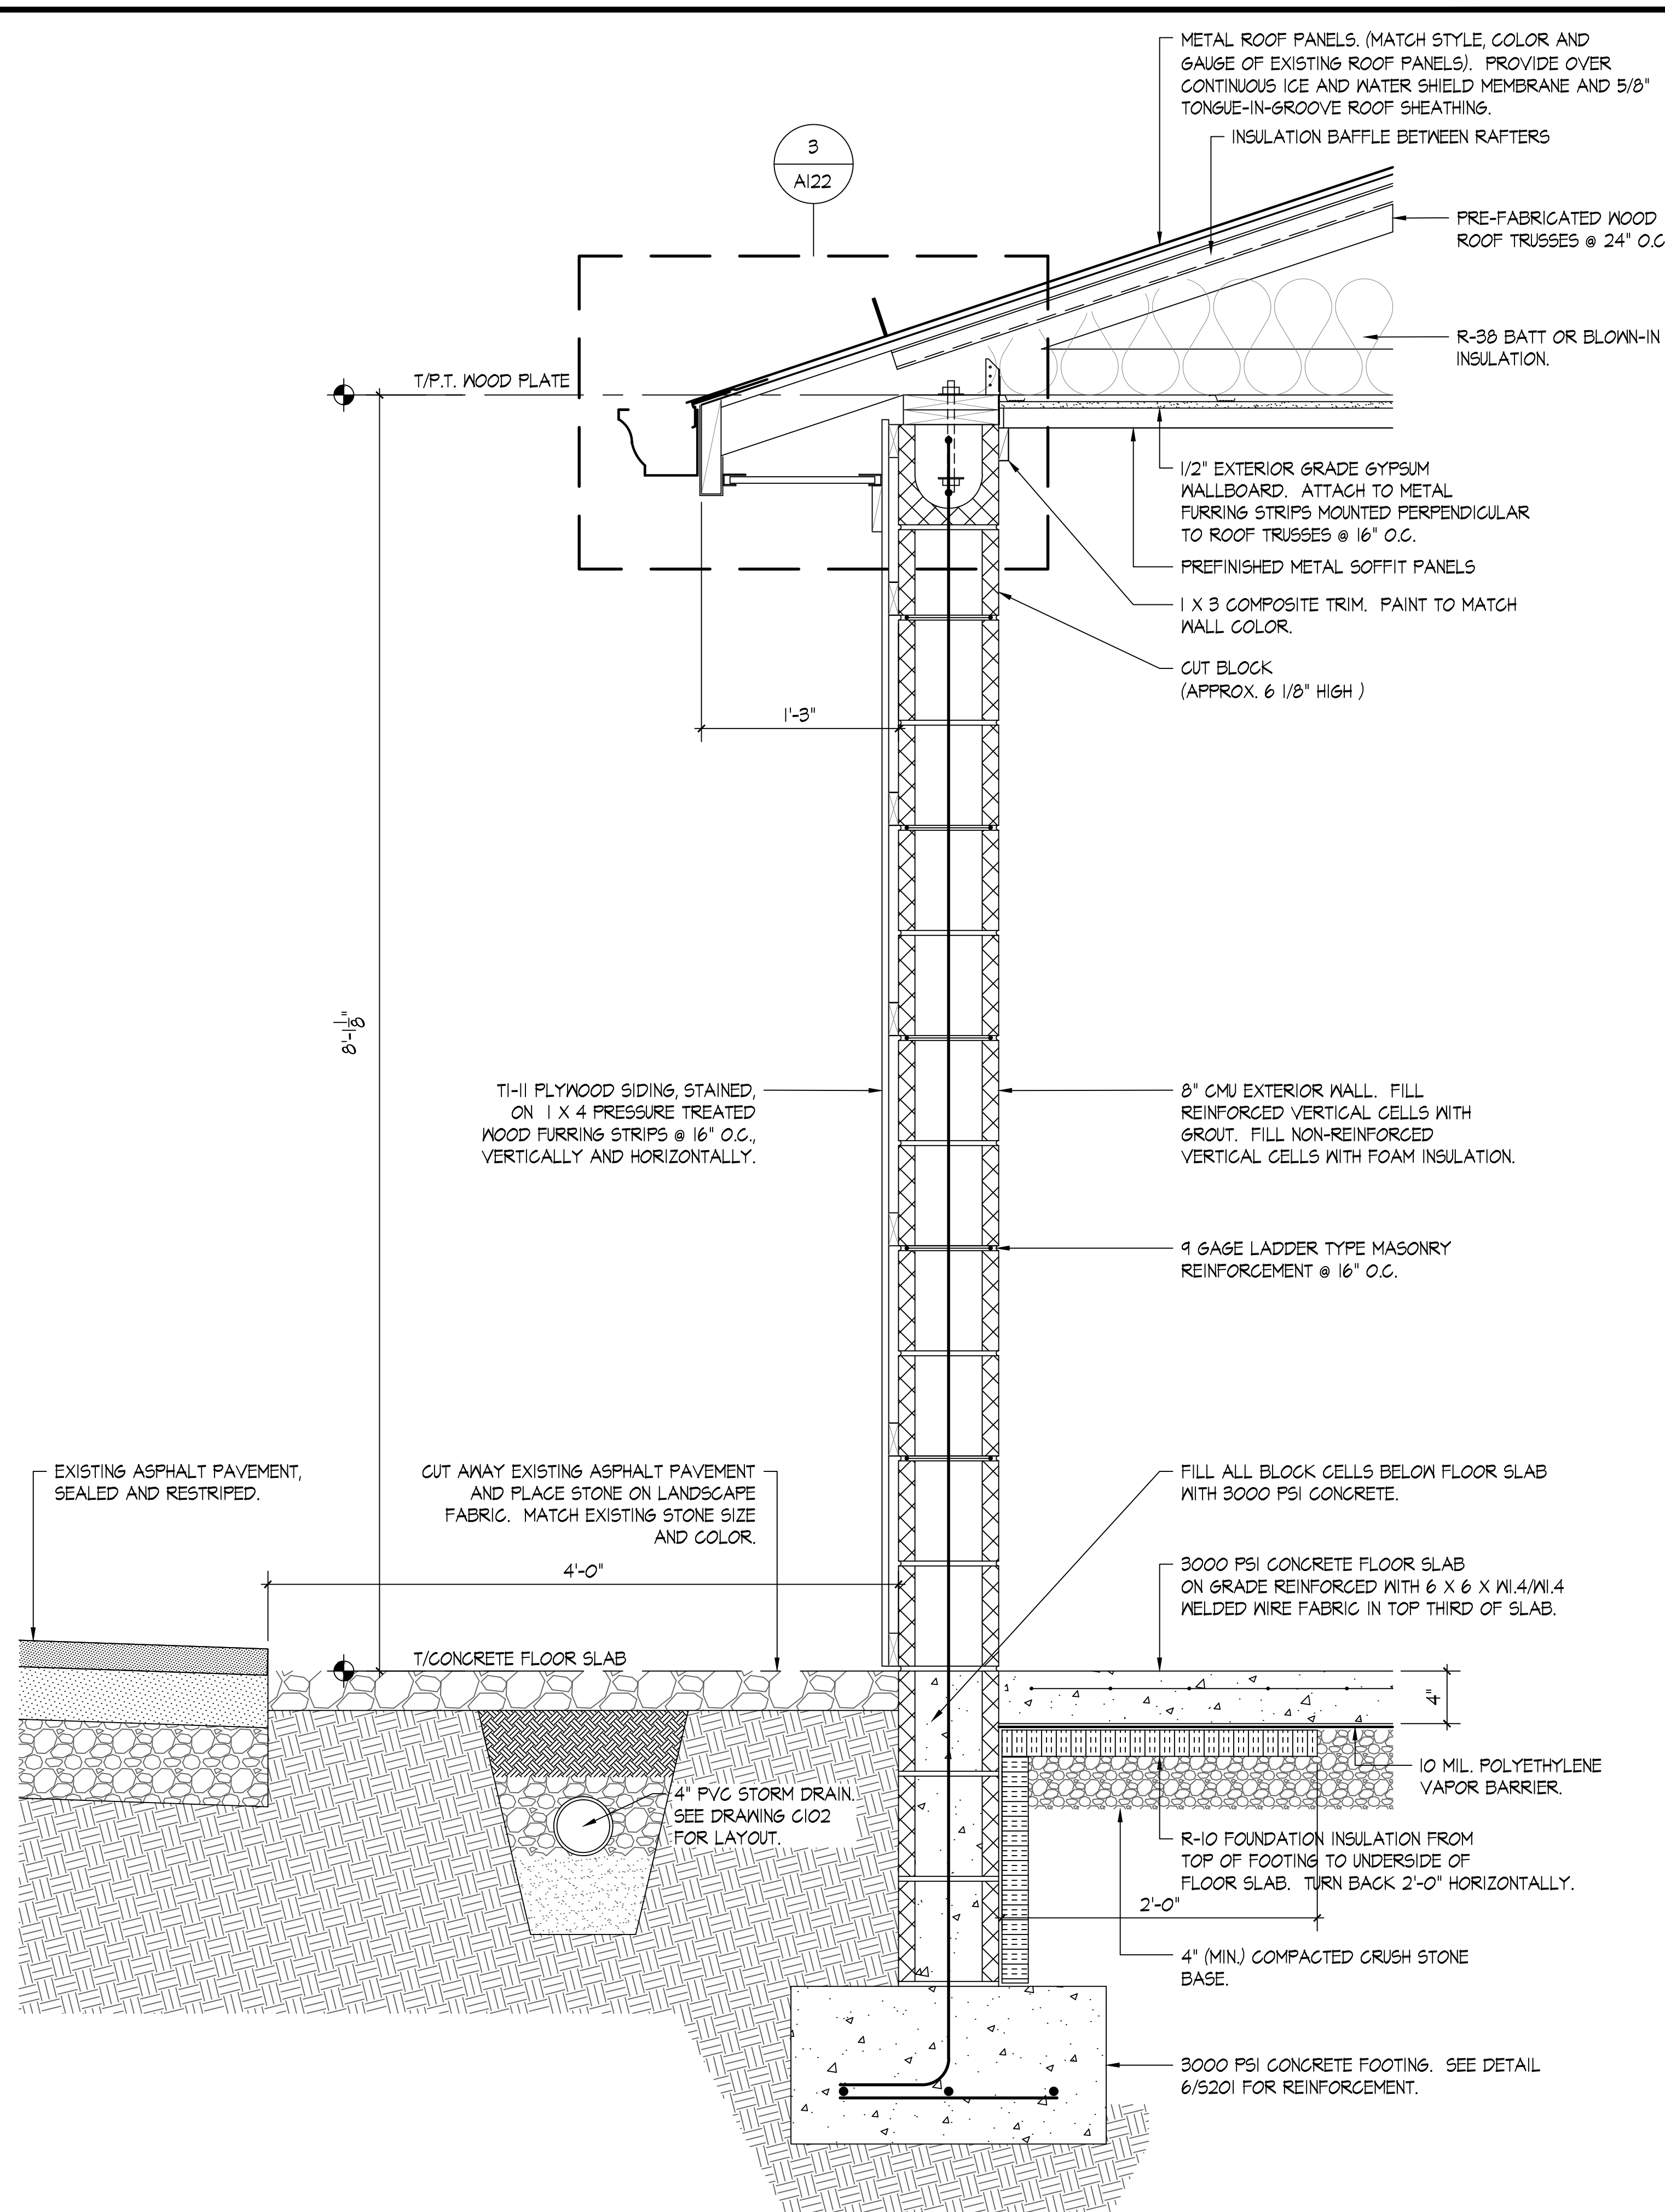3 WALL SECTION AT WINDOW
 SCALE: 1 1/2" = 1'-0"
 0 1/2" 1" 1 1/2"



2 TYPICAL WALL SECTION
 SCALE: 1 1/2" = 1'-0"
 0 1/2" 1" 1 1/2"


DATE:	06-30-2023
NO.	REVISION DATE
1	
2	
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SHEET:	A302
DRAWN BY:	CHECKED BY:
PROJECT NO.:	TLG-22136
THE LANE GROUP INC.	

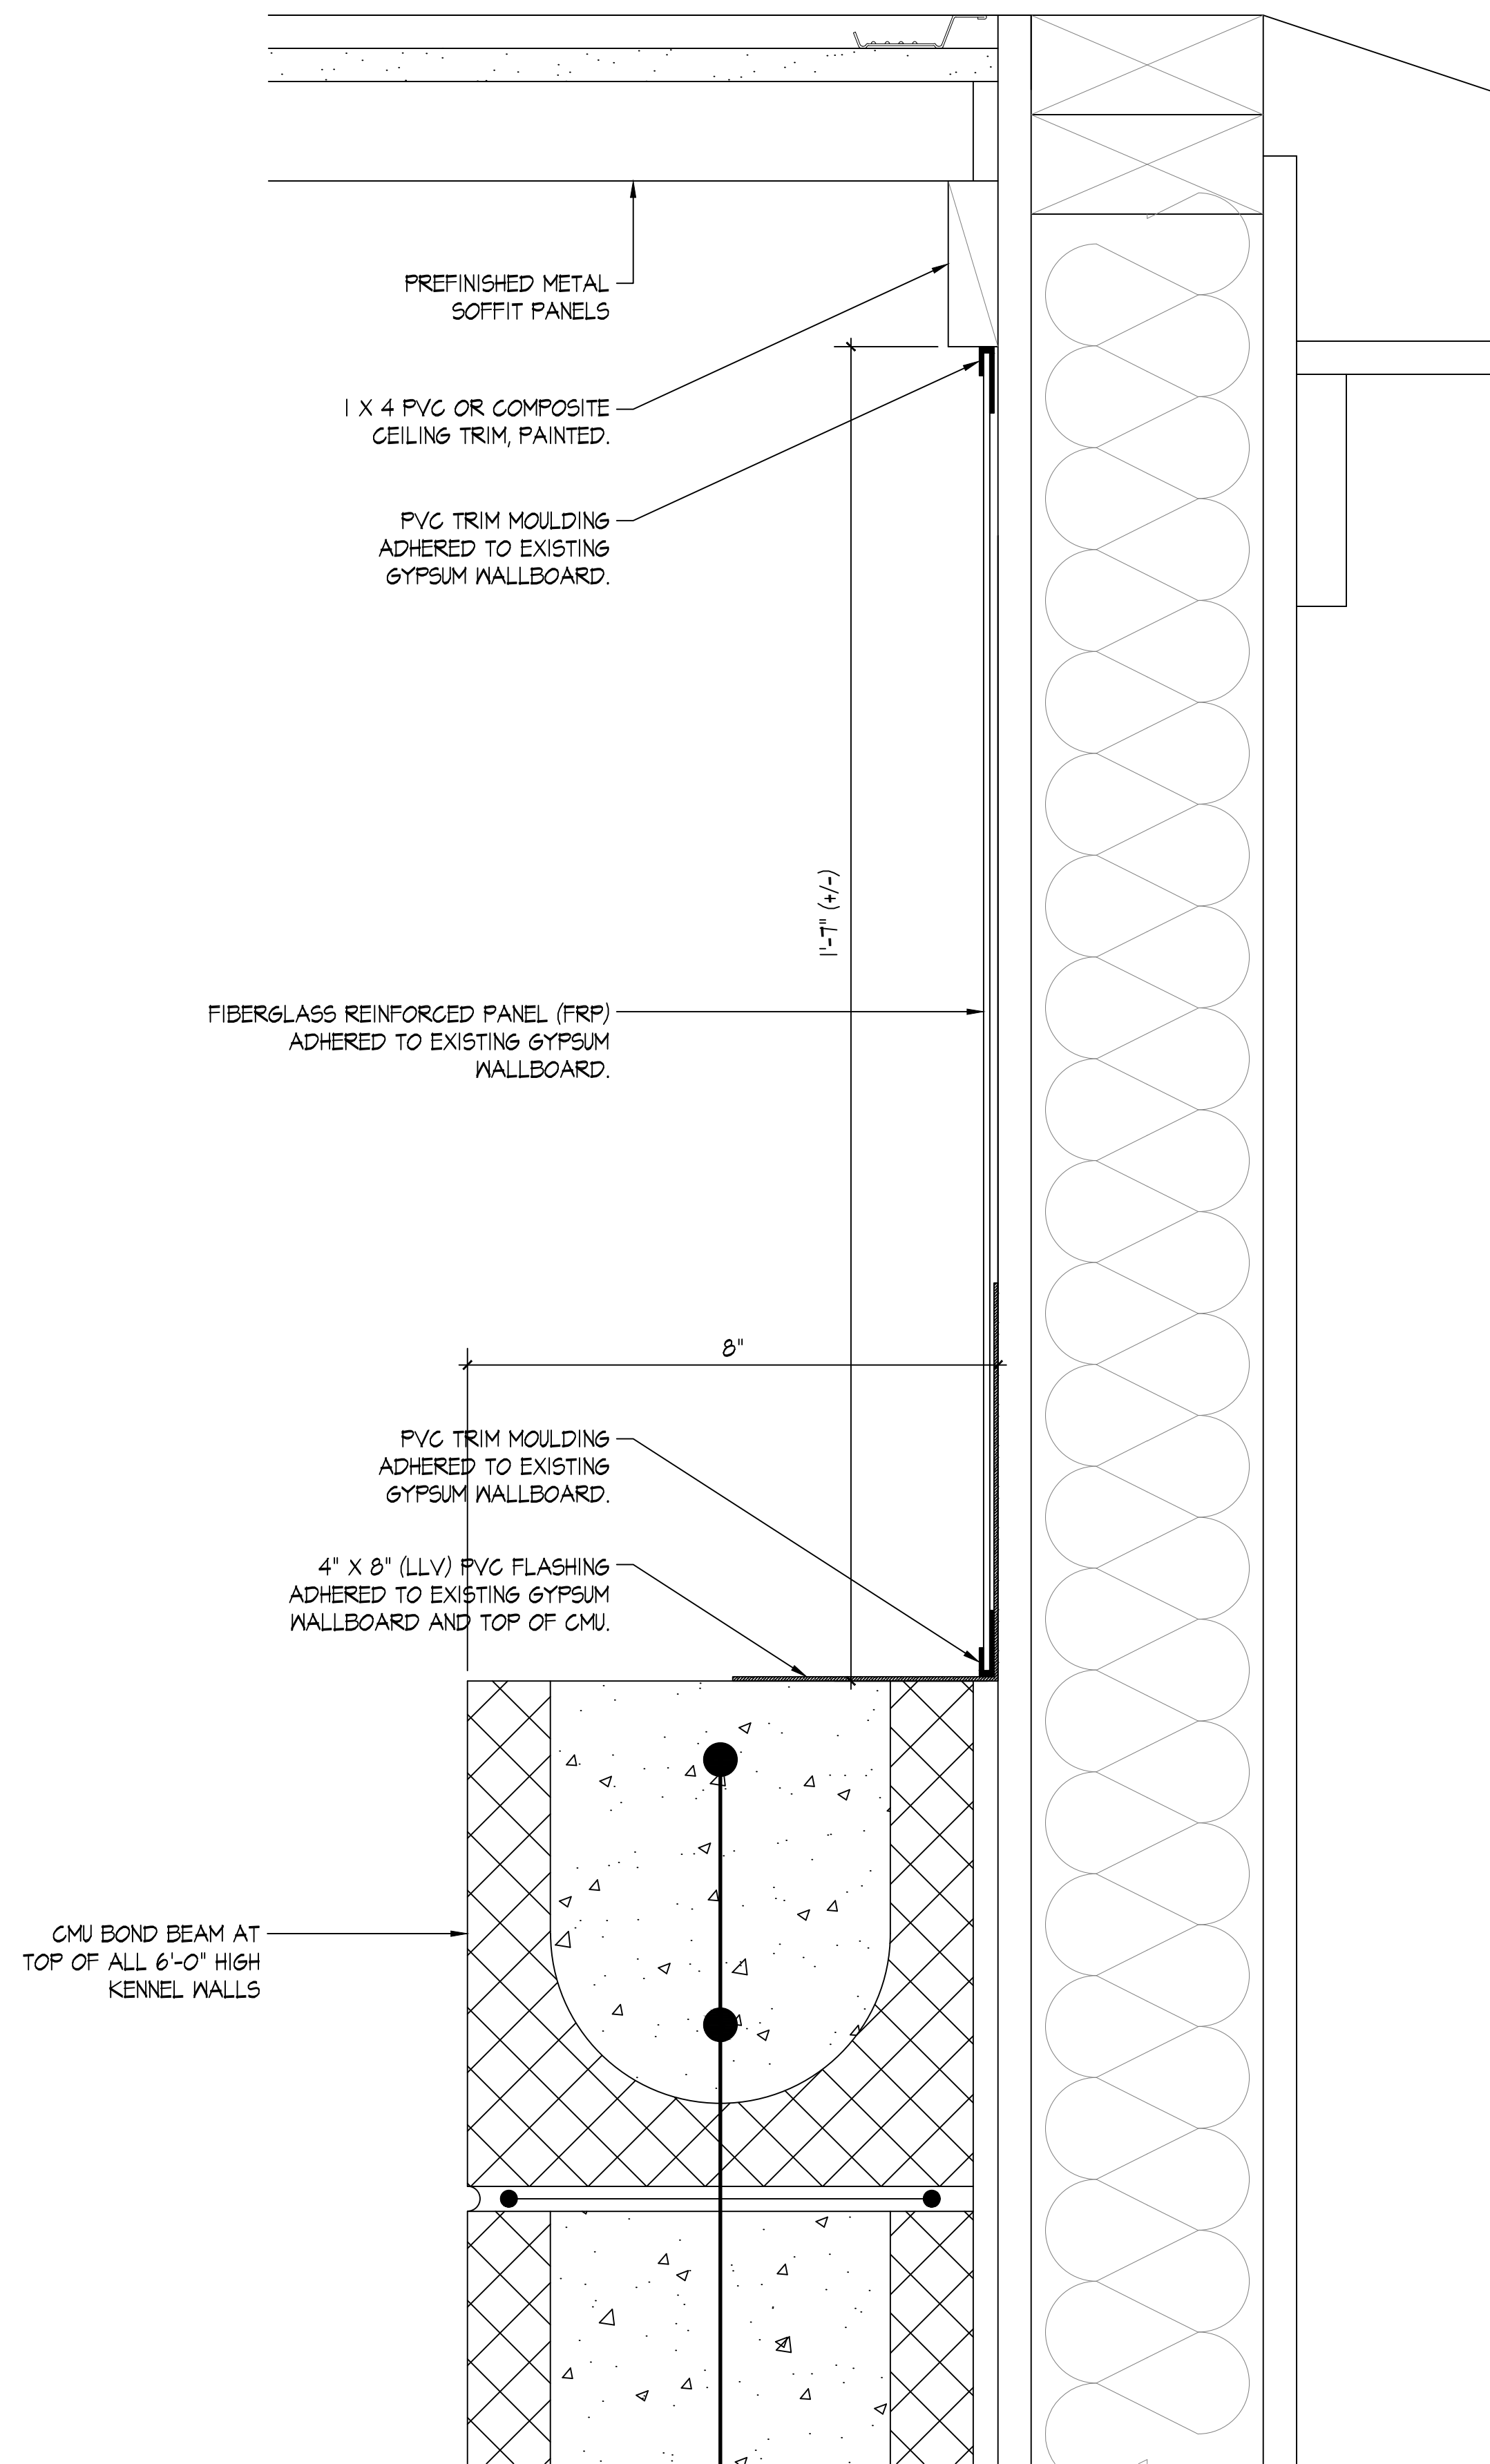

TOP OF KENNEL WALL DETAIL AT EXISTING EXTERIOR WALL

5
A303

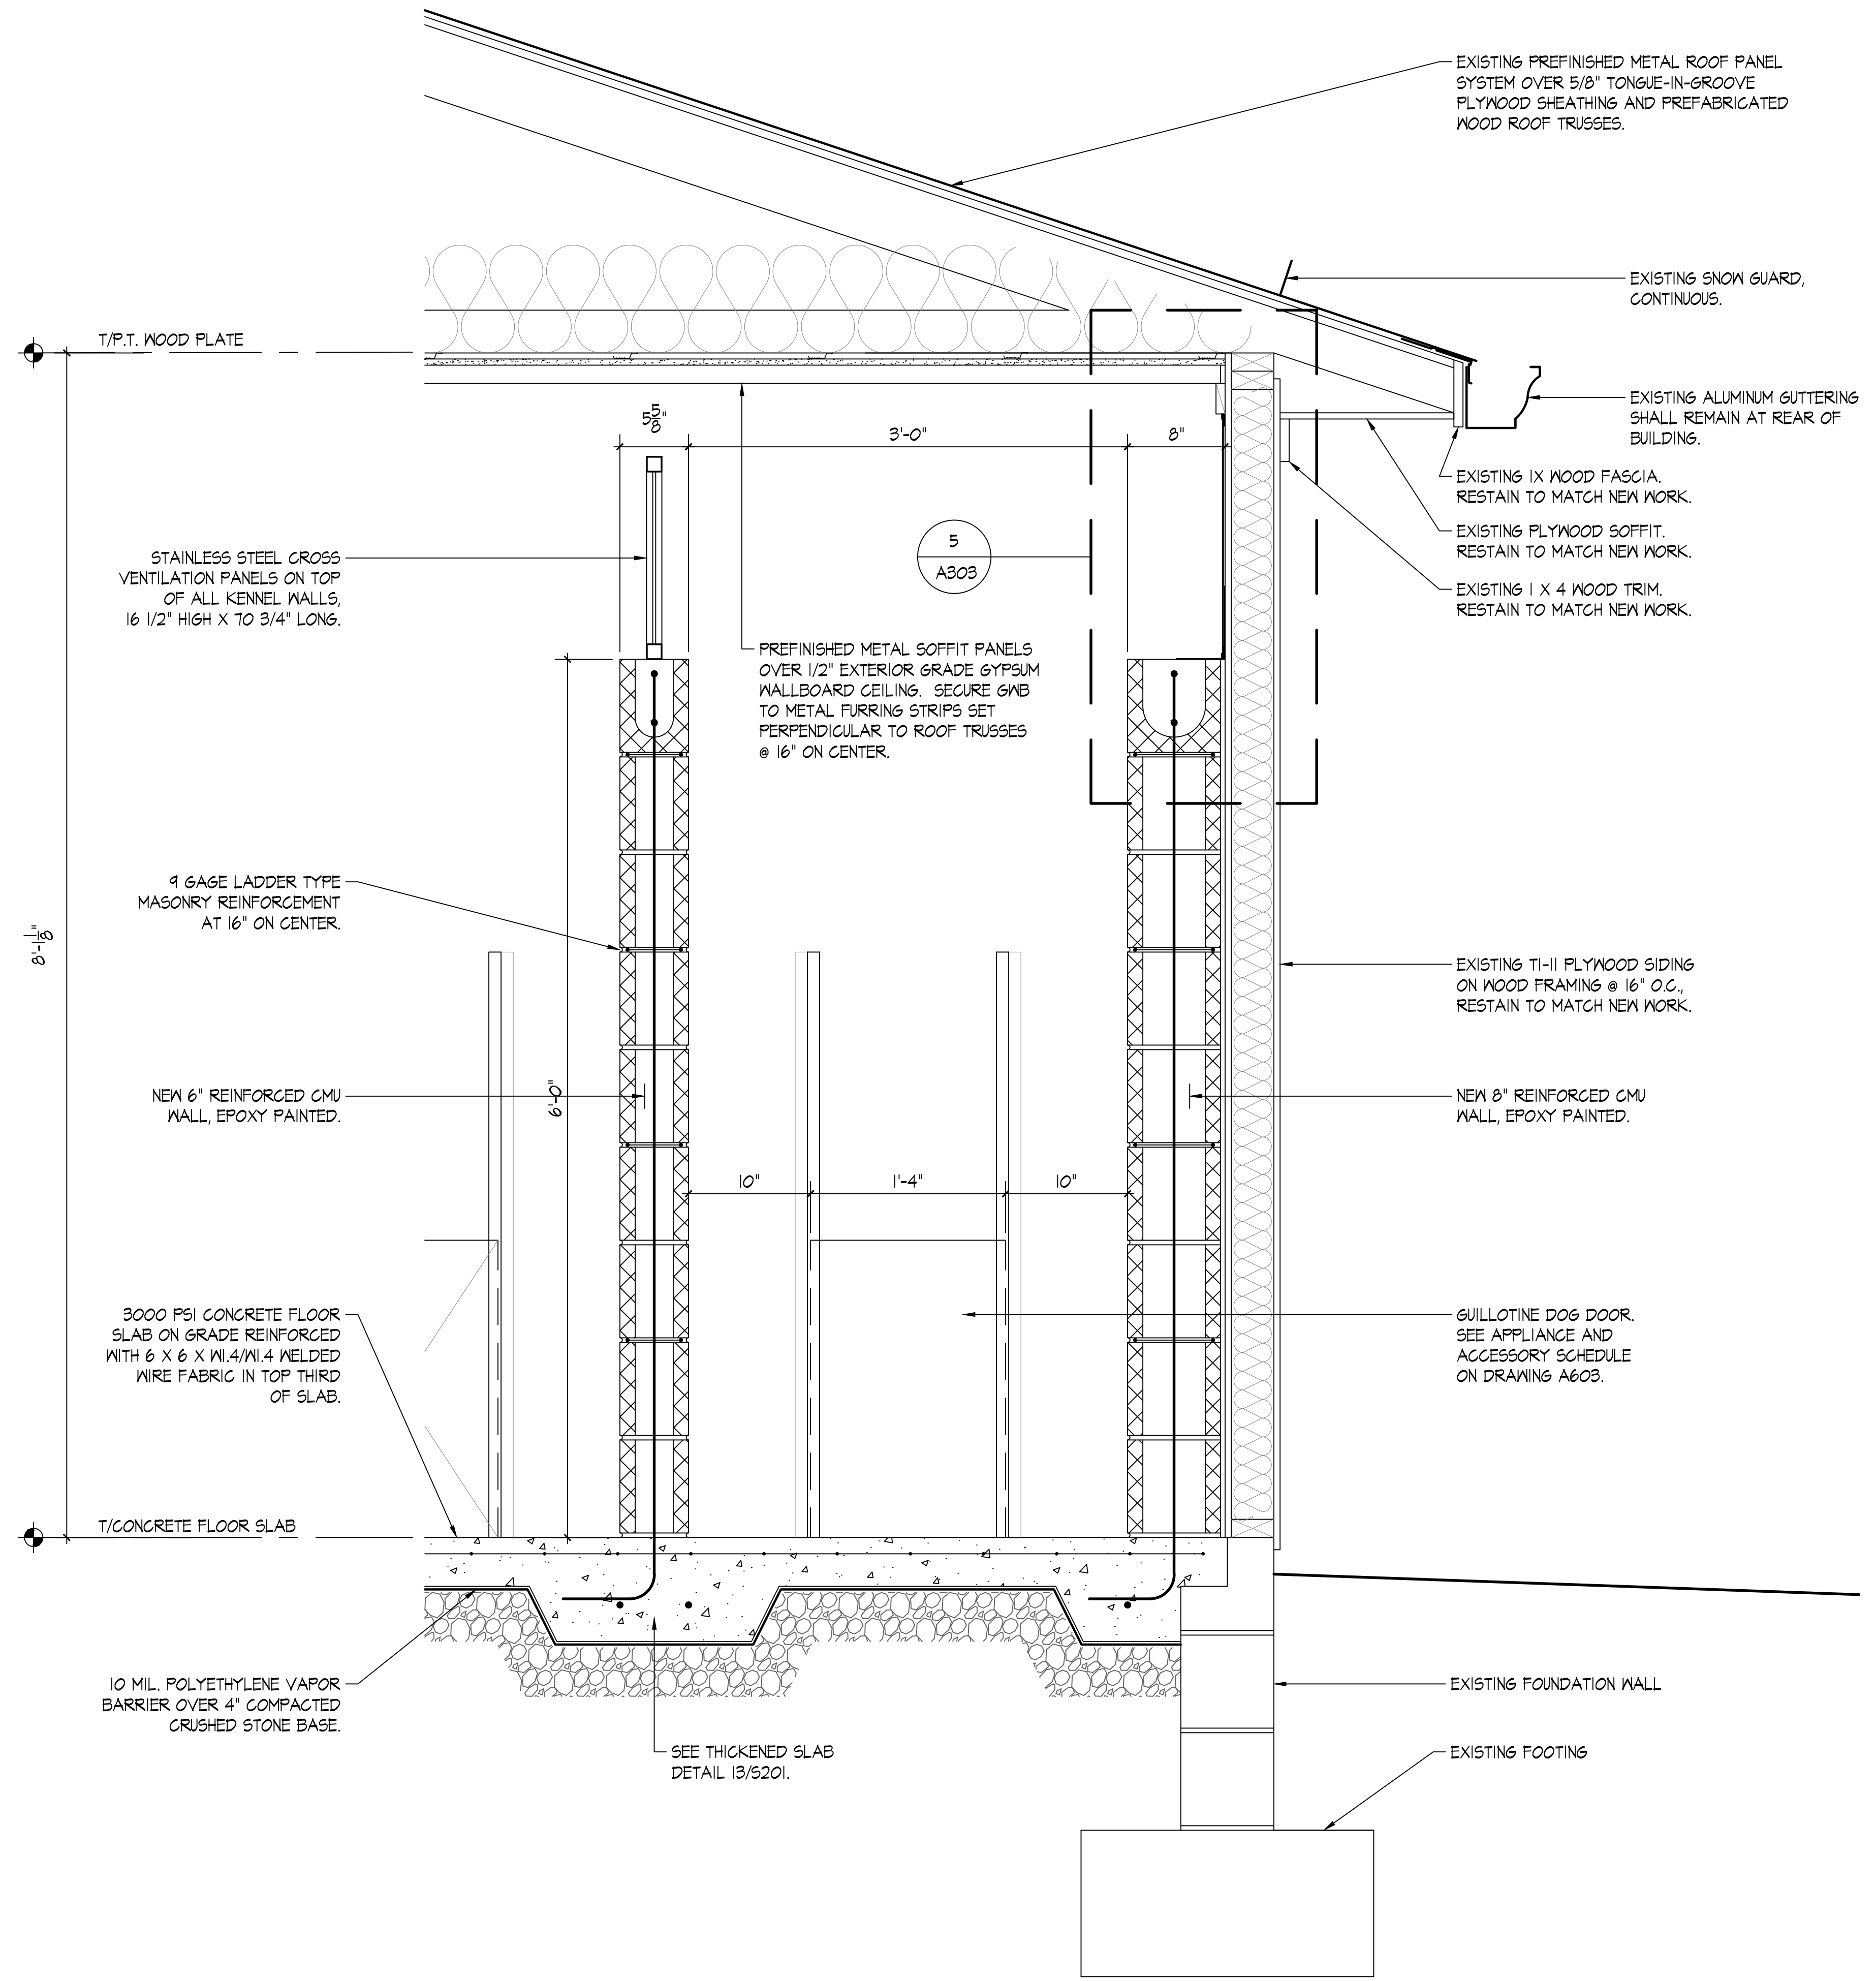SCALE: 3" = 1'-0"
0 3" 6" 9"




WALL SECTION AT EXISTING EXTERIOR WALL


4
A303

SCALE: 1 1/2" = 1'-0"
0 1/2" 1" 1 1/2"

DATE:	06-30-2023
NO.	REVISION DATE
1	
2	
3	
SHEET:	A303
DRAWN BY:	CHECKED BY:
PROJECT NO.	TLG-22136
THE LANE GROUP INC.	

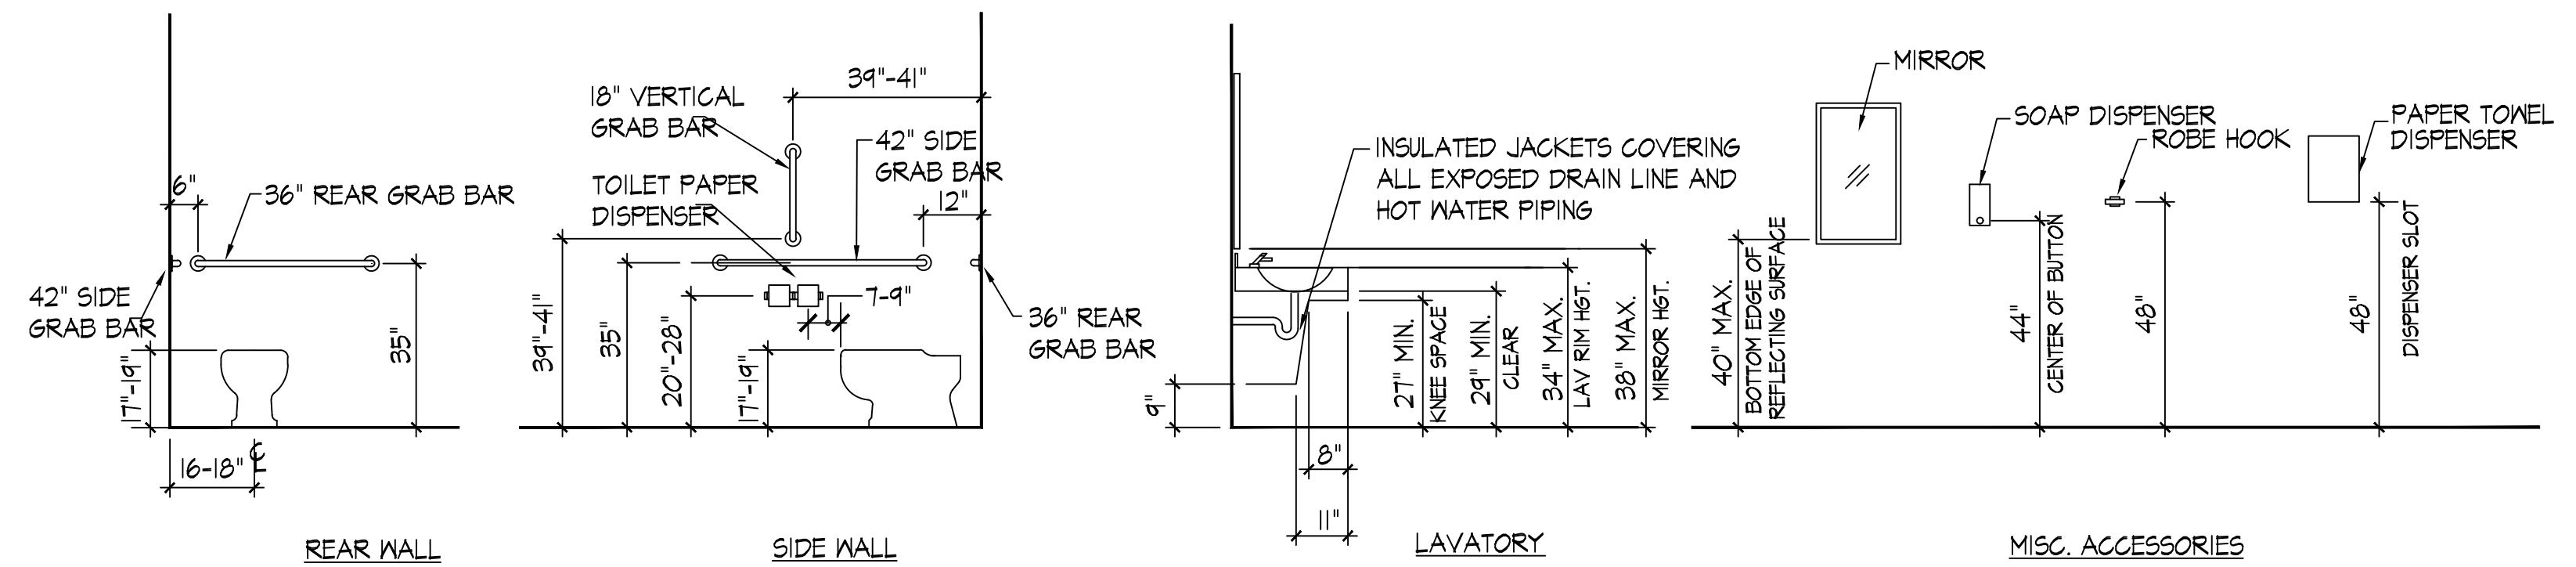

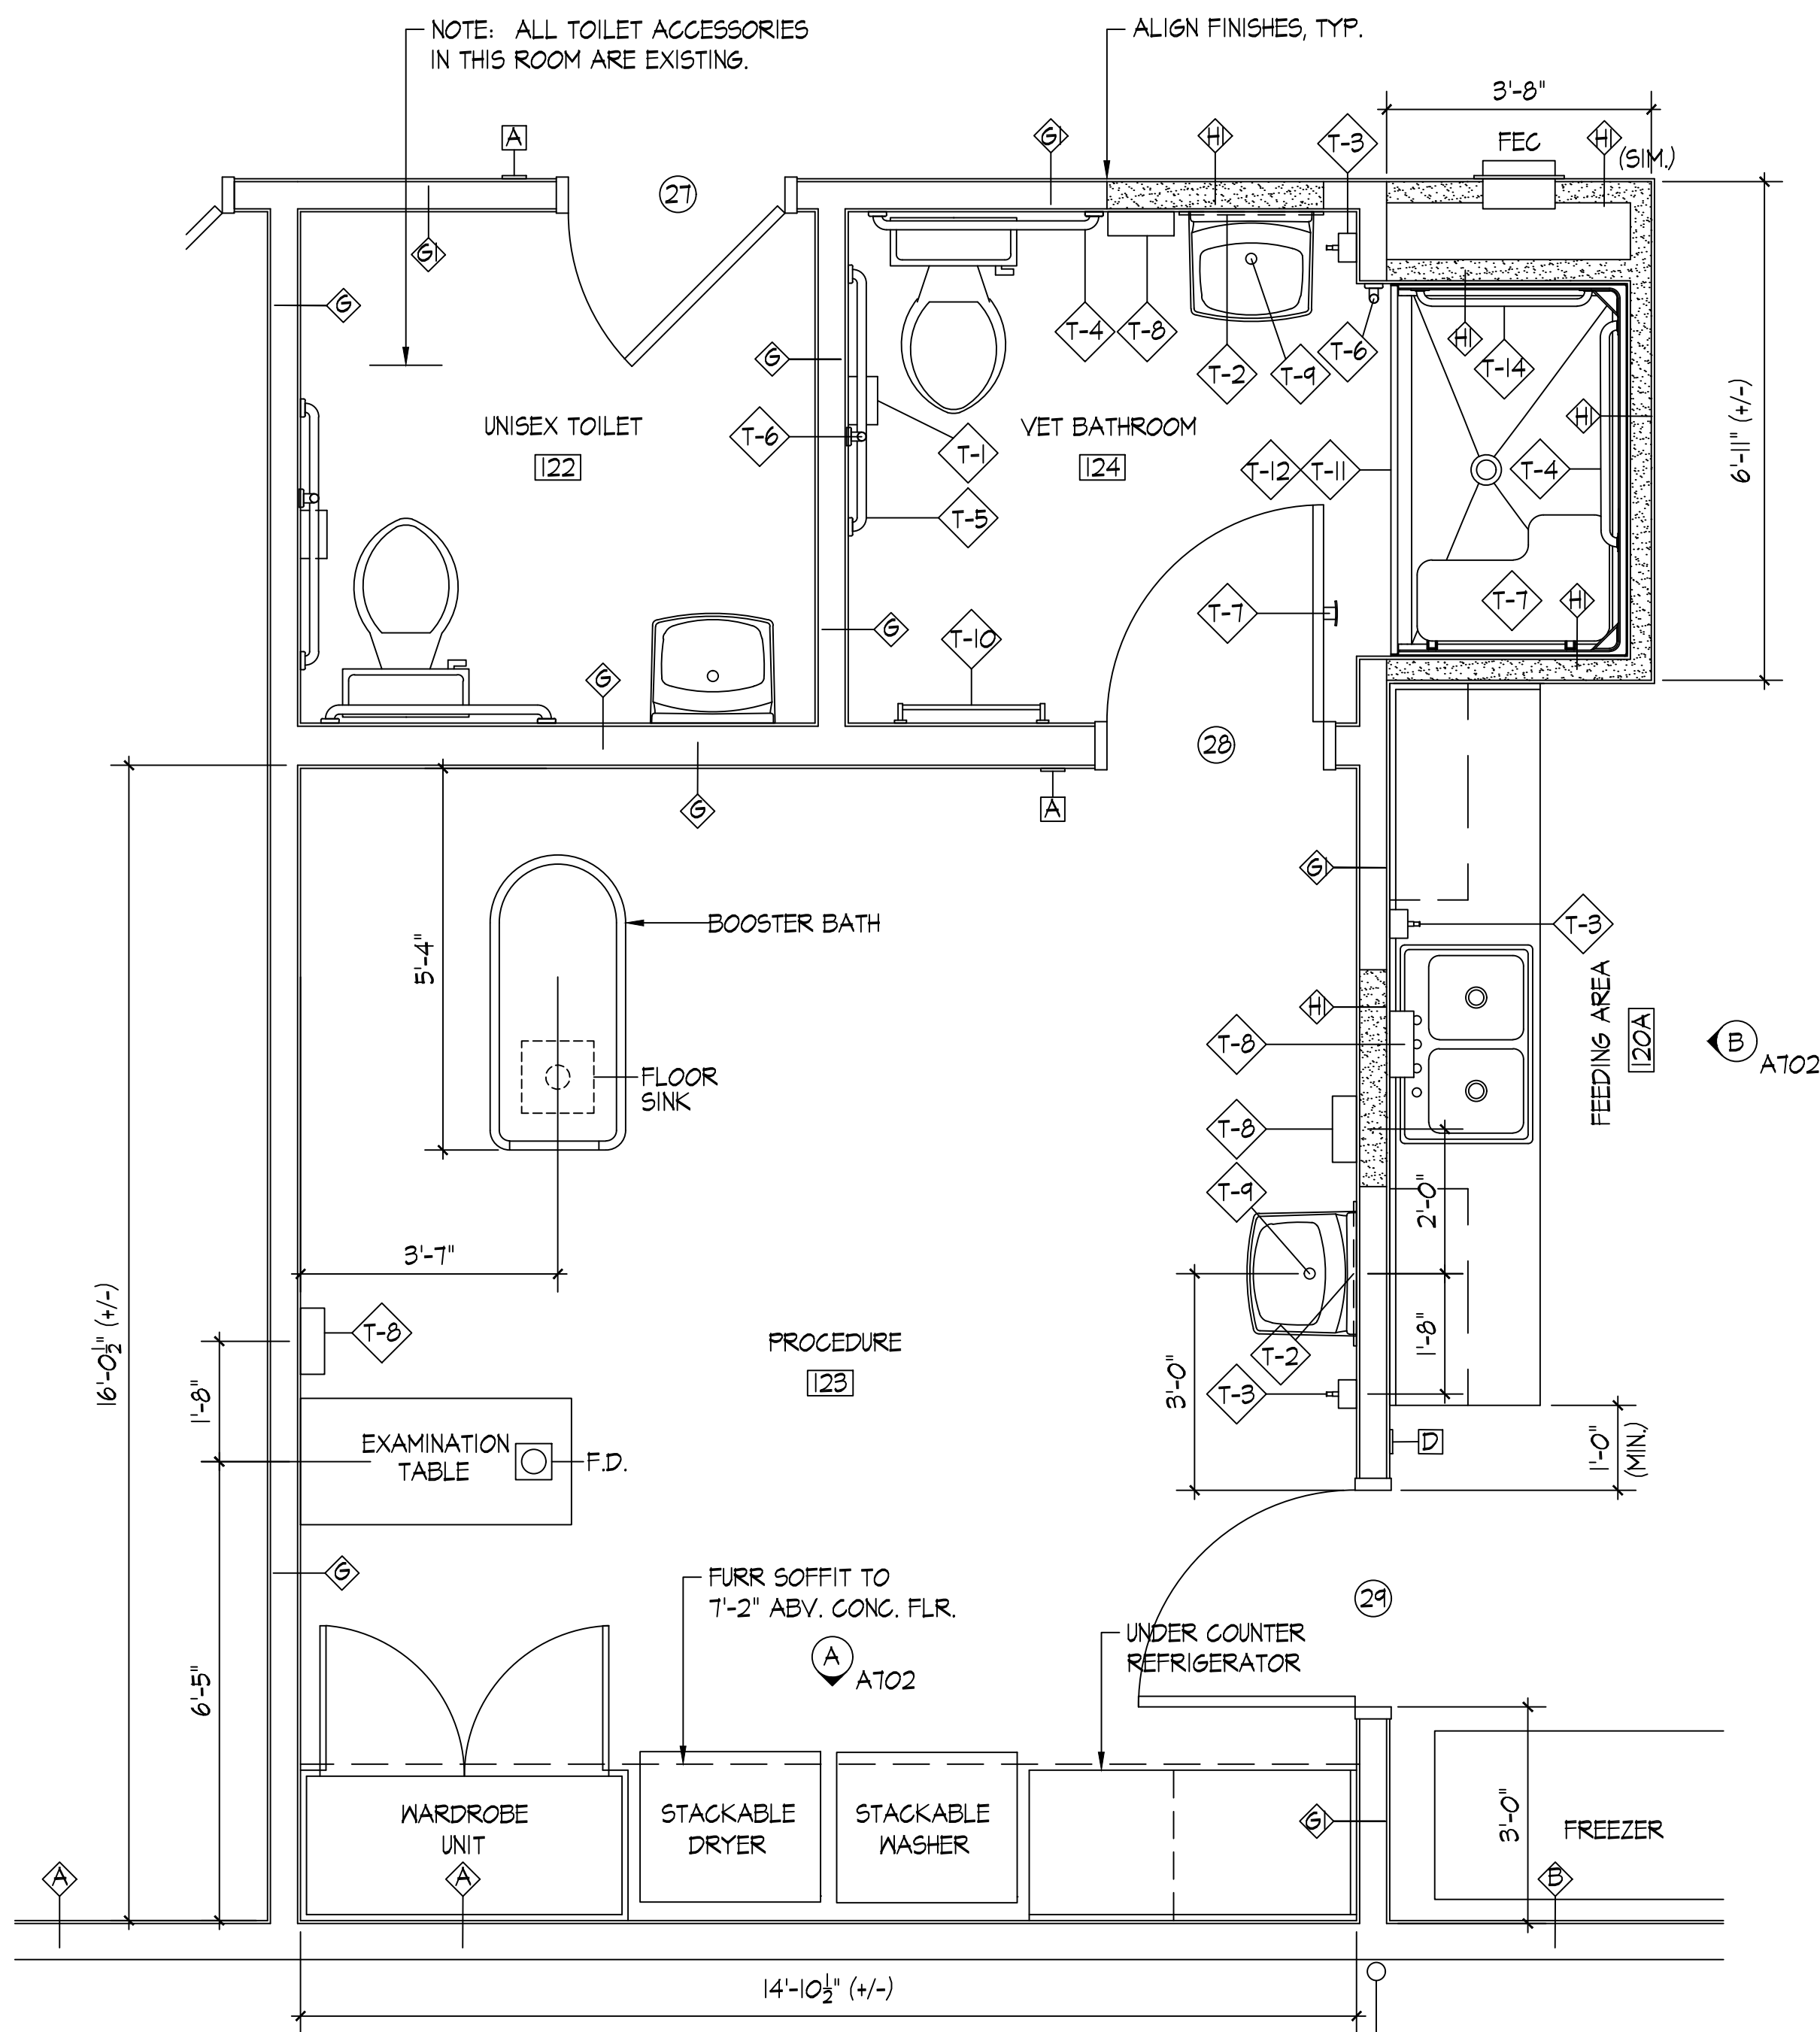
TYPICAL ACCESSIBLE MOUNTING HEIGHTS
SCALE: 3/8" = 1'-0"



PROCEDURE AREA ENLARGED PLAN
SCALE: 1/2" = 1'-0"
0 1 2 4'


MARK	DESCRIPTION	MANUFACTURER	MODEL NO.	MOUNTING	REMARKS
T-1	TOILET PAPER DISPENSER	BOBRICK	B-2140	SURFACE	.
T-2	MIRROR	BOBRICK	B-290 2430	SURFACE	.
T-3	LIQUID SOAP DISPENSER	BOBRICK	B-6562	SURFACE	SEE A702 FOR MOUNT HT. AT CABINETRY.
T-4	36" GRAB BAR	BOBRICK	B-5806 x 36	SURFACE	.
T-5	42" GRAB BAR	BOBRICK	B-5806 x 42	SURFACE	.
T-6	18" GRAB BAR (VERTICAL)	BOBRICK	B-5806 x 18	SURFACE	.
T-7	ROBE HOOK	BOBRICK	B-6727	SURFACE	.
T-8	PAPER TOWEL DISPENSER	BOBRICK	B-2620	SURFACE	SEE A702 FOR MOUNT HT. AT CABINETRY.
T-9	THERMAL PROTECTIVE DRAIN COVERS	TRUEBRO	IATB4	LAV PIPES AND VALVES	.
T-10	TOWEL BAR	BOBRICK	B-6747X24	SURFACE	MOUNT ROD CENTERLINE AT 48" AFF.
T-11	SHOWER ROD	BOBRICK	B-207 X 60	SURFACE	MOUNT ROD CENTERLINE AT 74 1/2" AFF.
T-12	SHOWER HOOKS / SHOWER CURTAIN	BOBRICK	B-204-1 / B-204-3	HUNG FROM CURTAIN ROD.	.
T-13	FOLDING SHOWER SEAT	BOBRICK	B-5181	SURFACE	19" FROM SHOWER BASIN TO SEAT HT.
T-14	28" GRAB BAR	BOBRICK	B-5806 x 28	SURFACE	.

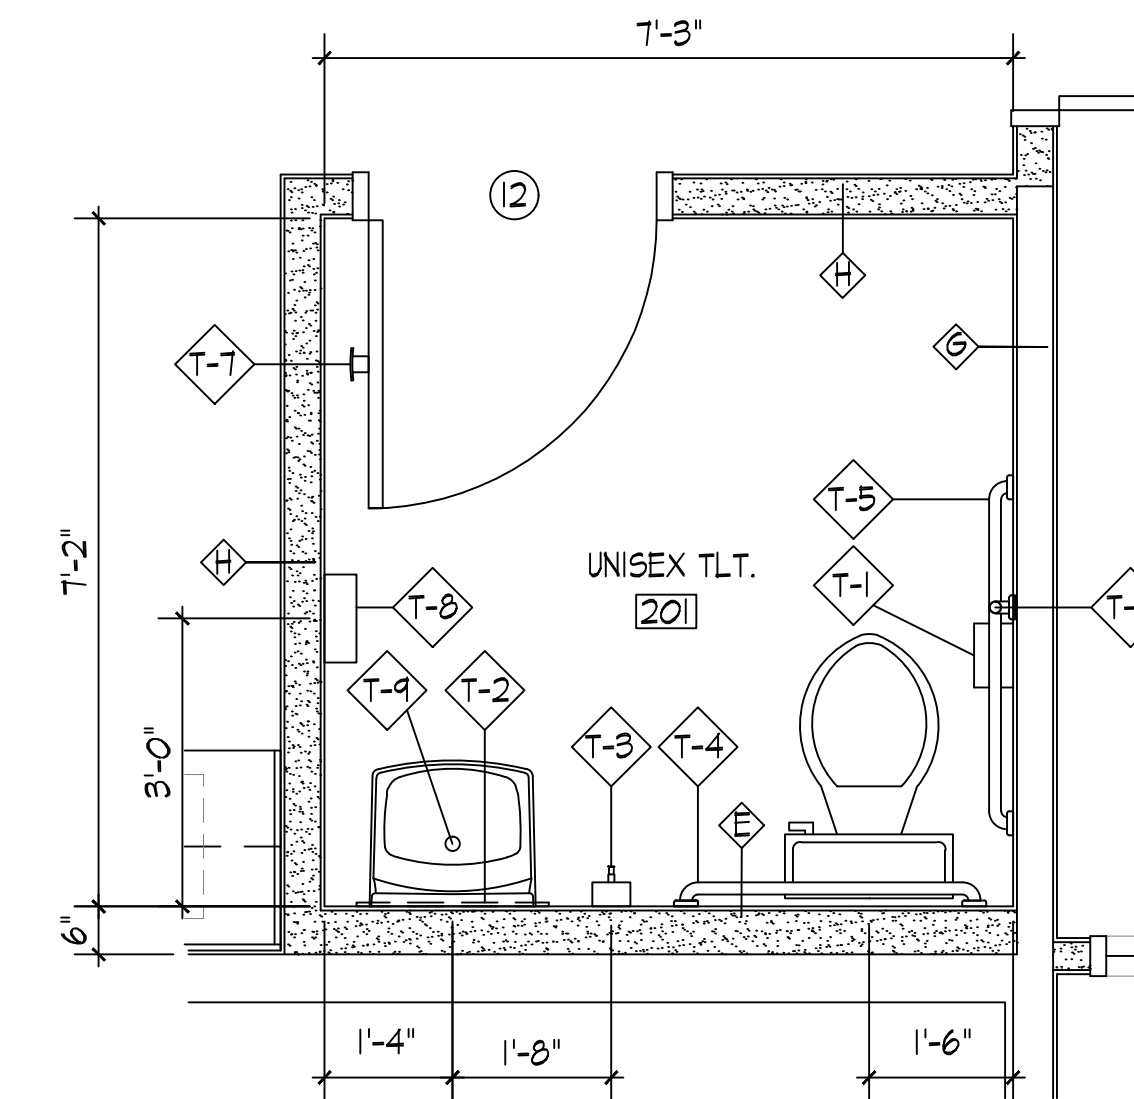NOTE: THE SCHEDULING OF ACCESSORIES BY BOBRICK WASHROOM EQUIPMENT, INC. SERVES TO ESTABLISH SIZE, FUNCTION AND QUALITY STANDARD. THIS IS NOT MEANT TO BE PROPRIETARY. ACCESSORIES MANUFACTURED BY BRADLEY CORPORATION OR ASI MAY BE SUBSTITUTED AS EQUAL PRODUCTS.



SHERIFF'S AREA UNISEX TOILET
SCALE: 1/2" = 1'-0"
0 1 2 4'

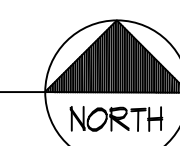ENLARGED FLOOR PLANS
SCALE: 1/2" = 1'-0"
0 1 2 4'



BUILDING RENOVATION FOR
WASHINGTON COUNTY, VIRGINIA
ANIMAL SHELTER
15050 LEE HIGHWAY
BRISTOL, VIRGINIA 24201

ENLARGED FLOOR PLAN
TOILET ACCESSORY SCHEDULE



DATE: 06-30-2023

NO. REVISION DATE

1

2

3

SHEET:

A401

DRAWN BY CHECKED BY

PROJECT NO. TLG-22136

THE LANE GROUP INC.

the LANE GROUP
Abingdon | Big Stone Gap | Galax
www.thelanegrpinc.com
engineering architecture environmental
310 Valley Street NW
Abingdon, VA 24210
276.208.8571 - office

DOOR SCHEDULE

MARK	FROM ROOM	TO ROOM	DOORS								FRAMES					FIRE RATING	HARDWARE SET NO.	REMARKS
			WIDTH	HEIGHT	THK.	MATERIAL	CORE	TYPE	FINISH	GLASS	MATERIAL	FINISH	JAMB	HEAD	ELEV.			
1	SHERIFF'S DEPT. 200	EXTERIOR	3'-0"	7'-0"	1 3/4"	ALUMINUM STOREFRONT	--	--	EXISTING	EXIST.	ALUMINUM STOREFRONT	EXISTING	--	--	SEE SHT. A201.	--	HW-1	EXISTING DOOR TO BE RELOCATED.
2	VESTIBULE 100	EXTERIOR	3'-0"	7'-0"	1 3/4"	ALUMINUM STOREFRONT	--	--	EXISTING	EXIST.	ALUMINUM STOREFRONT	EXISTING	--	--	SEE SHT. A201.	--	HW-1	EXISTING DOOR & FRAME IN PLACE.
3	DOG KENNELS 126	EXTERIOR	DBL. 3'-0"	7'-0"	1 3/4"	HOLLOW METAL	INSUL	C	PAINT	61	HOLLOW METAL	PAINT			4		HW-2	
4	DOG KENNELS 126	EXTERIOR	3'-0"	7'-0"	1 3/4"	HOLLOW METAL	INSUL	C	PAINT	61	HOLLOW METAL	PAINT			2		HW-3	
5	FEEDING AREA 120A	EXTERIOR	DBL. 3'-0"	7'-0"	1 3/4"	HOLLOW METAL	INSUL	C	PAINT	61	HOLLOW METAL	PAINT			3		HW-2	
6	CORRIDOR 109	EXTERIOR	3'-0"	6'-8"	1 3/4"	HOLLOW METAL	--	A	PAINT	--	HOLLOW METAL	PAINT			1		HW-3	EXISTING DOOR & FRAME IN PLACE.
7	LOBBY 101	VESTIBULE 100	3'-0"	7'-0"	1 3/4"	ALUMINUM STOREFRONT	--	--	EXISTING	EXIST.	ALUMINUM STOREFRONT	EXISTING	--	--	--	--	--	EXISTING DOOR & FRAME IN PLACE.
8	RECEPTION 102	OFFICE 103	3'-0"	6'-8"	1 3/8"	WOOD	SOLID	C	PAINT	62	HOLLOW METAL	PAINT			5		HW-4	
9	RECEPTION 102	FILES 104	3'-0"	6'-8"	1 3/8"	WOOD	SOLID	C	PAINT	62	HOLLOW METAL	PAINT			1		HW-5	
10	CLOSET 105	LOBBY 101	DBL. 3'-0"	6'-8"	1 3/8"	WOOD	SOLID	B	PAINT	--	HOLLOW METAL	PAINT			3		HW-6	
11	SHERIFF'S DEPT. 200	LOBBY 101	3'-0"	6'-8"	1 3/8"	WOOD	SOLID	B	PAINT	--	HOLLOW METAL	PAINT			1		HW-4	
12	SHERIFF'S DEPT. 200	UNISEX TOILET 201	3'-0"	6'-8"	1 3/8"	WOOD	SOLID	B	PAINT	--	HOLLOW METAL	PAINT			1		HW-7	
13	LOBBY 101	PLAYROOM 106	3'-0"	6'-8"	1 3/8"	WOOD	SOLID	D	PAINT	62	HOLLOW METAL	PAINT			6		HW-8	
14	LOBBY 101	PLAYROOM 107	3'-0"	6'-8"	1 3/8"	WOOD	SOLID	D	PAINT	62	HOLLOW METAL	PAINT			6		HW-8	
15	CORRIDOR 109	BREAK ROOM 108	3'-0"	6'-8"	1 3/8"	WOOD	SOLID	B, SIM.	PAINT	--	WOOD	PAINT		1, SIMILAR			--	EXISTING DOOR & FRAME IN PLACE.
16	CORRIDOR 109	SERVER ROOM 110	3'-0"	6'-8"	1 3/8"	WOOD	SOLID	B, SIM.	PAINT	--	WOOD	PAINT		1, SIMILAR			--	EXISTING DOOR & FRAME IN PLACE.
17	CORRIDOR 109	OFFICE 111	3'-0"	6'-8"	1 3/8"	WOOD	SOLID	B, SIM.	PAINT	--	WOOD	PAINT		1, SIMILAR			--	EXISTING DOOR & FRAME IN PLACE.
18	CLOSET 113	CORRIDOR 112	3'-0"	6'-8"	1 3/8"	WOOD	SOLID	B, SIM.	PAINT	--	WOOD	PAINT		1, SIMILAR			--	EXISTING DOOR & FRAME IN PLACE.
19	CORRIDOR 112	MEN 114	3'-0"	6'-8"	1 3/8"	WOOD	SOLID	B, SIM.	PAINT	--	WOOD	PAINT		1, SIMILAR			--	EXISTING DOOR & FRAME IN PLACE.
20	CORRIDOR 112	WOMEN 115	3'-0"	6'-8"	1 3/8"	WOOD	SOLID	B, SIM.	PAINT	--	WOOD	PAINT		1, SIMILAR			--	EXISTING DOOR & FRAME IN PLACE.
21	CORRIDOR 112	STORAGE 116	3'-0"	6'-8"	1 3/8"	WOOD	SOLID	B, SIM.	PAINT	--	WOOD	PAINT		1, SIMILAR			--	EXISTING DOOR & FRAME IN PLACE.
22	LOBBY 101	STORAGE 117	3'-0"	6'-8"	1 3/8"	WOOD	SOLID	B	PAINT	--	HOLLOW METAL	PAINT			1		HW-5	
23	CAT QUARTERS 119	CAT ISOLATION 118	3'-0"	6'-8"	1 3/8"	WOOD	SOLID	D	PAINT	--	HOLLOW METAL	PAINT			5		HW-8	
24	LOBBY 101	CAT QUARTERS 119	3'-0"	6'-8"	1 3/8"	WOOD	SOLID	B	PAINT	--	HOLLOW METAL	PAINT			5		HW-8	
25	DOG KENNELS 120	LOBBY 101	3'-0"	6'-8"	1 3/8"	WOOD	SOLID	C	PAINT	62	HOLLOW METAL	PAINT			1		HW-8	REFRAME ROUGH OPENING.
26	DOG KENNELS 120	MECH ROOM 122	3'-0"	6'-8"	1 3/8"	WOOD	SOLID	B, SIM.	PAINT	--	WOOD	PAINT		1, SIMILAR			--	EXISTING DOOR & FRAME IN PLACE.
27	DOG KENNELS 120	UNISEX TOILET 123	3'-0"	6'-8"	1 3/8"	WOOD	SOLID	B, SIM.	PAINT	--	WOOD	PAINT		1, SIMILAR			--	EXISTING DOOR & FRAME IN PLACE.
28	PROCEDURE 124	VET BATHROOM 125	3'-0"	6'-8"	1 3/4"	HOLLOW METAL	INSUL	B	PAINT	--	HOLLOW METAL	PAINT			1		HW-7	
29	FEEDING AREA 120A	PROCEDURE 123	3'-0"	6'-8"	1 3/4"	HOLLOW METAL	INSUL	C	PAINT	--	HOLLOW METAL	PAINT			1		HW-4	
30	ISOLATION 121	DOG KENNELS 120	3'-0"	7'-0"	1 3/4"	HOLLOW METAL	INSUL	C	PAINT	62	HOLLOW METAL	PAINT			2		HW-9	
31	ISOLATION 121	DOG KENNELS 120	3'-0"	7'-0"	1 3/4"	HOLLOW METAL	INSUL	C	PAINT	62	HOLLOW METAL	PAINT			2		HW-9	
32	DOG KENNELS 120	DOG KENNELS 126	3'-0"	7'-0"	1 3/4"	HOLLOW METAL	INSUL	C	PAINT	62	HOLLOW METAL	PAINT			2		HW-9	
33	DOG KENNELS 120	DOG KENNELS 126	3'-0"	7'-0"	1 3/4"	HOLLOW METAL	INSUL	C	PAINT	62	HOLLOW METAL	PAINT			2		HW-9	
34	MAIN ATTIC AREA	ATTIC ABV. SHERIFF	--	--	--	WOOD	--	--	--	--	WOOD ROUGH OPNG.	PAINT			--		--	EXIST. ATTIC DOOR SHALL REMAIN.
35	MAIN ATTIC AREA A	MAIN ATTIC AREA B	3'-0"	6'-8"	1 3/4" (+/-)	WOOD	--	B, SIM.	--	--	WOOD ROUGH OPNG.	PAINT			--		HW-10	NEW ATTIC DRAFTSTOPPING DOOR.

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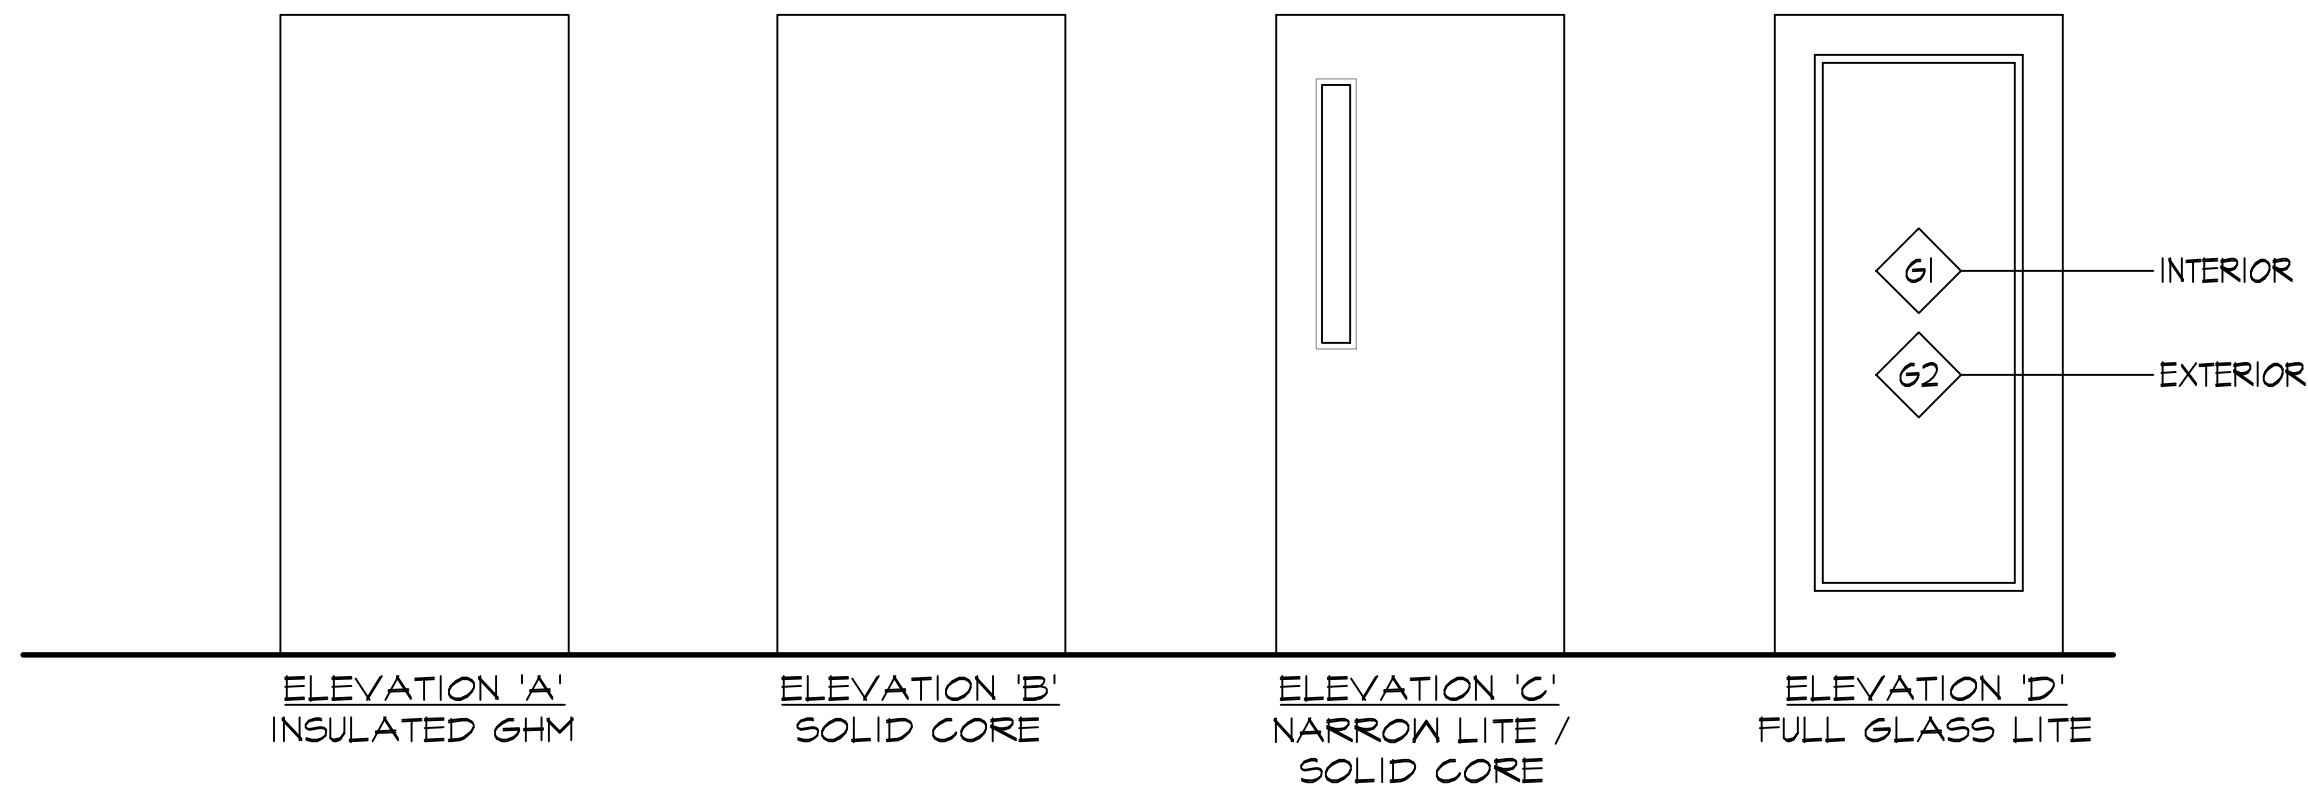
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ANIMAL SHELTER
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DOOR SCHEDULE




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DOOR TYPES

SCALE: 1/2" = 1'-0"

GLAZING SCHEDULE	
MARK	DESCRIPTION
61	3/16" CLEAR TEMPERED GLASS
62	1" CLEAR TEMPERED INSULATING GLASS
63	1" INSULATING GLASS WITH DARK BRONZE TINT ON #2 SURFACE
64	NOT USED.



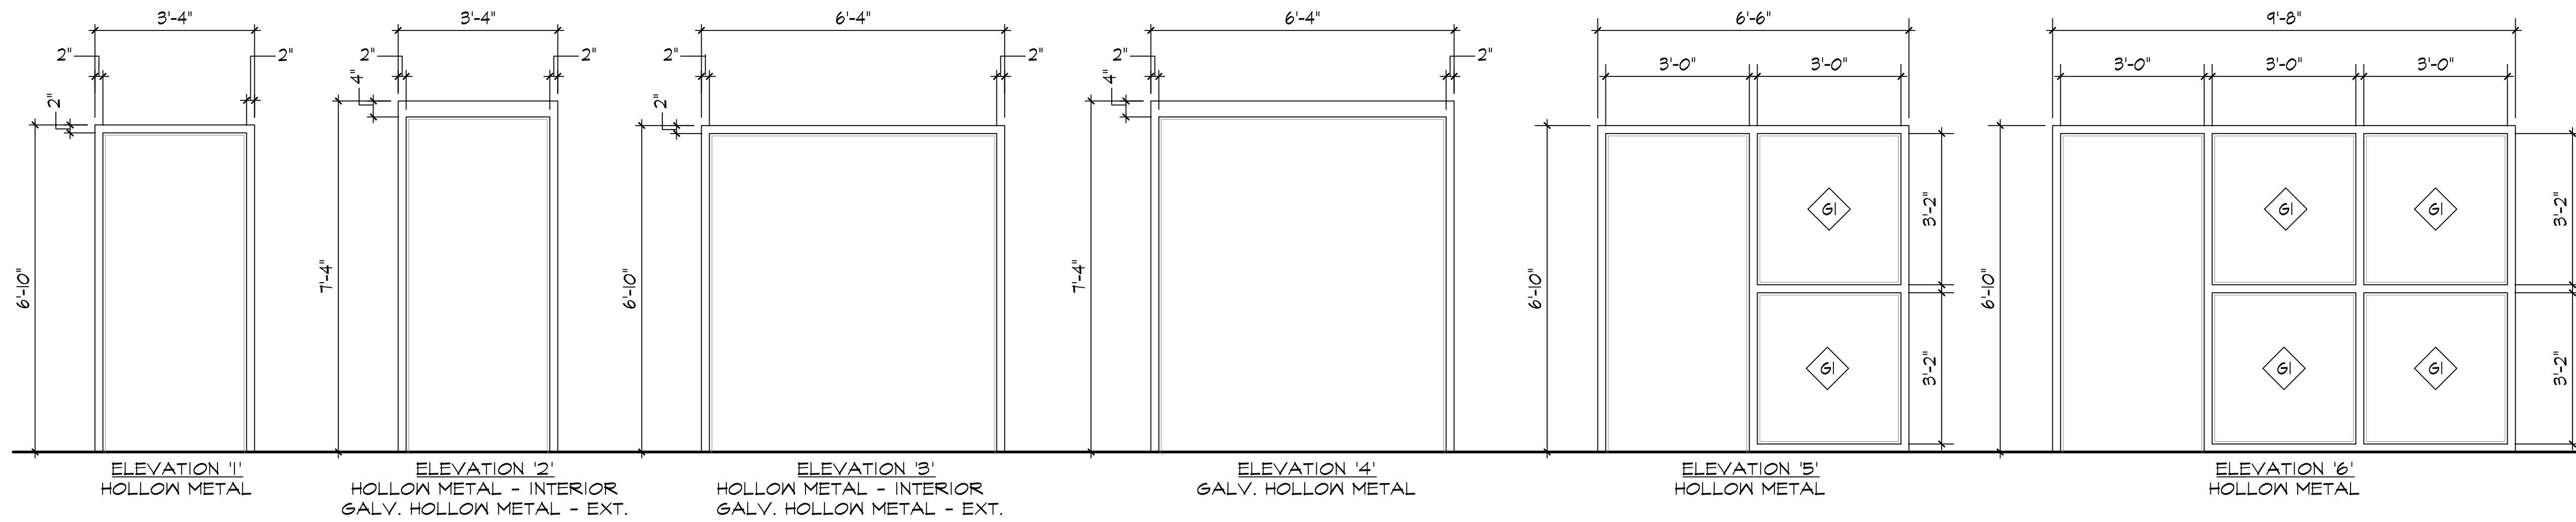FRAME TYPES

SCALE: 1/2" = 1'-0"



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SIGN SCHEDULE

MARK	SIGN TEXT	NOTES
A	UNISEX	1, 2
B	DOG KENNELS	1, 2
C	MECHANICAL	1, 2
D	PROCEDURE	1, 2

SIGN SCHEDULE NOTES


- INTERIOR SIGNAGE SYSTEM SHALL COMPLY WITH ALL CURRENT AND APPLICABLE ADA REQUIREMENTS INCLUDING THOSE REGARDING WHICH SIGN TYPES REQUIRE PICTOGRAMS AND/OR BRAILLE / TACTILE FEATURES. CHARACTER HEIGHTS, COLOR CONTRAST, INSTALLATION LOCATIONS, AND MOUNTING HEIGHTS SHALL BE ADA COMPLIANT.
- BASIS OF DESIGN FOR SIGNAGE IS THE "FULL-VIEW" LOW-PROFILE MODULAR SIGN SYSTEM, AS MANUFACTURED BY APCO SIGNS. THIS IS NOT MEANT TO BE PROPRIETARY. MANUFACTURERS WHO REGULARLY ENGAGE IN THE FABRICATION OF SIMILAR SIGNAGE SYSTEMS WILL BE GIVEN CONSIDERATION AS AN EQUAL PRODUCT.

APPLIANCE AND ACCESSORY SCHEDULE

DESCRIPTION	MANUFACTURER	MODEL NO.	NOTES
REFRIGERATOR	GE "PROFILE"	GTS22JNRS5	NOTES 1, 2, AND 3.
UNDERCOUNTER REFRIGERATOR	GE	GCE06SH5B	NOTES 1, 2, AND 4.
DISHWASHER	GE "PROFILE"	GDT650SYVFS	NOTES 1, AND 2.
FREEZER	GE "PROFILE"	FCM22DLW	NOTES 1, 2, AND 5.
WASHER	GE COMMERCIAL	GFM550S9NW	NOTES 1, 2, AND 6.
DRYER	GE COMMERCIAL	GFD55E99NW	NOTES 1, 2, AND 6.
EXAMINATION TABLE	VETLIFT / PETLIFT	VL-TEZ-9045E-BLK	ROOM # 124.
DOG BATHTUB	BOOSTER BATH	LARGE SIZE RED COLOR.	ROOM # 124.
3'-0" WIDE DOG KENNEL DOOR	DIRECT ANIMAL PRODUCTS, INC.	D1036-KD	ROOMS # 120 & 126.
4'-0" WIDE DOG KENNEL DOOR	DIRECT ANIMAL PRODUCTS, INC.	D1048-KD WITH PARTITION.	ROOM # 121.
6'-0" WIDE DOG KENNEL DOOR	DIRECT ANIMAL PRODUCTS, INC.	D1072-KD WITH PARTITION.	ROOM # 126.
CAT CONDOS	DIRECT ANIMAL PRODUCTS, INC.	SEE NOTE 7, BELOW.	ROOMS # 118 & 119.
GUILLOTINE KENNEL DOOR.	SECURITY BOSS	LARGE - PREMIUM.	NOTE 9.

APPLIANCE AND ACCESSORY SCHEDULE NOTES

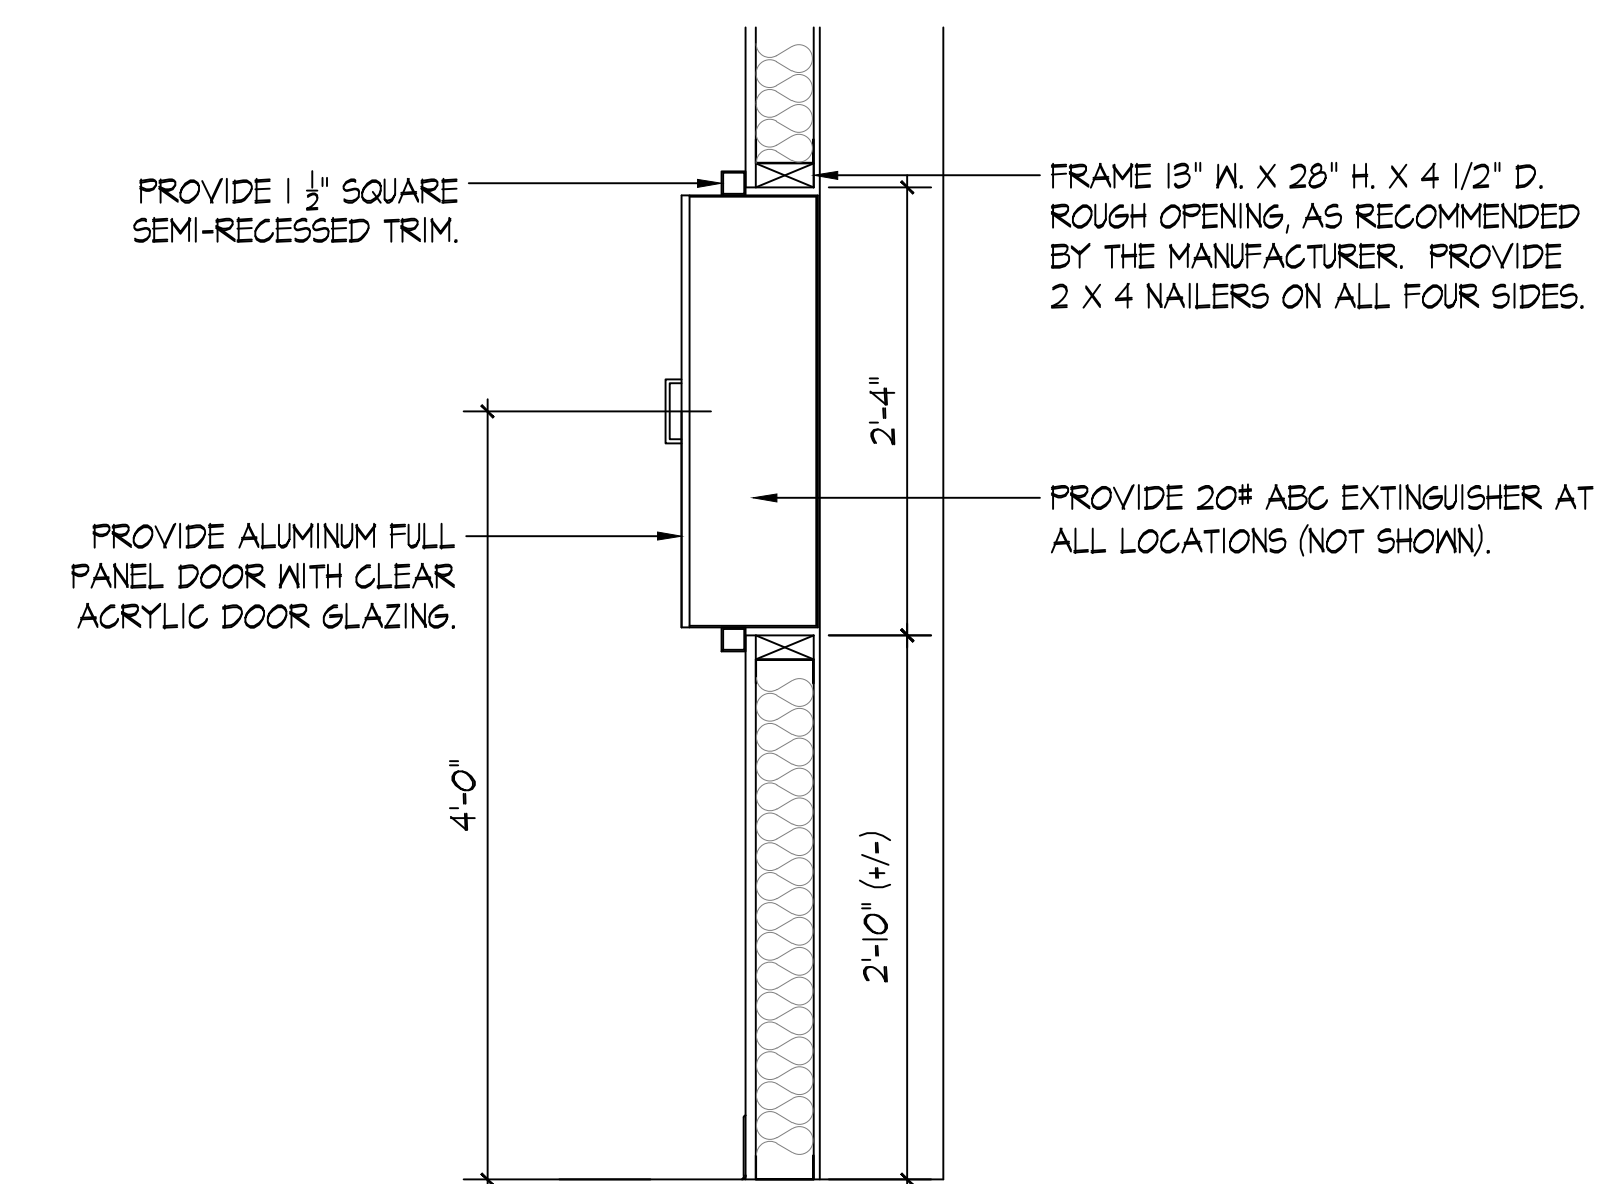- THE GENERAL CONTRACTOR IS RESPONSIBLE FOR PROVIDING AND INSTALLING ALL APPLIANCES AND ACCESSORIES, UNLESS NOTED OTHERWISE.
- IN THE EVENT THAT THE MODEL NUMBER SCHEDULED FOR ANY DEVICE IS NO LONGER AVAILABLE, CONTACT THE ARCHITECT FOR A REPLACEMENT MODEL NUMBER.
- REFRIGERATORS, TOTAL OF 4, SHALL BE LOCATED IN SHERIFF'S DEPT. ROOM # 200, CAT QUARTERS ROOM # 119, BREAK ROOM # 108, AND FEEDING AREA # 120A. ALL REFRIGERATORS 21.9 CU. FT. / STAINLESS STEEL FINISH WITH ICE MAKER.
- 5.6 CUBIC FOOT UNDERCOUNTER REFRIGERATOR, ADA COMPLIANT, ENERGY STAR RATED, STAINLESS STEEL FINISH.
- THE FREEZER SHALL BE LOCATED IN THE FEEDING AREA #120A. FREEZER SHALL BE 21.7 CU. FT. / WHITE FINISH.
- THE STACKABLE WASHERS AND DRYERS SHALL BE LOCATED IN PROCEDURE ROOM # 124. SEE INTERIOR ELEVATION A/A102.
- DOG KENNEL DOORS SHALL BE AS MANUFACTURED BY DIRECT ANIMAL PRODUCTS, INC. PROVIDE 5" X 7" STAINLESS STEEL CARD HOLDER AT EACH DOOR. CONTACT sales@directanimal.com.
- CAT CONDOS SHALL BE AS MANUFACTURED BY DIRECT ANIMAL PRODUCTS, INC. PROVIDE A TRIPLE STACKED CUSTOM CONFIGURATION, AS PROPOSED BY THE MANUFACTURER, X 5 UNITS WIDE. UNITS SHALL BE COMPOSED OF CONDOS TYPE 1200-315 (LEFT END), 1200-345 (CENTER UNITS), AND 1200-375 (RIGHT END). CONTACT sales@directanimal.com.
- THE GUILLOTINE KENNEL DOORS SHALL BE AS MANUFACTURED BY SECURITY BOSS PET DOORS, INC. GUILLOTINE DOORS SHALL BE 'KENNEL CLAD PREMIUM INSULATED UNITS', LARGE SIZE (17" X 24"). CONTACT SALES AT (608)-971-1562.
- FIRE EXTINGUISHERS AND FIRE EXTINGUISHER CABINETS SHALL BE PROVIDED AND INSTALLED BY THE GENERAL CONTRACTOR. BASIS OF DESIGN FOR FIRE EXTINGUISHER CABINETS SHALL BE MODEL # 2712-RA SEMI-RECESSED CABINET AS MANUFACTURED BY LARSEN'S MANUFACTURING COMPANY. INSTALL CABINETS AT AN ADA COMPLIANT HEIGHT.



A
A603
FIRE EXTINGUISHER CABINET DETAIL
SCALE: 1" = 1'-0"



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FINISH SCHEDULE

ROOM NO.		FLOOR				BASE				WALL				CEILING				CEILING HEIGHT		NOTES
		EXISTING VCT TO REMAIN	PATCH EXISTING VCT WITH NEW OF LIKE KIND / COLOR.	NEW VCT - PATTERNED	SHERWIN-WILLIAMS RESINOUS FLOORING W/ RESUFLOOR TOPCOAT TX*	NEW 4" COVERED RUBBER BASE (NOT VINYL)	8" SHERWIN-WILLIAMS RESINOUS FLOORING W/ "RESUFLOOR TOPCOAT TX"	EXISTING GYP. BOARD (REPAINT)	NEW 5/8" GYP. BOARD (PAINT)	NEW 5/8" GYP. BOARD - TYPE X (PAINT)	NEW FRP PANEL OVER 5/8" GYP. BOARD - TYPE X	CMU - PAINT WITH S-W "PRO INDUSTRIAL ACRYLIC, B66-600 SERIES"	EXISTING GYP. BOARD TO REMAIN (PATCH AS NEEDED AND REPAINT)	NEW 3/8" GYP. BOARD OVERLAYING EXISTING GYP. BOARD (PAINT)	NEW PREFINISHED METAL LINER PANELS	8'-0" ±, TYPICAL				
100	VESTIBULE	●				●						●								
101	LOBBY	●	●			●						●	●							
102	RECEPTION	●	●			●						●	●							SEE DRAWING A703 FOR RECEPTION DESK DETAILS.
103	OFFICE	●	●			●						●	●							
104	FILES / OFFICE SUPPLIES	●	●			●						●	●							
105	CLOSET	●	●			●						●	●							
106	PLAYROOM	●	●			●						●	●							
107	PLAYROOM	●	●			●						●	●							
108	BREAK ROOM	●	●			●						●	●							
109	CORRIDOR	●	●			●						●	●							
110	SERVER ROOM	●	●			●						●	●							
111	OFFICE	●	●			●						●	●							
112	CORRIDOR	●	●			●						●	●							
113	CLOSET	●	●			●						●	●							
114	MEN	●	●			●						●	●							
115	WOMEN	●	●			●						●	●							
116	STORAGE	●	●			●						●	●							
117	STORAGE	●	●			●						●	●							
118	CAT ISOLATION	●	●			●						●	●							
119	CAT QUARTERS	●	●			●						●	●							
120	DOG KENNELS			●		●						●	●							
120A	FEEDING AREA			●		●						●	●							
121	ISOLATION			●		●						●	●							
122	MECHANICAL ROOM	●	●			●						●	●							
123	UNISEX TOILET	●	●			●						●	●							
124	PROCEDURE			●		●						●	●							
125	VET BATHROOM			●		●						●	●							
126	DOG KENNELS			●		●						●	●							
200	SHERIFF'S OFFICE		●			●						●	●							
201	UNISEX TOILET		●			●						●	●							

BUILDING RENOVATION FOR
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FINISH SCHEDULE



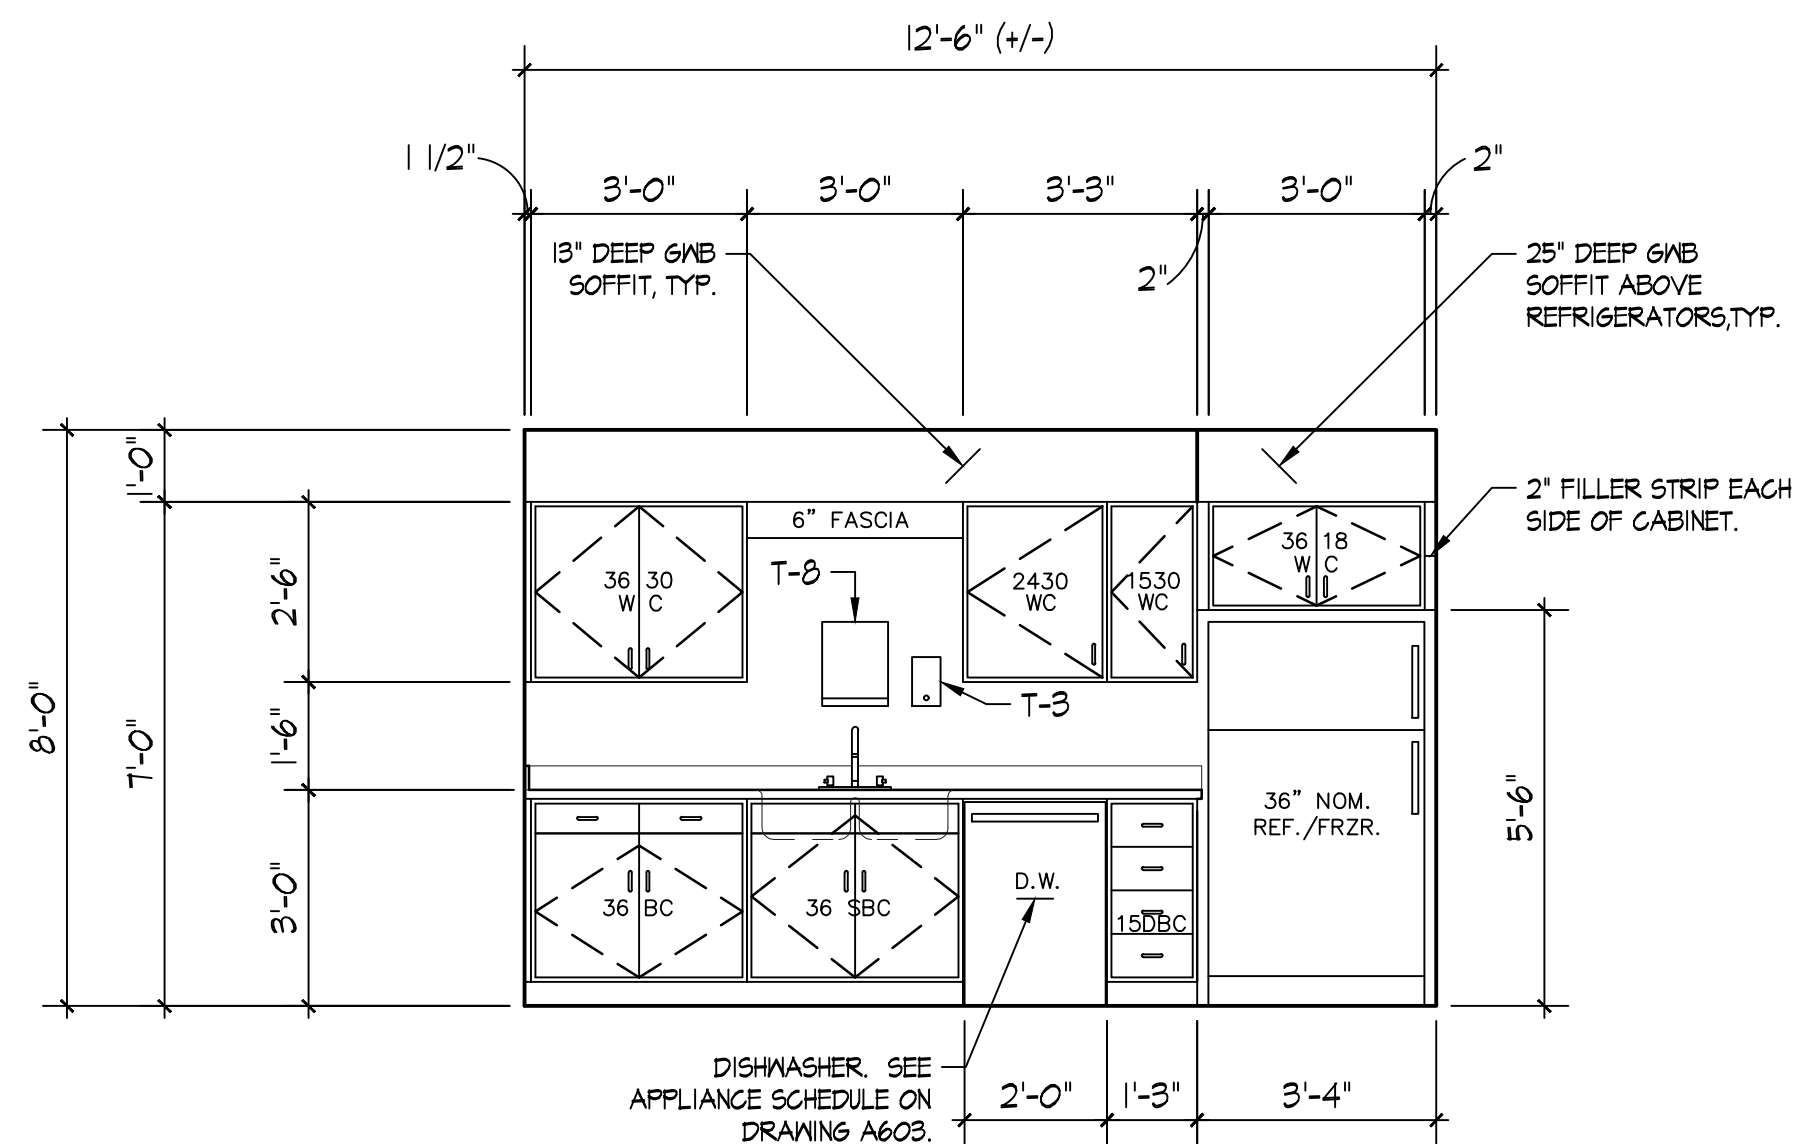
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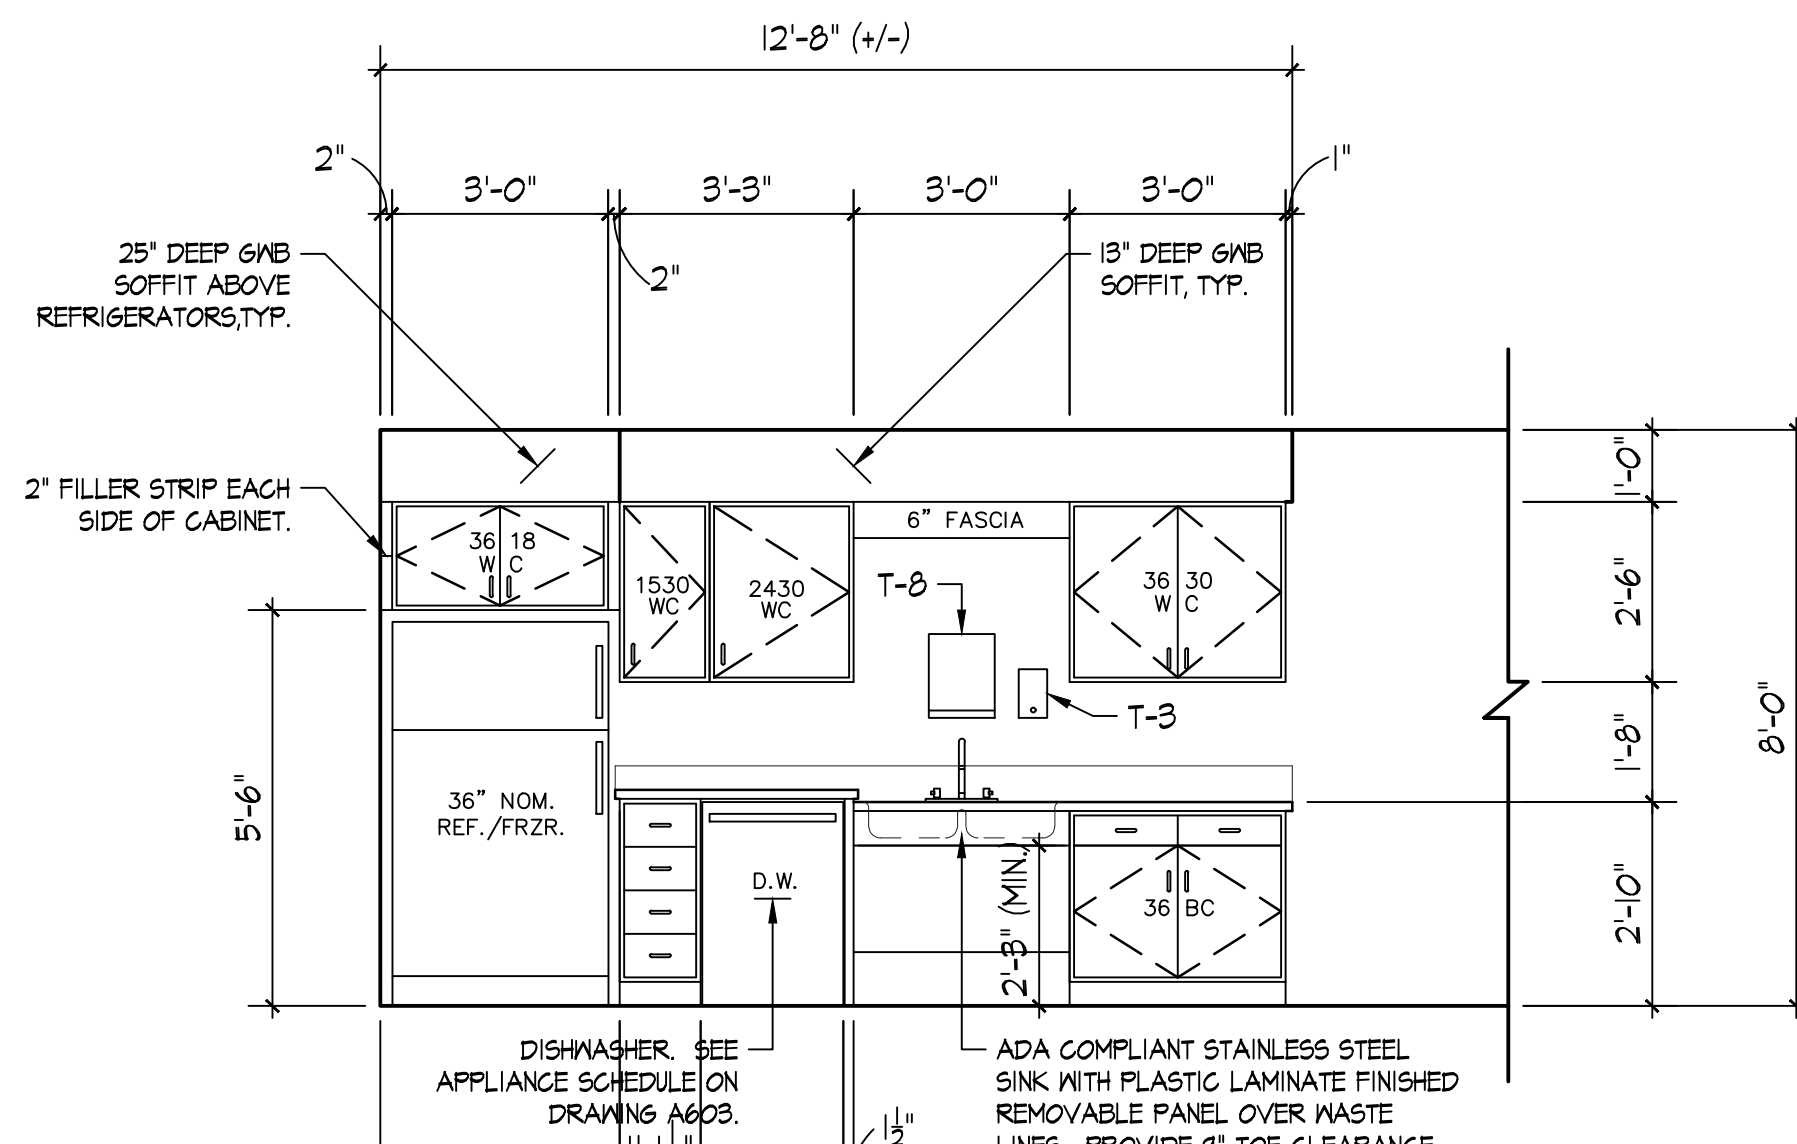
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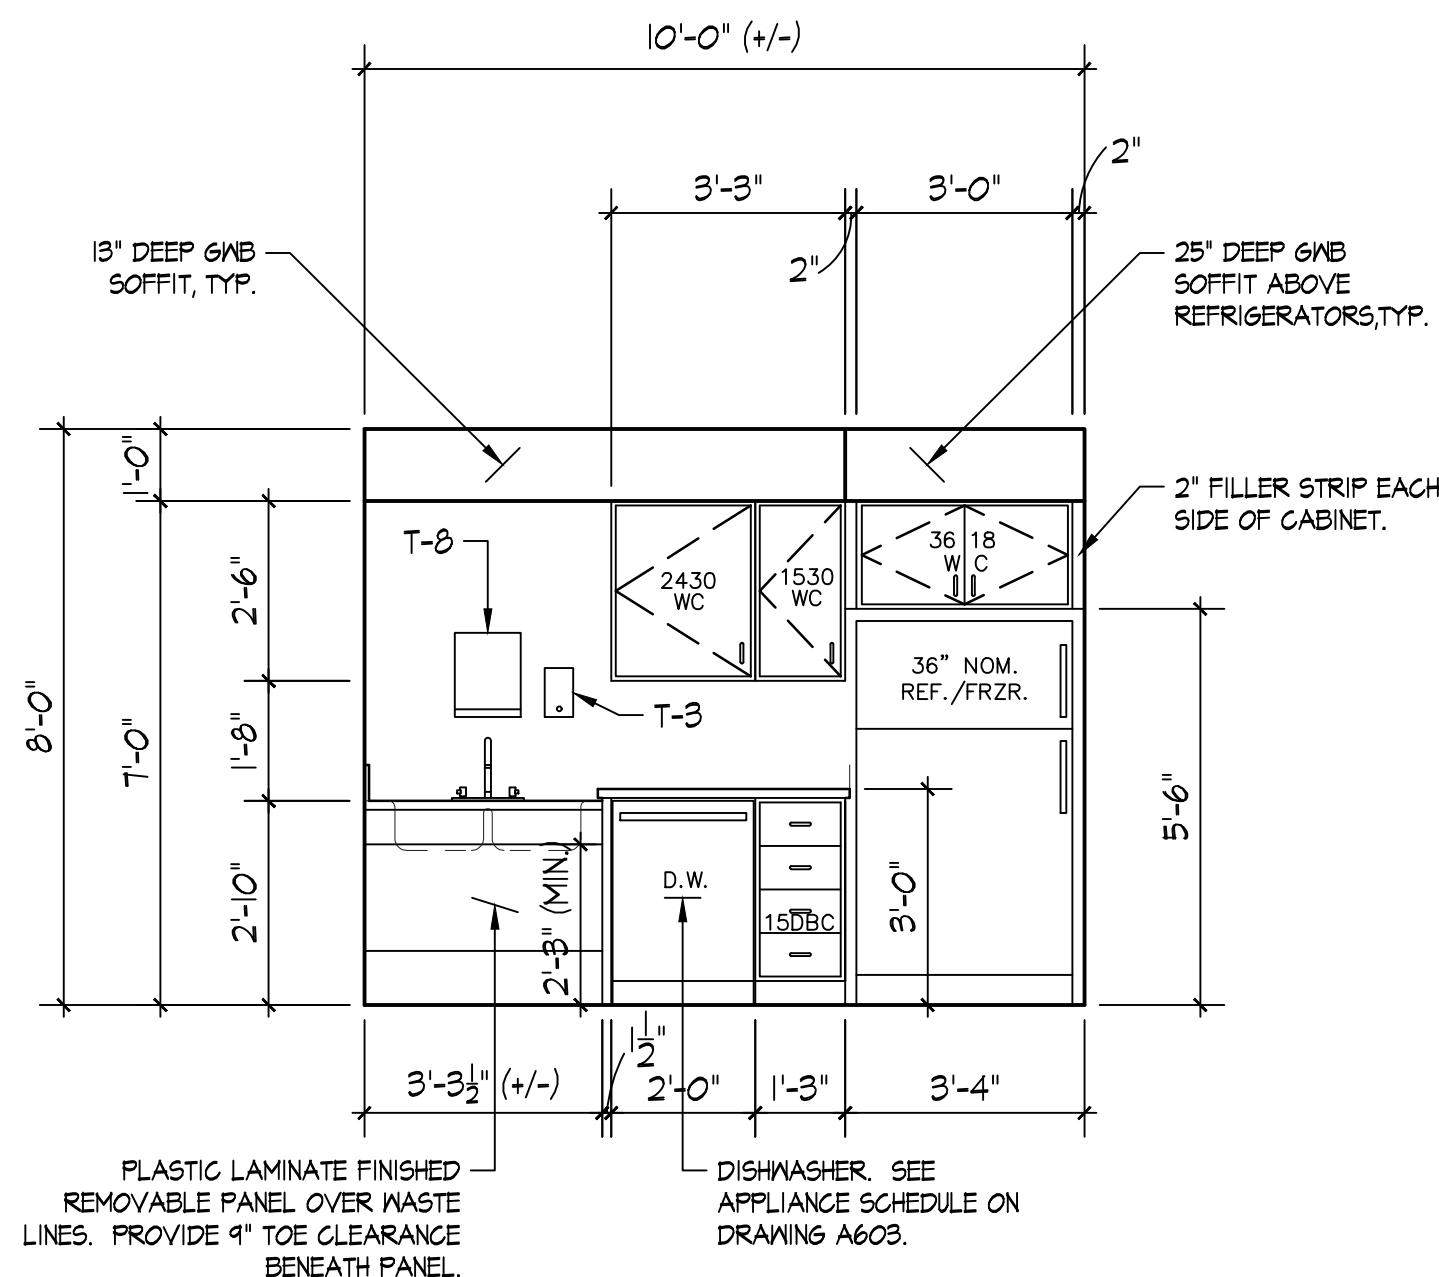
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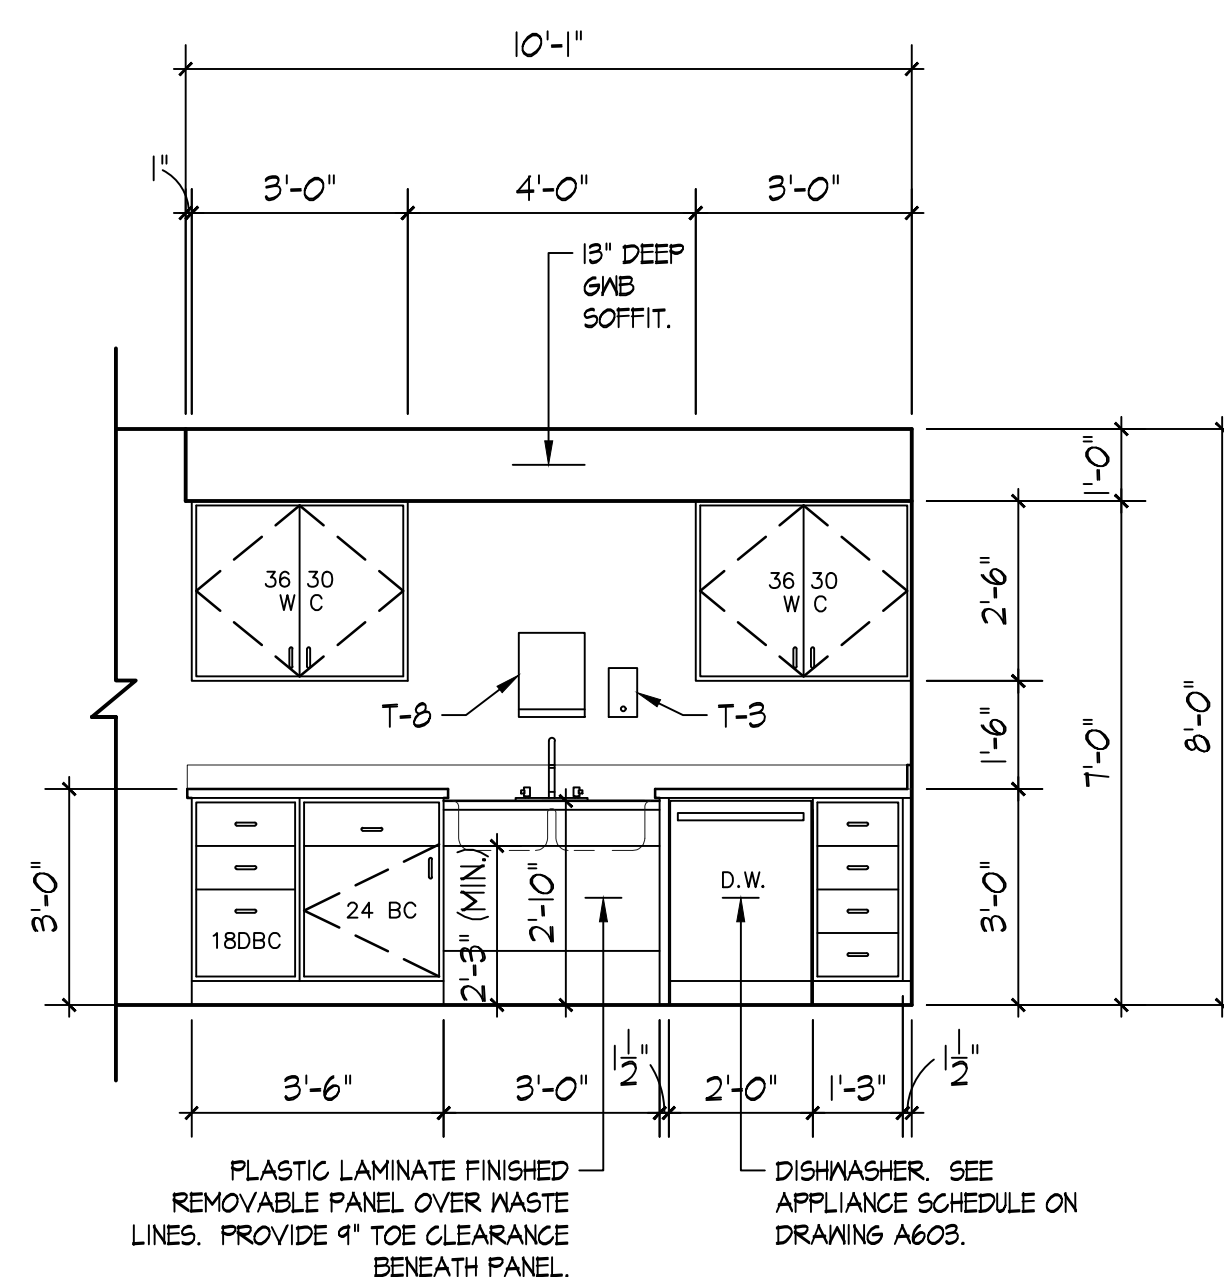
E SHERIFF'S DEPARTMENT CASEWORK
A401 SCALE: 3/8" = 1'-0"




D CAT QUARTERS CASEWORK
A401 SCALE: 3/8" = 1'-0"



C BREAK ROOM CASEWORK
A401 SCALE: 3/8" = 1'-0"



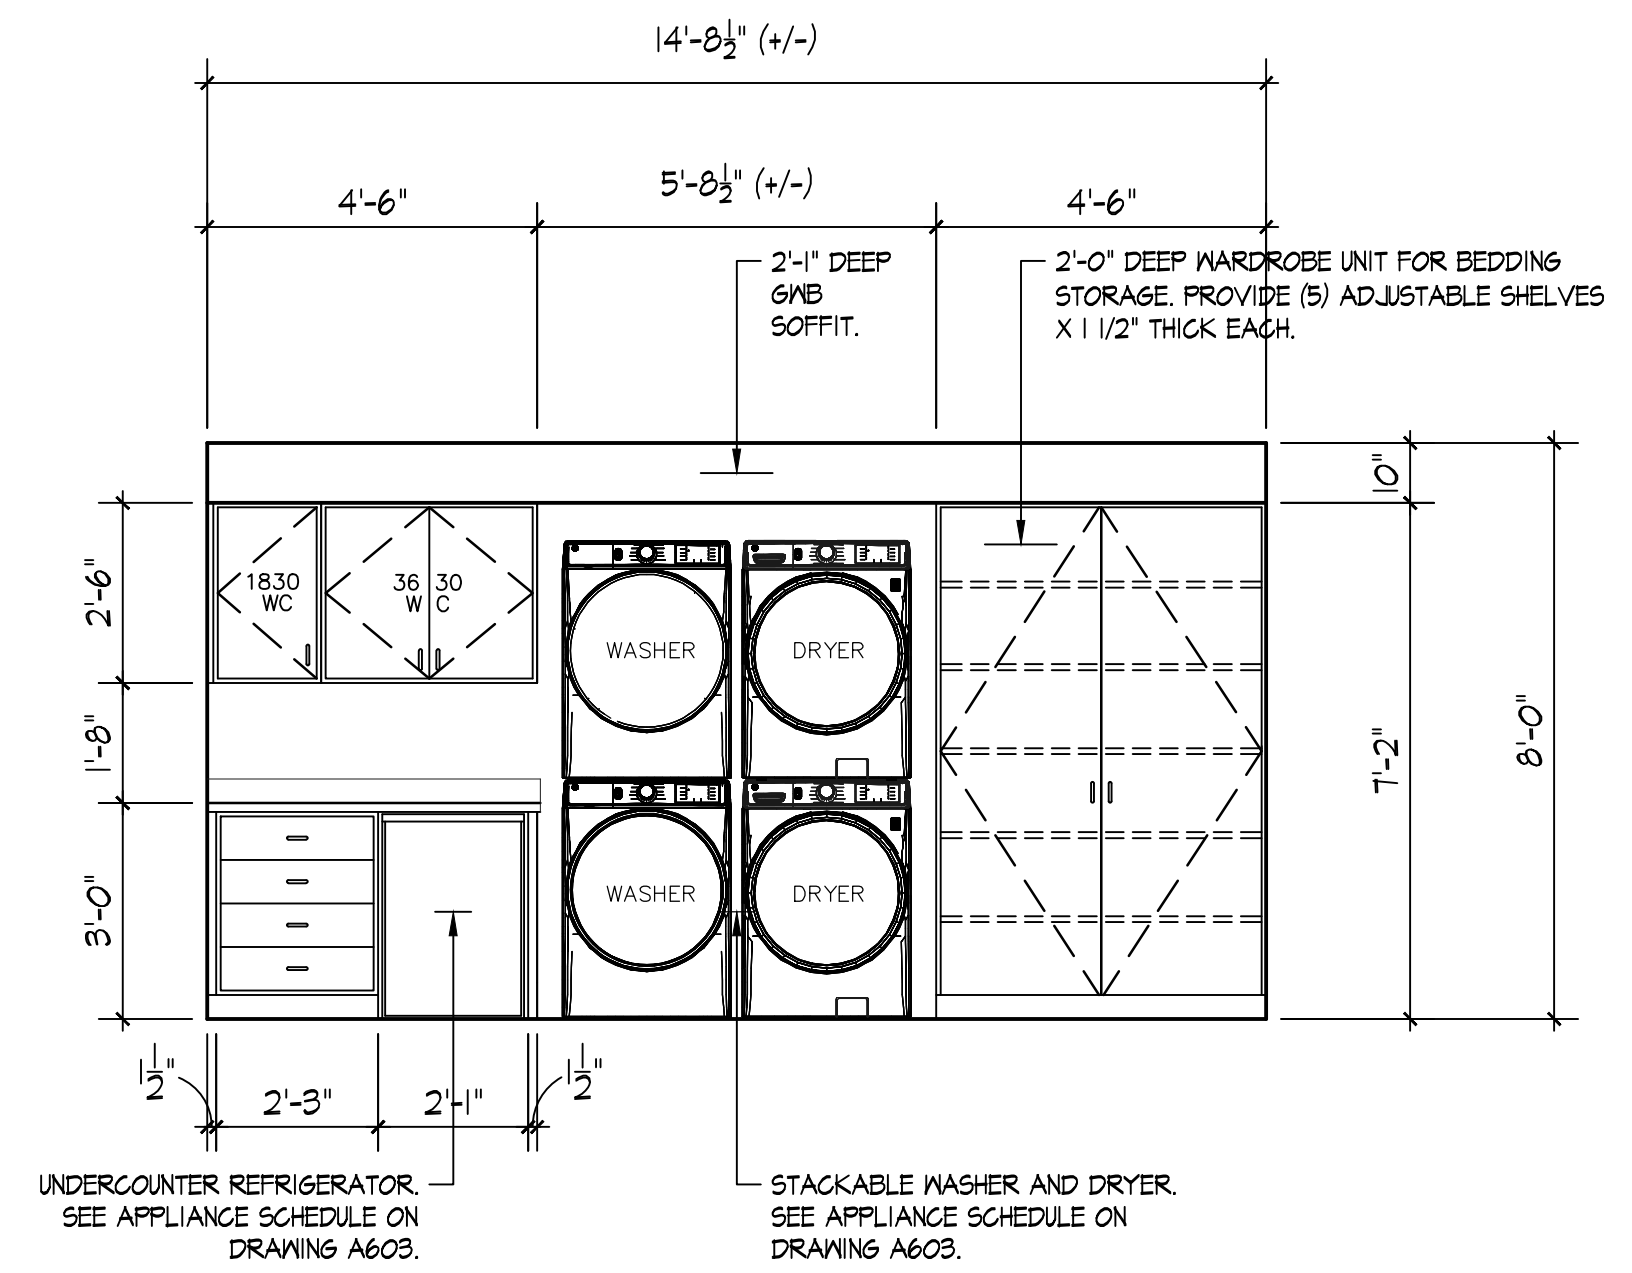B FEEDING AREA CASEWORK
A401 SCALE: 3/8" = 1'-0"



A PROCEDURE ROOM CASEWORK
A401 SCALE: 3/8" = 1'-0"

CABINET ABBREVIATION INDEX

BC	BASE CABINET (32 1/2" HIGH x 24" DEEP CABINET, TYPICAL)
CBC	COUNTER BASE CABINET (38 1/2" HIGH x 24" DEEP CABINET, TYPICAL)
CDBC	COUNTER DRAWER BASE CABINET (38 1/2" HIGH x 24" DEEP CABINET, TYPICAL)
DBC	DRAWER BASE CABINET (32 1/2" HIGH x 24" DEEP CABINET, TYPICAL)
DKD	DESK KNEE DRAWER (KNEE SPACE WIDTH x 24" DEEP, TYPICAL)
ODBC	OPEN-FRONT DESK BASE CABINET (30 1/2" HIGH x 24" DEEP CABINET TYPICAL)
OCBC	OPEN-FRONT COUNTER BASE CABINET (38 1/2" HIGH x 24" DEEP CABINET, TYPICAL)
SBC	SINK BASE CABINET (32 1/2" HIGH x 24" DEEP CABINET, TYPICAL)
WC	WALL CABINET (12" DEEP CABINET, TYPICAL)



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PLUMBING PROVISIONS

RELATED DOCUMENTS: Drawings and general provisions of contract, including General Conditions and General Requirement sections, apply to work of this Section. General Conditions apply to work of this Section.

SCOPE - PLUMBING: Furnish and install all labor, materials, and equipment shown on the Plumbing Drawings and specified herein, including all items and specialties required, whether specified or not, for complete working systems. In general, the Plumbing Work consists of the following:

- 1. Sanitary soil, waste, and vent piping systems and related items with connections as shown on the drawings.
2. Domestic hot and cold water piping and related items with hot and cold water connections as shown on the drawings.
3. Natural gas piping system and related trim.

WORK UNDER OTHER SPECIFICATIONS: All electrical connections required for plumbing work will be furnished and installed under the Electrical Work Specifications. Electrical Contractor to furnish all power wiring required for the equipment except as shown or noted. Under this work, rough out any additional items of equipment furnished under other sections of work. Coordinate closely with the Owner's representatives.

VALVES, DRAINS AND SPECIALTIES - GENERAL PLUMBING: Approved equivalents by Walworth, Powell, Crane, Josam, Wade and Zurn acceptable as they apply. Valves and strainers shall be full size of pipe run; install valve stems vertical up.

- 1. Check Valves: Crane #36 threaded and #1342 solder.
2. Escalchons: Split, chrome plated brass with deep recess where required for sleeves extending above finished floor. Install at sleeves in finished areas.
3. Gate Valves: Crane #424 threaded 2-1/2" and smaller; #7-1/2" standard flanged 3" and larger; and #1334 solder. Jenkins #32A and #1100R ball type acceptable except as noted.
4. Pipe Cleanouts: Zurn Supremo, Series 1400, with cast iron ferrule, all bronze plug and with nickel bronze covers to match surrounding finish.
5. Pipe Hangers: Either adjustable trapeze type, ring type, clevis type or "auto-grip" with minimum 1/4" hanger rod. Install copper plated hangers for uninsulated copper piping. Size hangers to clear insulation on pipework; no cutting of insulation is permitted. See a detail on the drawings for piping supports above new ceilings, where the detail is applicable.
6. Pipe Sleeves: Galvanized Schedule 40 steel pipe set flush with surface for horizontal and 1" above finish floor for sleeves through upper floors. Sleeves will not be required where openings are core drilled. Size sleeves to clear insulation on pipework; no cutting of insulation is permitted. Fire seal all piping extending through fire walls with 3M, or equal, Fire Barrier Penetration Sealing System #CP 25N/S for 2 hour penetrations. Submit the UL Assembly shop drawings for approval.
7. Pipe Unions: Crane ground joint brass-to-iron seat type through 1-1/2" size and flanged 2" and larger, except dielectric unions equal to EPCC shall be installed where different pipe materials join and at each water heater on both cold water and hot water piping.
8. Support Points: Inserts, ramsets, expansion shields, or anchors equal to Phillips Redhead. Power drive is permissible.
9. Square Head Cock with Check (Gas Cock): Crane.

PIPE, FITTINGS AND JOINTS: Pipe and fittings to be according to ASTM Standards for the duty and use. Where piping materials are noted on the plans other than specified herein, make up joints according to manufacturer's directions. Install according to use as follows:

- 1. Domestic Water: Type "L" ASTM B88 hard drawn copper, with wrought solder fittings, except piping exterior of the building, under slabs-on-grade shall be Type "K" soft drawn copper without joints. Clean joint surfaces to bright finish and make up with non-oxid flux and no lead #95-5 solder. 50-50 solder will not be allowed. All piping under slabs on grade shall be encased with 1/2" Armatex insulation. PEX as specified below will be acceptable alternate for copper.
2. Sanitary Soil, Waste and Vent: Schedule 40 P.V.C. with long sweep elbows except through fire rated walls or ceilings provide metal pipe.
3. Natural Gas Piping: Schedule 40 ASTM A53 black steel with screwed joints made up with Teflon tape for sizes 1-1/2" and smaller and welded 2" and larger. All underground piping paper wrapped and coated as per NFPA 54.

DOMESTIC WATER PIPING HOT AND COLD POTABLE WATER DISTRIBUTION:

- REFERENCES:
A. ASTM International
ASTM E84 Standard Test Method for Surface Burning Characteristics of Building Materials
ASTM F876 Standard Specification for Cross-linked Polyethylene (PEX) Tubing
ASTM F877 Standard Specification for Cross-linked Polyethylene (PEX) Plastic Hot and Cold Water Distribution Systems
ASTM F1807 Standard Specification for Metal Insert Fittings Utilizing a Copper Crimp Ring for SDR9 Cross-linked Polyethylene (PEX) Tubing
ASTM F2159 Standard Specification for Plastic Insert Fittings Utilizing a Copper Crimp Ring for SDR9 Cross-linked Polyethylene (PEX) Tubing
B. National Sanitation Foundation (NSF)
Standard 14 Plastics Piping System Components and Related Materials
Standard 61 Drinking Water System Components - Health Effects
C. International Code Council (ICC)
International Mechanical Code
International Plumbing Code
D. International Association of Plumbing Officials (IAPMO)
Uniform Plumbing Code
Uniform Mechanical Code
E. Plastic Pipe Institute (PPI)
Technical Report TR-3 Policies and Procedures for Developing Recommended Hydrostatic Design Stresses for Thermoplastic Pipe Materials
Technical Report TR-4 Recommended Hydrostatic Strengths and Design Stresses for Thermoplastic Piping and Fitting Composites
F. Zurn PEX Inc.
Plumbing Installation Guide

SYSTEM DESCRIPTION

- A. Design Requirements:
Standard Grade hydrostatic pressure ratings from the Plastic Pipe Institute in accordance with TR-3 and listed in TR-4. The following three standard-grade hydrostatic ratings are required:
1. 200 degrees F at 80 psi
2. 180 degrees F at 100 psi
3. 73 degrees F at 160 psi
Tubing tested in general accordance with ASTM E84 for a flame spread/smoke developed index of 25/50 or less for the following PEX tube sizes encased with 1/2 inch fiberglass insulation:
1. 1-1/4 inch
2. 1-1/2 inch
3. 2 inch
Tubing tested in general accordance with ASTM E84 for a flame spread/smoke developed index of 25/50 or less for the following PEX tube sizes;
1. 3/8 inch
2. 1/2 inch
3. 5/8 inch
4. 3/4 inch
5. 1 inch
B. Performance Requirements: To provide a PEX tubing hot and cold potable water distribution system, which is manufactured, fabricated and installed to comply with regulatory agencies and to maintain performance criteria stated by the PEX tubing manufacturer without defects, damage or failure
1. Comply with NSF Standard 14
2. Comply with NSF Standard 61
3. Show compliance with ASTM F877

QUALITY ASSURANCE

- A. Installer Qualifications: Utilize an installer having demonstrated experience on projects of similar size and complexity and possesses the skills and knowledge to install a PEX potable water distribution system. Installer will utilize skilled workers holding a trade qualification license or equivalent or apprentices under the supervision of a licensed tradesperson

DELIVERY, STORAGE AND HANDLING

- A. Delivery - Deliver materials in manufacturer's original, unopened, undamaged containers with identification labels intact until ready for installation
B. Storage and Protection - Store materials protected from exposure to harmful environmental conditions and at temperature and humidity conditions recommended by the manufacturer.
Store PEX tubing indoors, in cartons or under cover to avoid dirt or foreign material from entering the tubing.
Do not expose PEX tubing to direct sunlight for more than six months. If construction delays are encountered, cover the tubing that is exposed to direct sunlight.

WARRANTY

Manufacturer's Warranty: Shall cover the repair or replacement of properly installed tubing and fittings proven defective as well as incidental damages
Warranty period for PEX tubing and subsequent system shall be 25 year non-prorated warranty against failure due to defect in material or workmanship, beginning with the date of installation.
It is the installer's responsibility to avoid mixing fittings manufactured by others as it will reduce the owner's warranty

HOT AND COLD POTABLE WATER DISTRIBUTION SYSTEM: All products, components, etc. specified herein are manufactured by and/or are available from Zurn PEX, Inc. tubing manufacturer

PRODUCT SUBSTITUTION: No substitutions are permitted

INSULATION PROVISIONS

RELATED DOCUMENTS: Drawings and general provisions of contract, including General Conditions and General Requirement sections, apply to work of this Section.

SCOPE - INSULATION SYSTEMS: Furnish and install all labor, materials and equipment shown on the mechanical drawings and as specified herein, including all items and specialties required, whether specified or not, for complete systems of pipe insulation. External ductwork insulation specified in other sections of this DIVISION are not a part of this section and will be furnished and installed under other sections of this DIVISION. In general, the insulation work consists of the following work:

- 1. Insulation of domestic hot and cold water piping systems.
INSULATION: HOT AND COLD PIPING: Install molded fiberglass insulation with vapor-barrier jacket and butted solidly together with joints and seams staggered. Cover fittings with molded insulation sections. For hot piping, seal joints and flaps with Lagtone and cover fittings with 8 oz. canvas jacket over Lagtone sealer and sealed on with Lagtone, sealing off insulation ends with jacket and Lagtone. For cold piping, seal joints and flaps with adhesive, sealing off insulation ends with mastic. Cover insulated fittings with 0.002" thick aluminum foil sealed on with adhesive and cover with 8 oz. canvas jacket and coat of mastic. Fitting covers equal to one piece PVC "Zeston" covers shall be used.

Install insulation thickness on piping as follows:
1. Domestic Water Systems and Condensate Piping 1/2"

Equal materials, mastics, adhesives, and sealers made by Manville, Gullitt-Beacon, Foster, Armstrong and PPG Industries are acceptable when labeled and/or listed. Adhesives, mastics and insulation materials used shall be Underwriter's labeled and/or listed for a maximum rating of 25 for flame and 50 for smoke.

INSTALLATION - INSULATION SYSTEMS: Install this work using mechanics experienced in the trade. Systems shall be completely erected and tested and all surfaces shall be clean and dry prior to application of insulation. For insulation, install saddles between support and insulation of all piping support points equal to Fee & Mason, Figure 171, for hot piping and minimum 20 gage galvanized steel saddles 18" long for cold piping. Install rigid insulation sections in cold piping insulation at saddles, sealing the rigid section to the run of insulation. Install insulation continuous through sleeves or core drilled holes for cold piping. Stopping of pipe insulation on cold water is not acceptable unless all staples are vapor sealed with mastic to the Engineer's satisfaction. No duct tape will be allowed on any insulation system. A continuous vapor barrier seal will be required on all cold water systems. Failure to maintain this barrier will not be allowed.

END OF SECTION

ELECTRICAL PROVISIONS

RELATED DOCUMENTS: Drawings and General Provisions of Contract, including General Conditions and Division I General Requirement Sections, apply to work of this section.

DESCRIPTION OF WORK: Furnish and install all labor, materials, and equipment shown on the drawings and specified herein, including all items and specifications required, whether specified or not, for complete working systems. In general, the Electrical Work consists of the following:

- 1. Secondary distribution with connections as detailed.
2. Wiring and equipment for lighting and power, together with lighting fixtures and devices.
3. Wiring and connecting equipment of other trades.
4. Power service shall be 3 phase 4 wire 208Y/120 volts.

CONNECTION TO OTHER SPECIFICATION WORK: Under this work division, furnish and install all labor and materials, together with the required switches, for connecting power to heating, air conditioning and ventilation, plumbing, and Owner-supplied equipment.

SECONDARY WIRE AND CABLE: Except as noted, install minimum #12 AWG 600-volt copper Type THHN/THWN or as noted on the drawings. Install solid conductors for #10 size and smaller. No aluminum wire will be allowed. #8 wire and larger shall be stranded copper. Although not necessarily shown, provide a complete "green" ground throughout bonded and grounded as per NEC.

RACEWAYS: Install conduit, wireways and surface metal raceways of malleable steel material and with electric or hot-dip galvanized or rust resistant finish. Use no aluminum conduit. Conceal all raceways where possible. Install liquid-tight "Greenfield" with grounding conductors in outdoor, or wet locations and at all motor connections and other points subject to vibration. Install rigid conduit with threaded fittings as required by the National Electrical Code on service conduits to above finished floor line or as noted. Other conduit runs may be electric metallic tubing with malleable steel compression or set screw type connectors. Bushings for conduit 2" and smaller shall be plastic. Bushings for conduit 2-1/2" and larger shall be equal to Appleton Efor Series 55 or OZ type "B" with metal ring and insulator as an integral part of the bushing.

BOXES, CABINETS, SUPPORTS AND SPECIALTIES: Install of galvanized malleable steel alloy. Install cabinets with grooved finish on exposed surfaces and removable trim with hinged doors and flush locks, all keyed alike. Install boxes underground, for exterior outlets and as required by the National Electric Code with threaded cast hubs and gasketed covers attached with screws. Pressed boxes will not be allowed. Unless noted otherwise, install other switches, receptacles, and lighting outlets of pressed steel box with proper cover and size and with ears and studs where required. Ceiling outlet boxes shall be minimum 4" octagon 2-1/8" deep and with extension rings where additional volume is required. Single gang wall boxes shall be minimum 4" high X 2-1/8" wide X 2-1/8" deep except boxes in masonry shall be 2-1/2" deep. Boxes shall be equal to Steel City, Appleton or Raco. Use solid gang box for two gangs or more.

PANELBOARD & BREAKERS: Install safety dead front breaker type, surface mounting as required and shown. All breakers quick-make and quick-break with trip free handles, thermal-magnetic trip. Multi pole breakers shall have a common trip. All breakers ambient compensated and all interiors with integrated capacity bussing. All branch breaker handles shall operate in the same plane. Furnish all "spare" breakers. All H.V.A.C. equipment breakers shall be H.A.C.R. rated. See the plans for schedules indicating number of branch circuits, ratings, arrangements, etc.. Provide neutral bars for all system feeders isolated from the panel box. Provide separate "ground" bars installed with lugs or connected to the panel box. Bus bars shall be of sequence phase type arranged for the specified service. All circuits shown as common neutral shall be installed as per N.E.C. Where relays, time clocks or contactors are called for, provide panelboard with oversized can for installation. Separate cans adjacent to the panelboard, and mounted same as the panelboard, are acceptable.

SAFETY SWITCHES: Install safety switches of heavy duty rating, and with dual element, time lag, cartridge type fuses. Except as noted, install all units with general purpose enclosures inside or NEMA 3R outside. Furnish owner with 1 set of "spare" fuses in addition to all required fuses.

LIGHTING FIXTURES: Install according to schedule and complete with lamps and any hangers, plaster frames and other accessories. Verify ceiling systems for recessed fixture trim. Ceiling system suspension shall not be used for Luminaire suspension. All luminaires shall be independently hung by wire or other approved means./ Guarantee electronic's replacement for 12 months after final acceptance of project. Support all lay-in-type fixtures from structure above with wire hangers. LED luminaires shall meet or exceed IES LM-79, IES LM-80, and IES TM-21.

PHONE/CABLE/DATA SERVICE: Coordinate with owner for all telephone service requirements.

INSTALLATION: Install gear with operating handles maximum 6-feet from floor and trims in line. Provide typed directory for panelboard and engraved laminated plastic labels for switches and main service breakers. Install raceways parallel or perpendicular to building members. Close conduit runs during construction. Apply waterproofing compound to joints in rigid conduit runs. Install fittings and supports of same material and finish as conduit. Support raceways with brackets, hangers, or other approved devices. Use no perforated strap or wire hangers. Install pull boxes or points for maximum 200' run and 3 quarter bends in wiring conduit runs and 100' of run and 2 quarter bends in signal and communications conduit runs. Install long sweep elbows in signal and communications conduit runs. Use expansion fittings for crossing building expansion joints. Except for terminations in threaded hubs, lock conduit in place with proper fittings and install bushing. Leave bare copper pull wires in all empty conduit runs. Bond and ground all systems in accordance with N.E.C. As required or as shown on plans, install boxes and devices on surface or flush with building finish, with units rigidly fastened in place properly aligned. Box extensions may be used. Verify door swings prior to roughing for lighting switches. Install a plate for all devices, including blank plates over blank boxes, plates to be in continuous contact with building finish and set to support box. Pull wire only after areas are cleaned and pull with proper lubricants and continuous between boxes without splice. Make up splices in Wire #10 or smaller with ideal "Wing Nuts" and in larger wire with approved mechanical connectors and tape. After installation, megger electrical work for grounds and shorts and correct as required. Color code conductors as directed by Owner. Install Health Care type MN cable per N.E.C. and local rules.

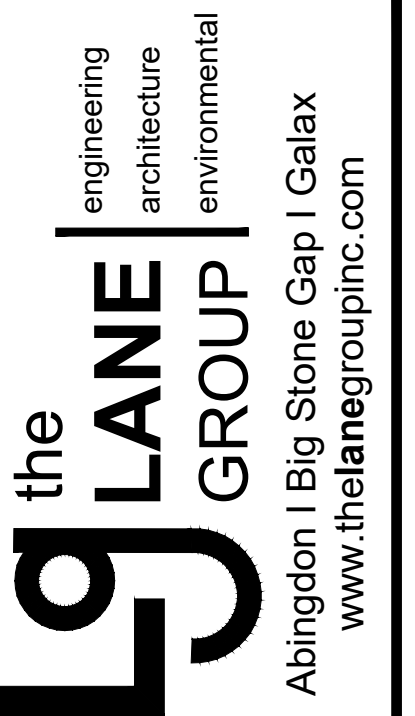
TESTING: In conjunction with this work, the Contractor shall do the following:

- 1. Check outlets for proper polarity and correct as required.
2. Megger all motor and solenoid windings before connection for insulation resistance and record readings. If found low, advise supplier so that steps may be taken to dry out insulation or otherwise raise insulation resistance to an acceptable value.
3. Check running currents of all motors and if there is any major unbalance or variation from rated, determine the cause.

END OF SECTION

END OF ELECTRICAL & MECHANICAL PROVISIONS

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BUILDING RENOVATION FOR
WASHINGTON COUNTY, VIRGINIA
ANIMAL SHELTER
15050 LEE HIGHWAY
BRISTOL, VIRGINIA 24201

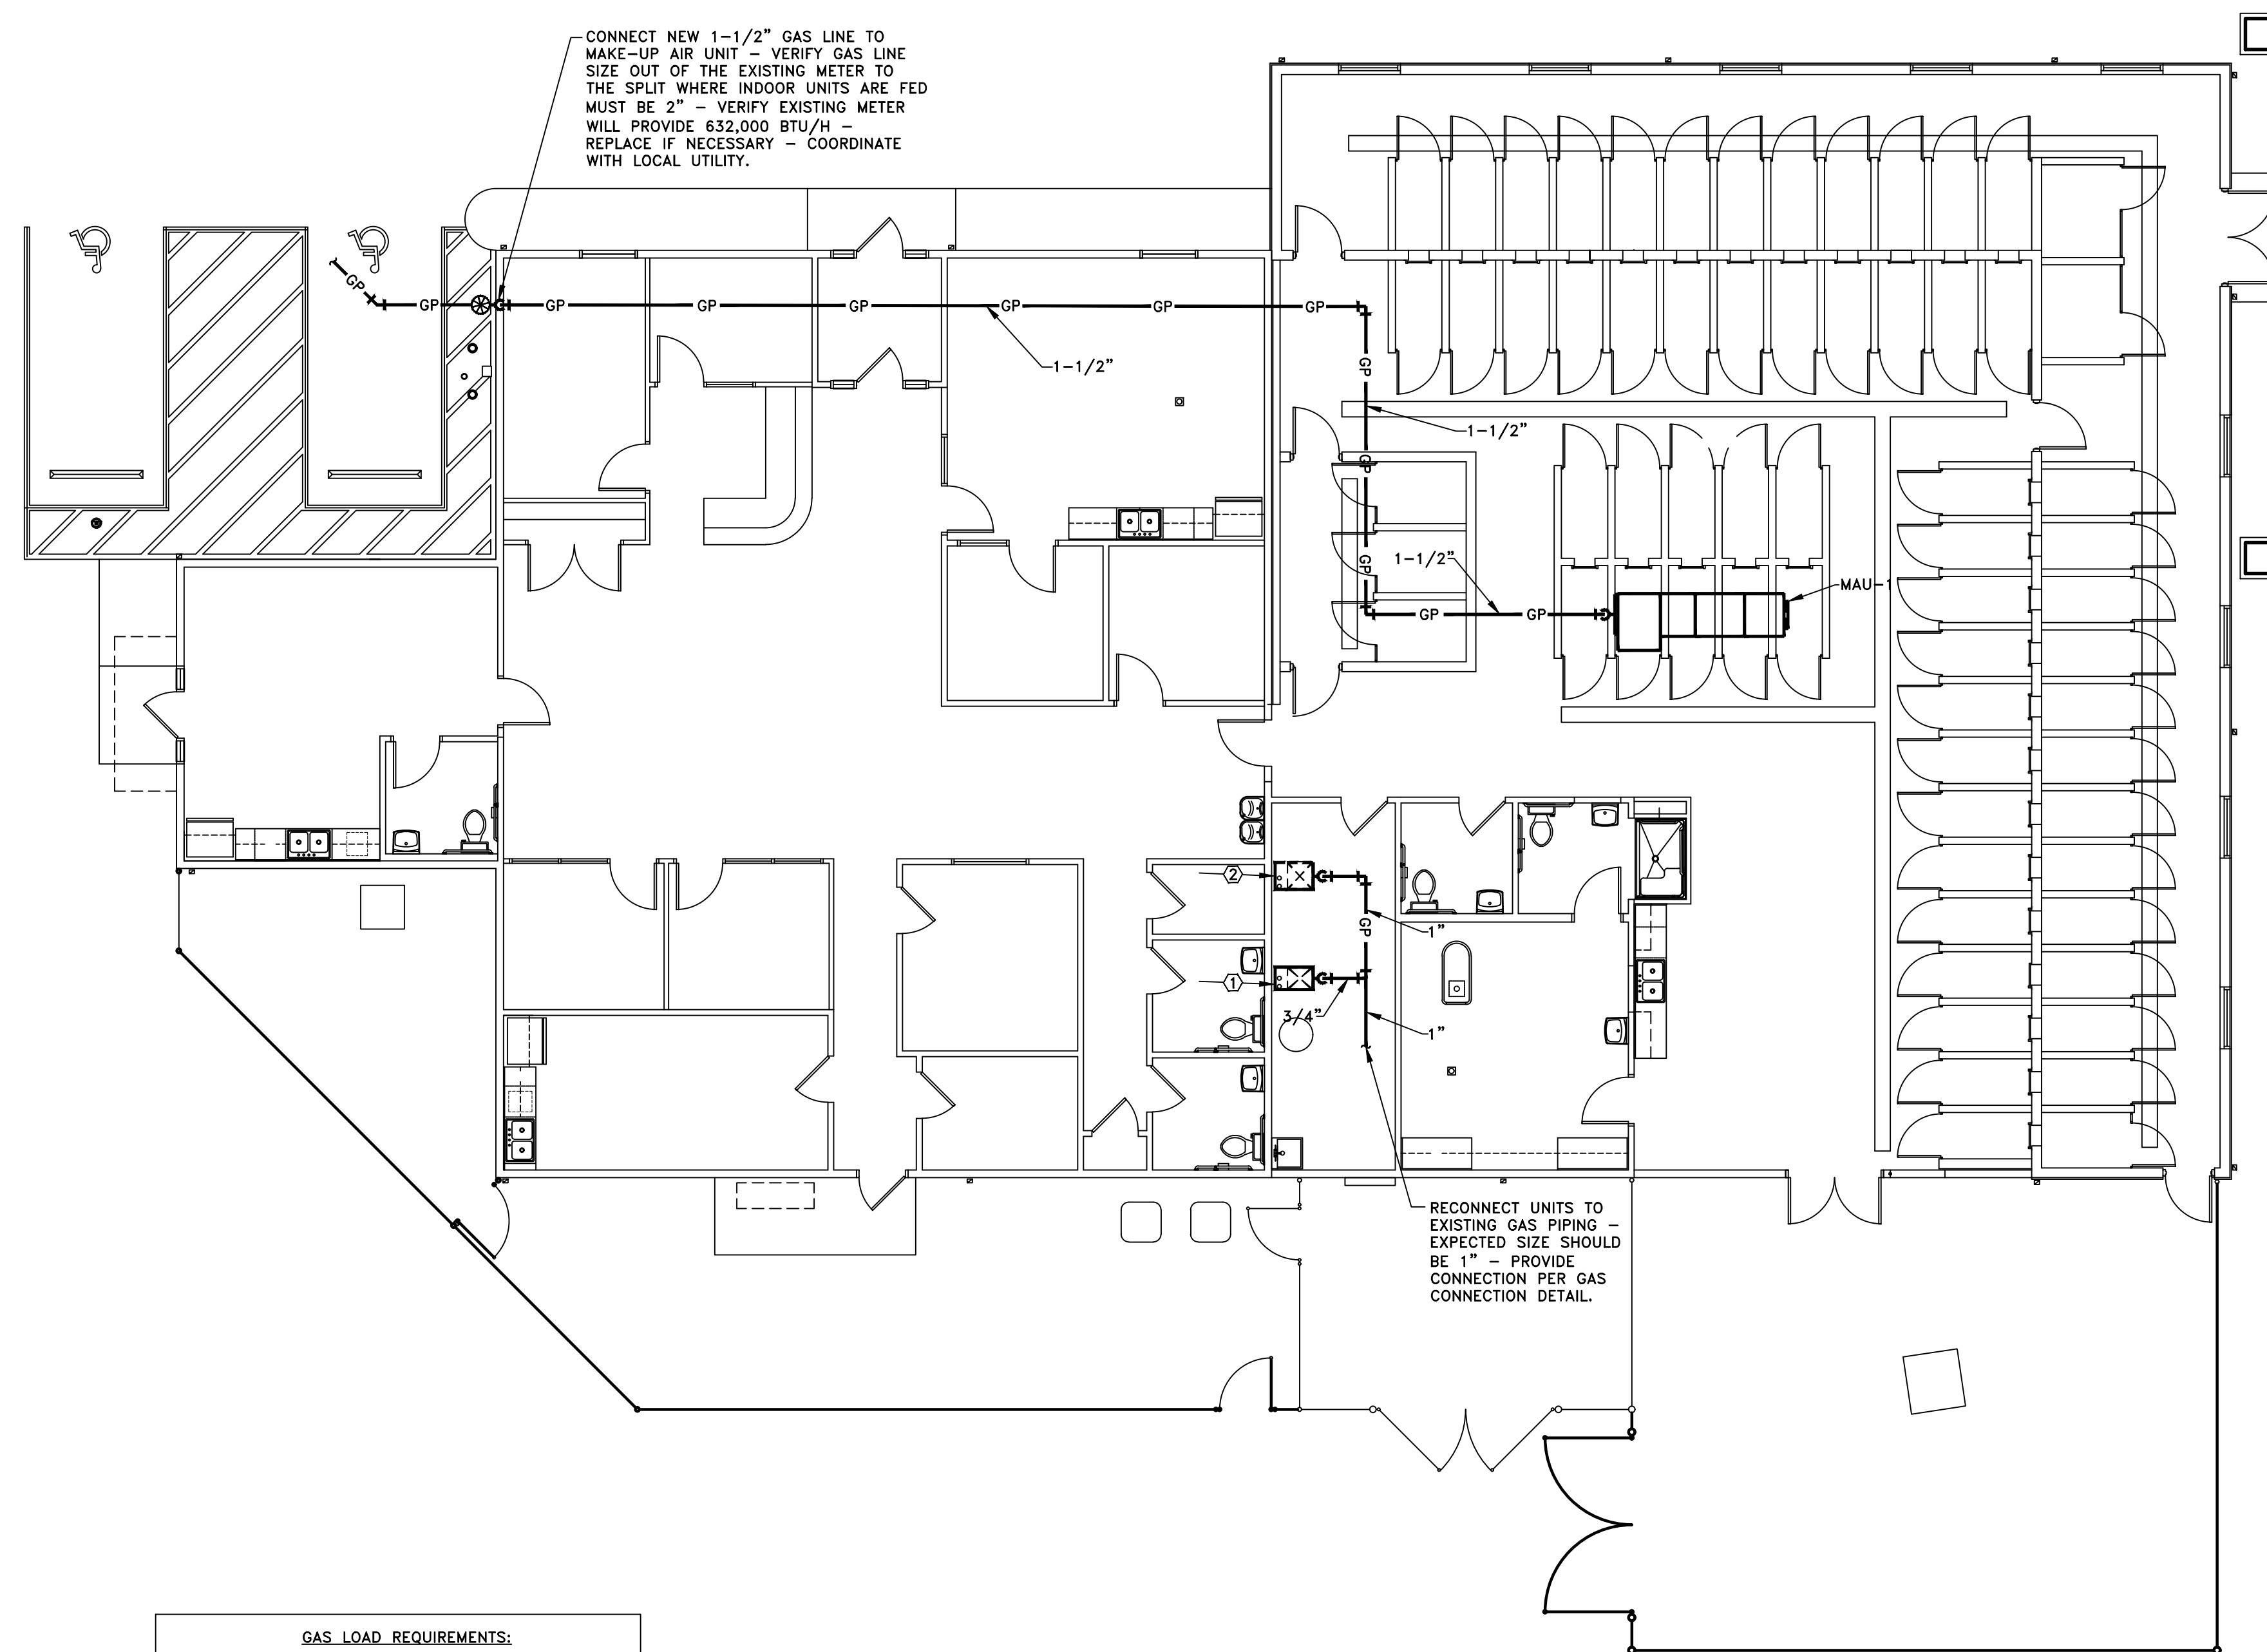
MECHANICAL, PLUMBING,
AND ELECTRICAL
SPECIFICATIONS

Table with columns for DATE, REVISION DATE, NO., and SHEET. Includes project details like MPE102 and drawing information like TLG-22136.




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301 MONTGOMERY ST., SUITE #4, JOHNSON CITY, TN 37604 (423)926-5991 holston.engineering@holsteng.com

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- NOTES:
1. ALL GAS PIPING MUST BE INSTALLED AND TESTED IN STRICT ACCORDANCE WITH NFPA 54.
 2. PROVIDE GAS COCK AND DRIP LEG AT EACH USER CONNECTION.
 3. SEE SPECIFICATIONS FOR PIPING REQUIREMENTS.
 4. CONNECT ALL EQUIPMENT PER MANUFACTURER'S RECOMMENDATIONS.

GAS LOAD REQUIREMENTS:	
①	GAS FURNACE/ELECTRIC COOLING SPLIT SYSTEM 44,000 BTU/H
②	GAS FURNACE/ELECTRIC COOLING SPLIT SYSTEM 88,000 BTU/H
MAU-1	MAKE-UP AIR UNIT HEATING AND VENTILATION ONLY 500,000 BTU/H
TOTAL BTU/H 632,000 BTU/H	
ESTIMATED LINEAR FOOTAGE 125 FT.	



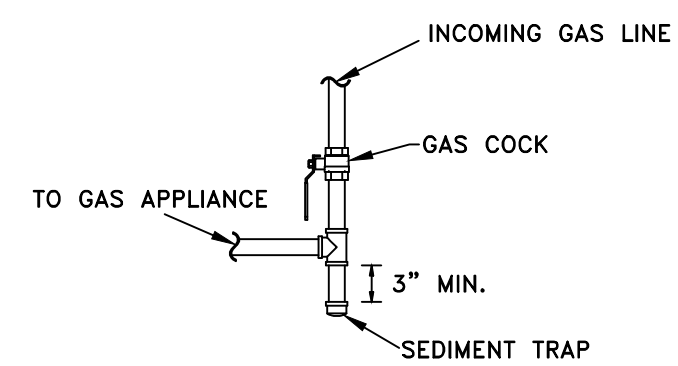TYPICAL GAS CONNECTION DETAIL
NO SCALE

GAS PIPING FLOOR PLAN

SCALE: 1/8" = 1'-0"

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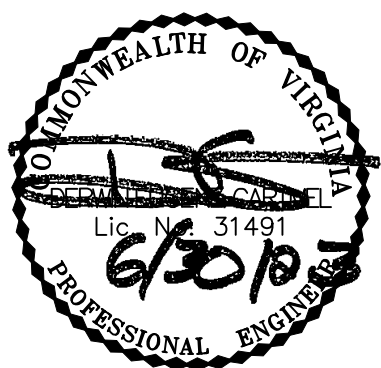
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PLOT DATE: 06/30/2023

HE PROJECT #23-008

BUILDING RENOVATION FOR
WASHINGTON COUNTY, VIRGINIA
ANIMAL SHELTER
15050 LEE HIGHWAY
BRISTOL, VIRGINIA 24201

GAS PIPING FLOOR PLAN



DATE: 06-30-2023

NO. REVISION DATE

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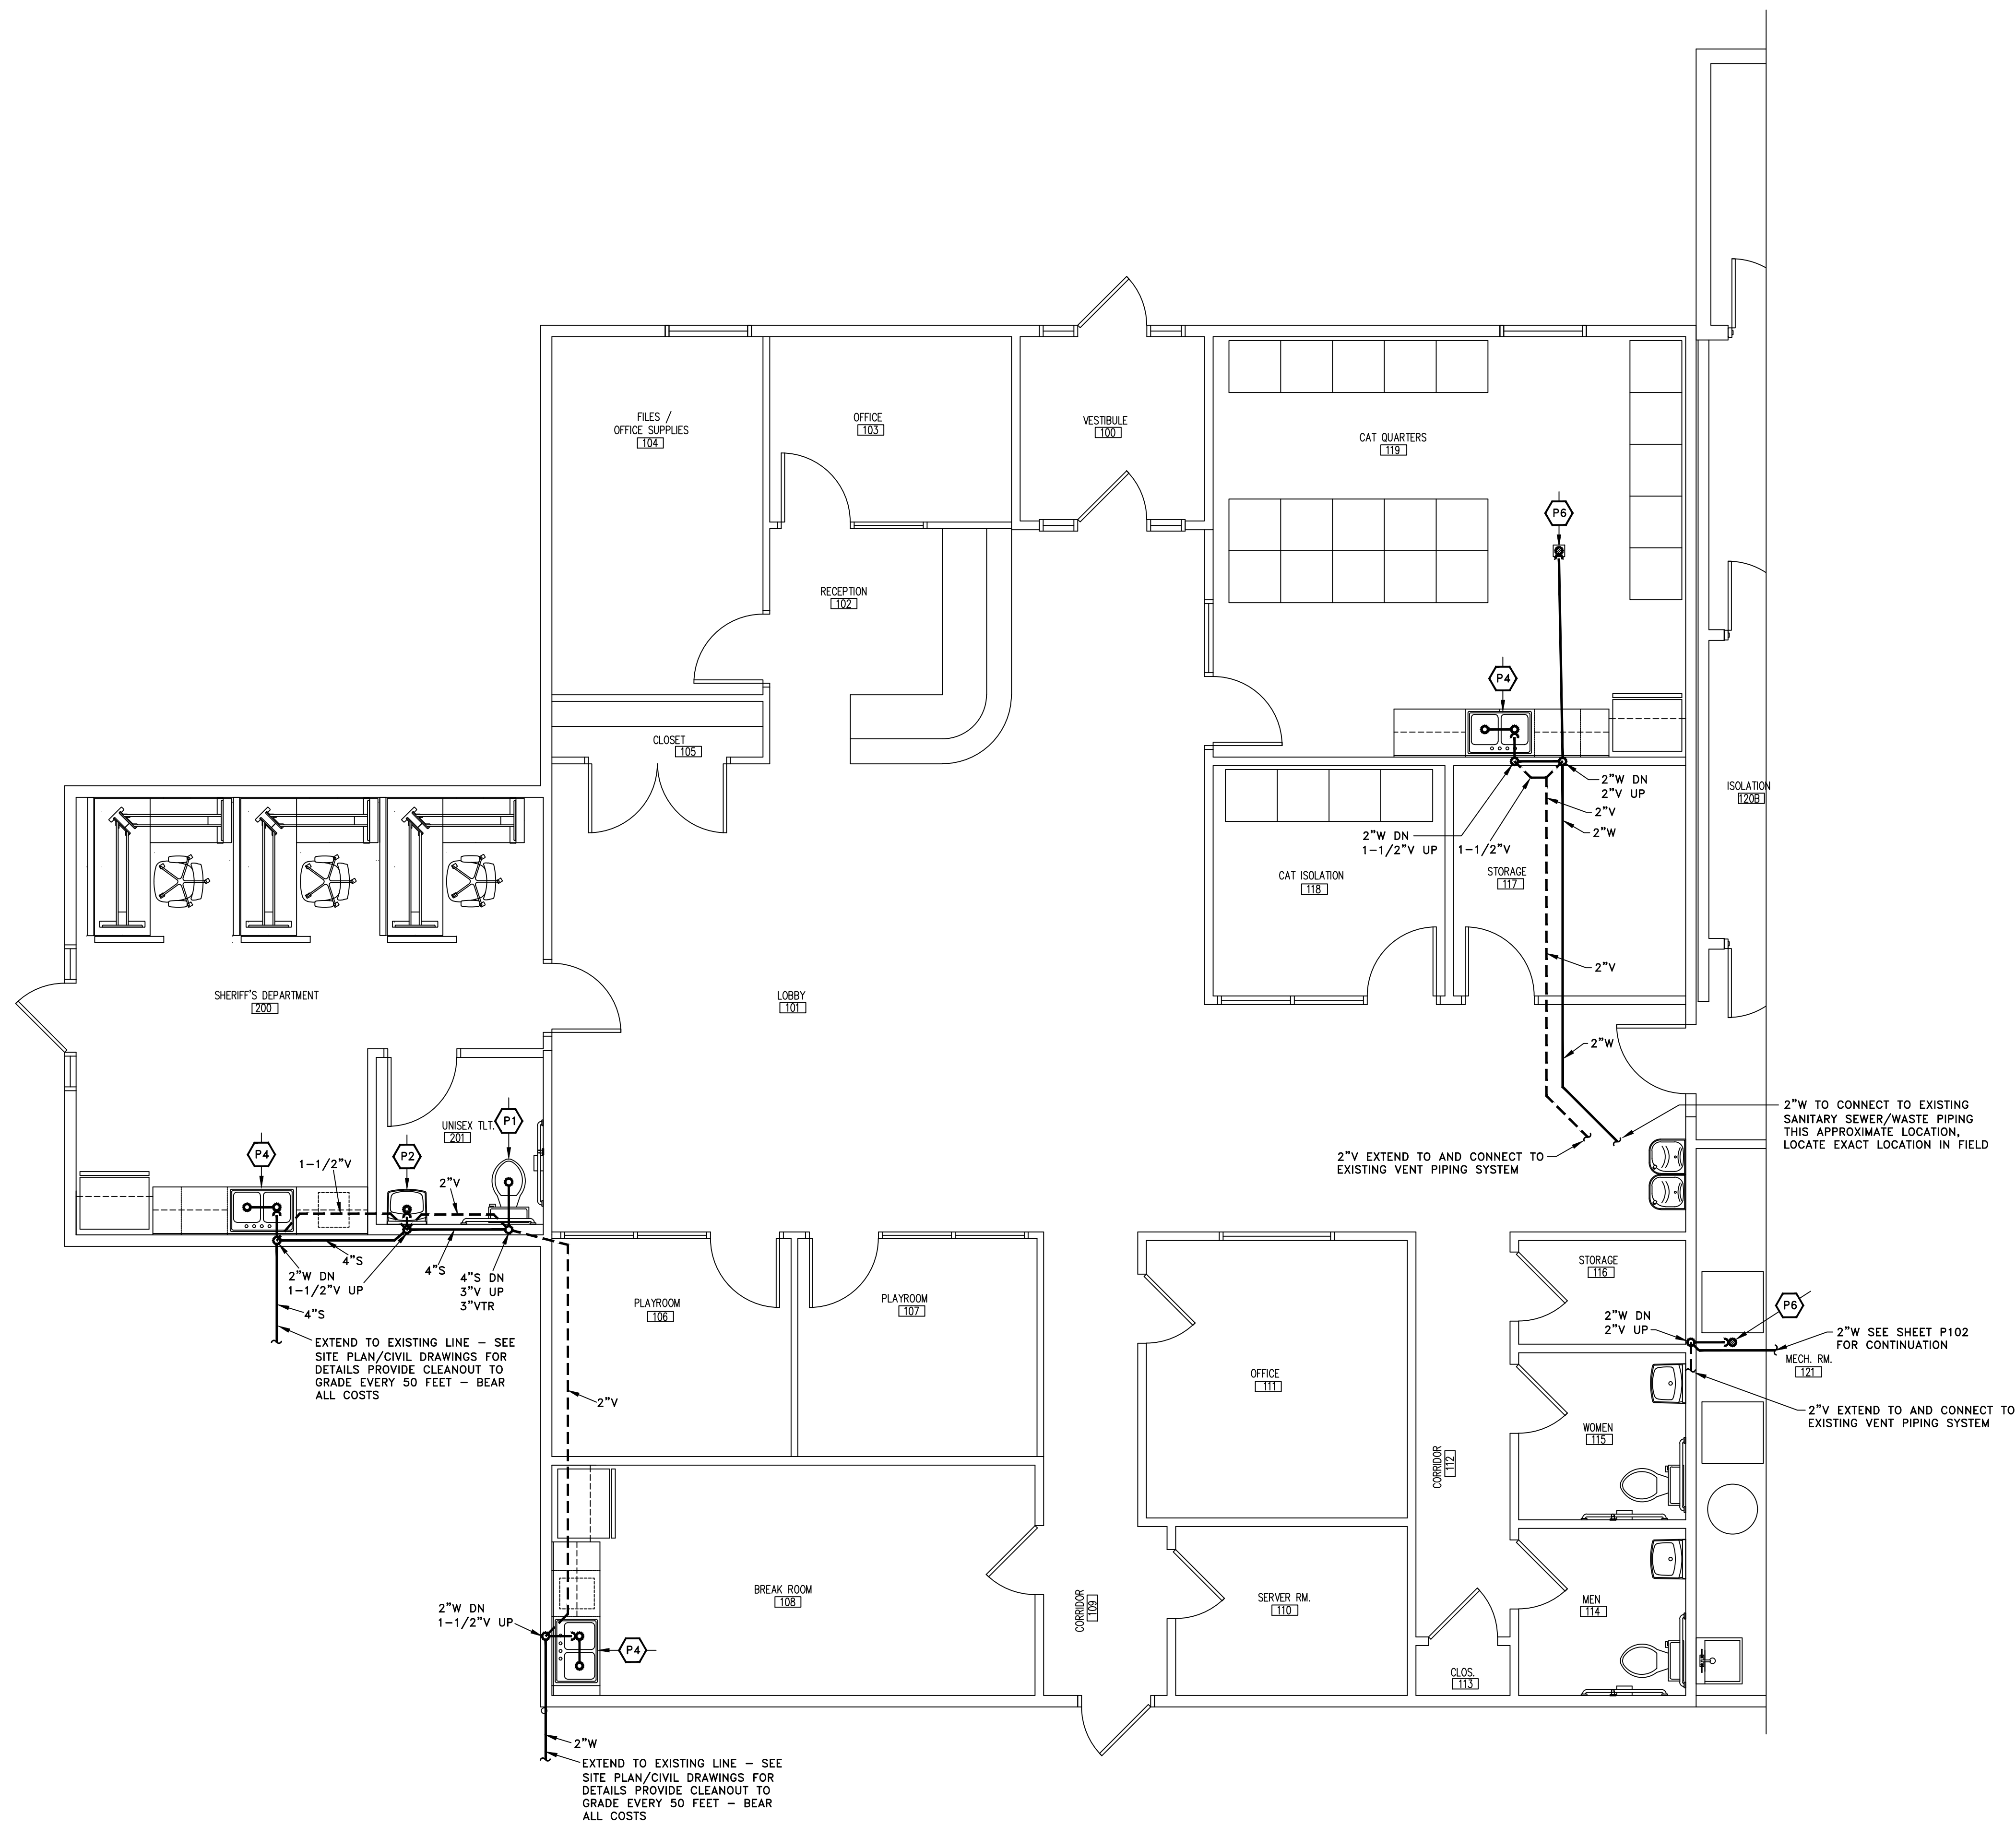
SHEET: GP101

DRAWN BY: WRH CHECKED BY: DEC

PROJECT NO: TLG-22136

THE LANE GROUP INC.

the **LANE** GROUP
engineering architecture environmental
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Abingdon, VA 24210
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SANITARY SEWER, WASTE, AND VENT PIPING FLOOR PLAN

SCALE: 1/4" = 1'-0"

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PLOT DATE: 06/30/2023

HE PROJECT #23-008

**BUILDING RENOVATION FOR
WASHINGTON COUNTY, VIRGINIA
ANIMAL SHELTER
15050 LEE HIGHWAY
BRISTOL, VIRGINIA 24201**

**SANITARY SEWER, WASTE,
& VENT PIPING FLOOR
PLAN**



DATE: 06-30-2023

NO. REVISION DATE

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SHEET: **P101**


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PROJECT NO: TLG-22136

THE LANE GROUP INC.

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architecture
environmental
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- NOTES:
1. RE-PIPE ALL DOMESTIC COLD AND HOT WATER
 2. RECONNECT EXISTING FIXTURES THAT WILL REMAIN
 3. CONNECT NEW FIXTURES AS SHOWN

DOMESTIC WATER PIPING FLOOR PLAN

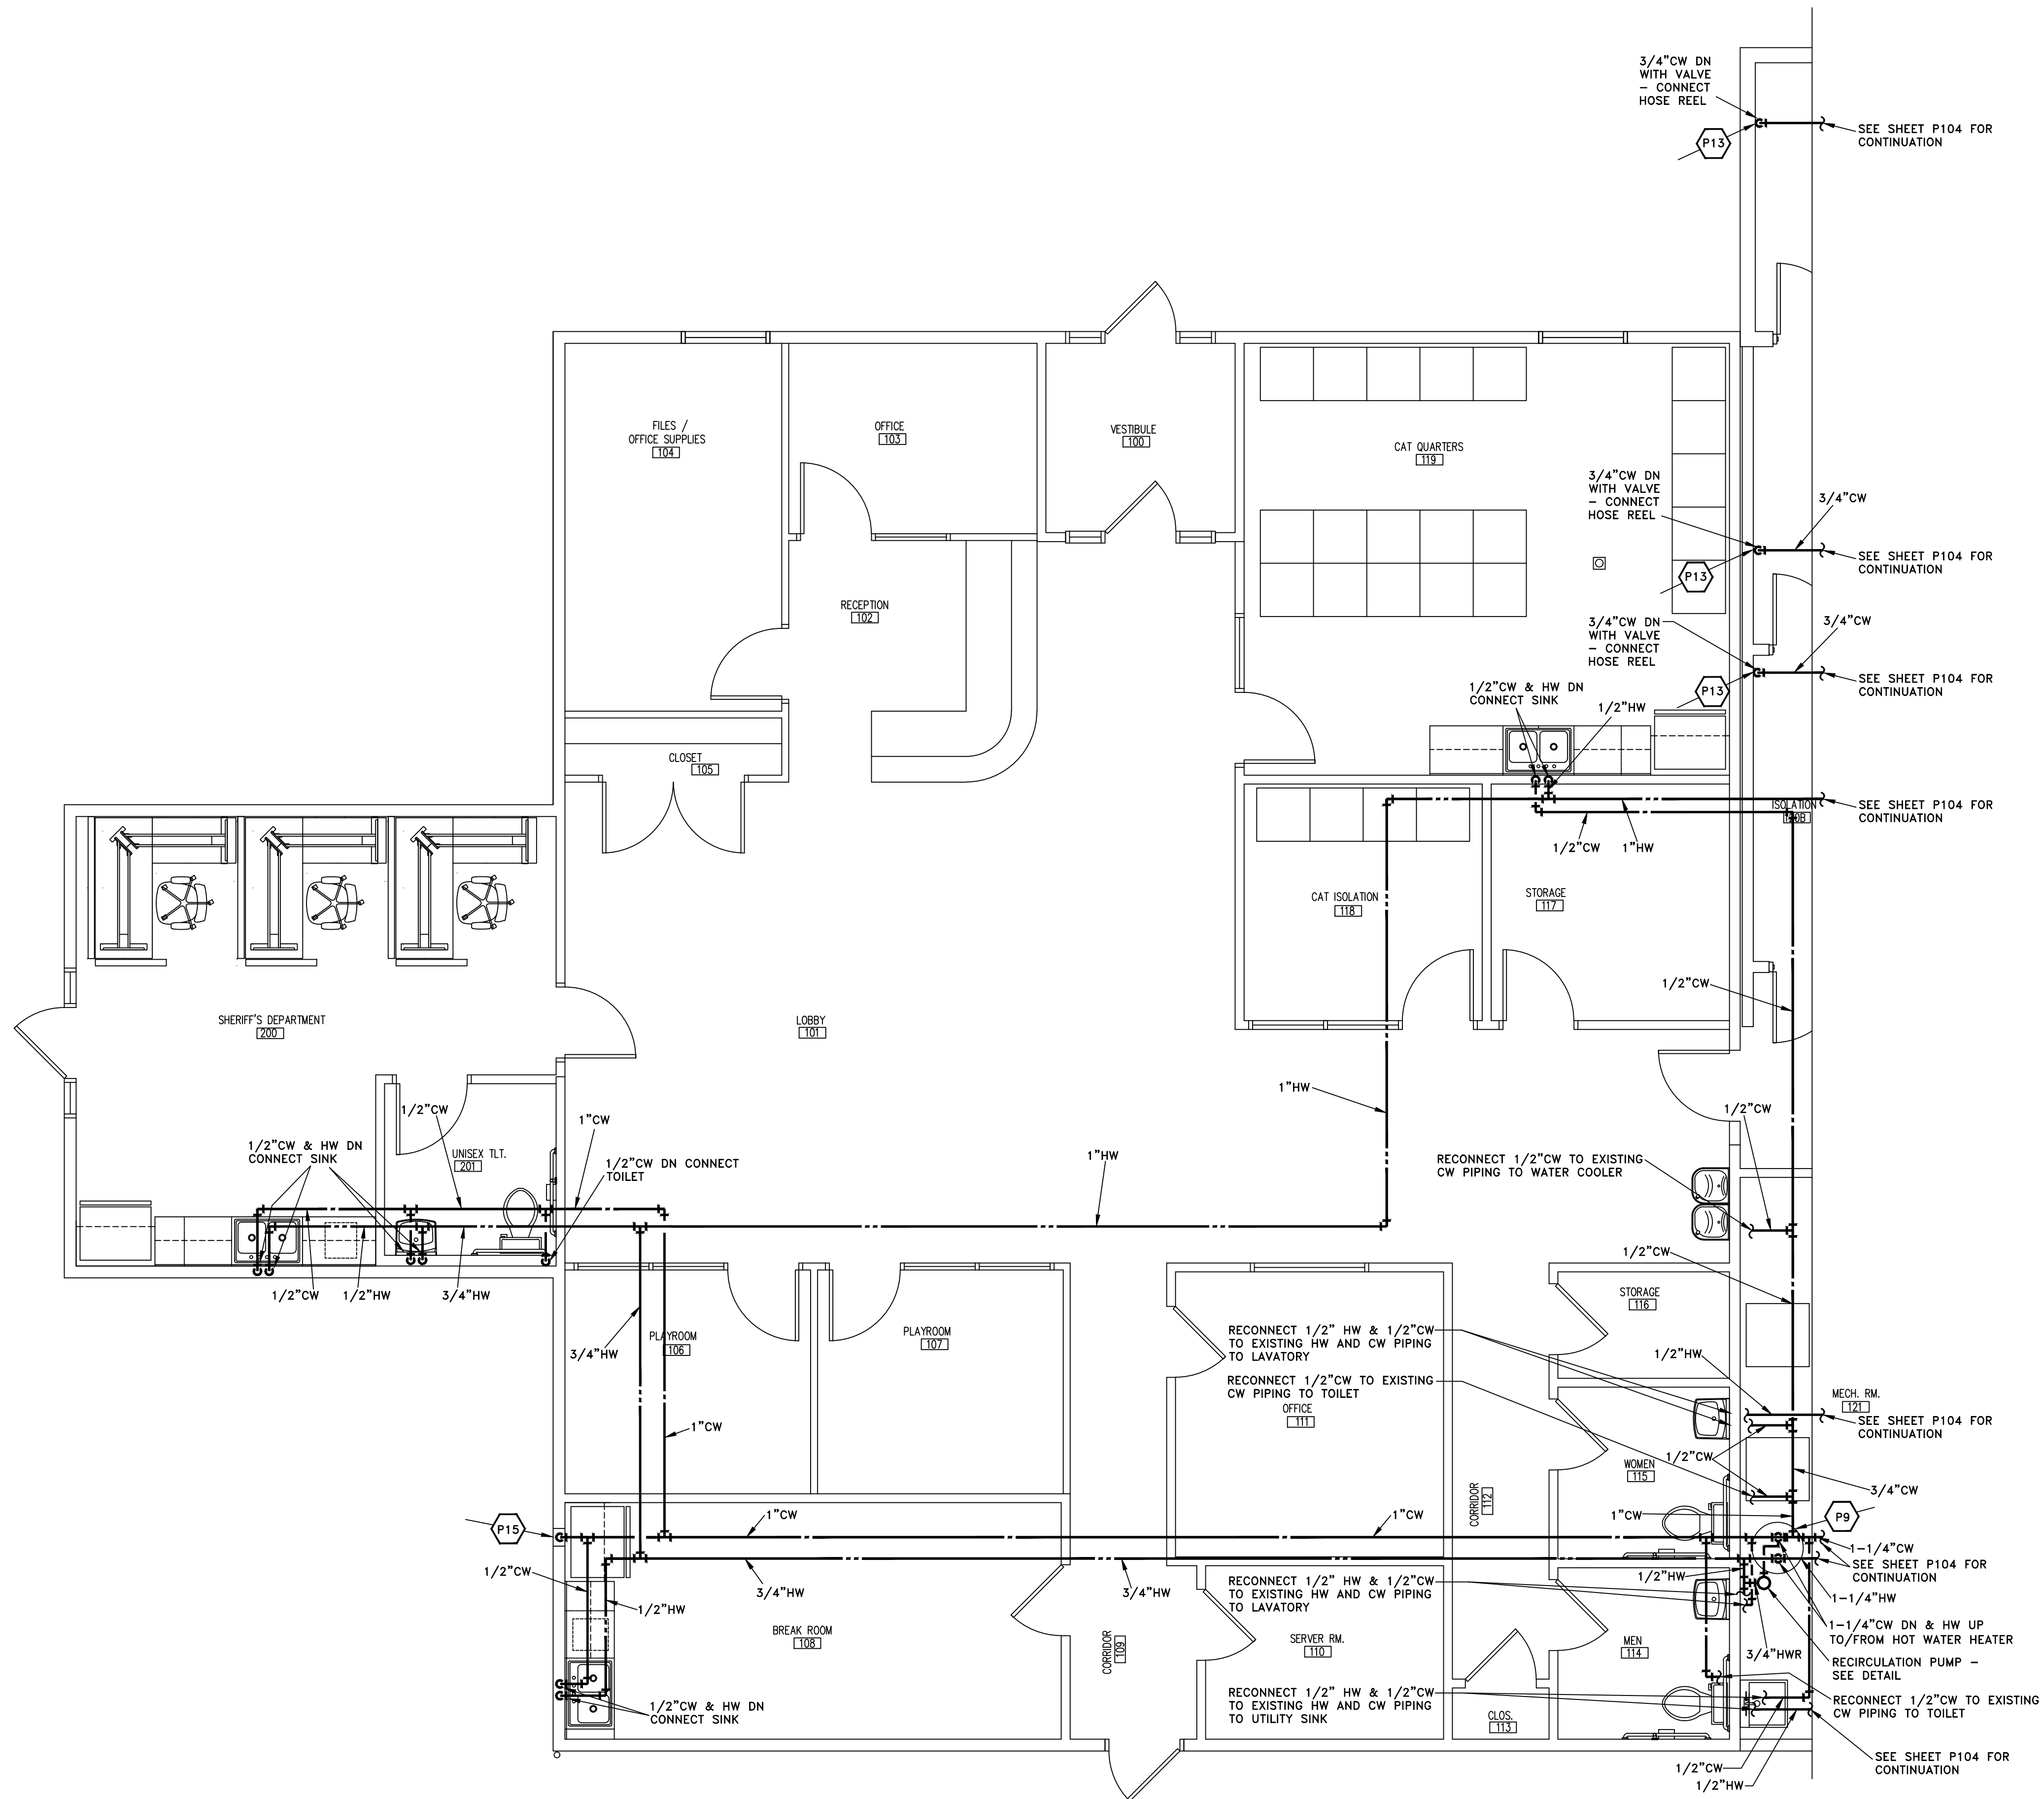SCALE: 1/4" = 1'-0"

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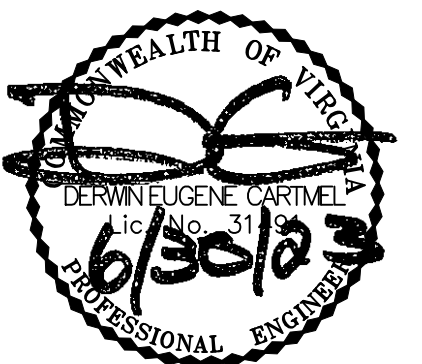
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**BUILDING RENOVATION FOR
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 ANIMAL SHELTER
 15050 LEE HIGHWAY
 BRISTOL, VIRGINIA 24201**

**DOMESTIC WATER PIPING
 FLOOR PLAN**



DATE: 06-30-2023

NO. REVISION DATE

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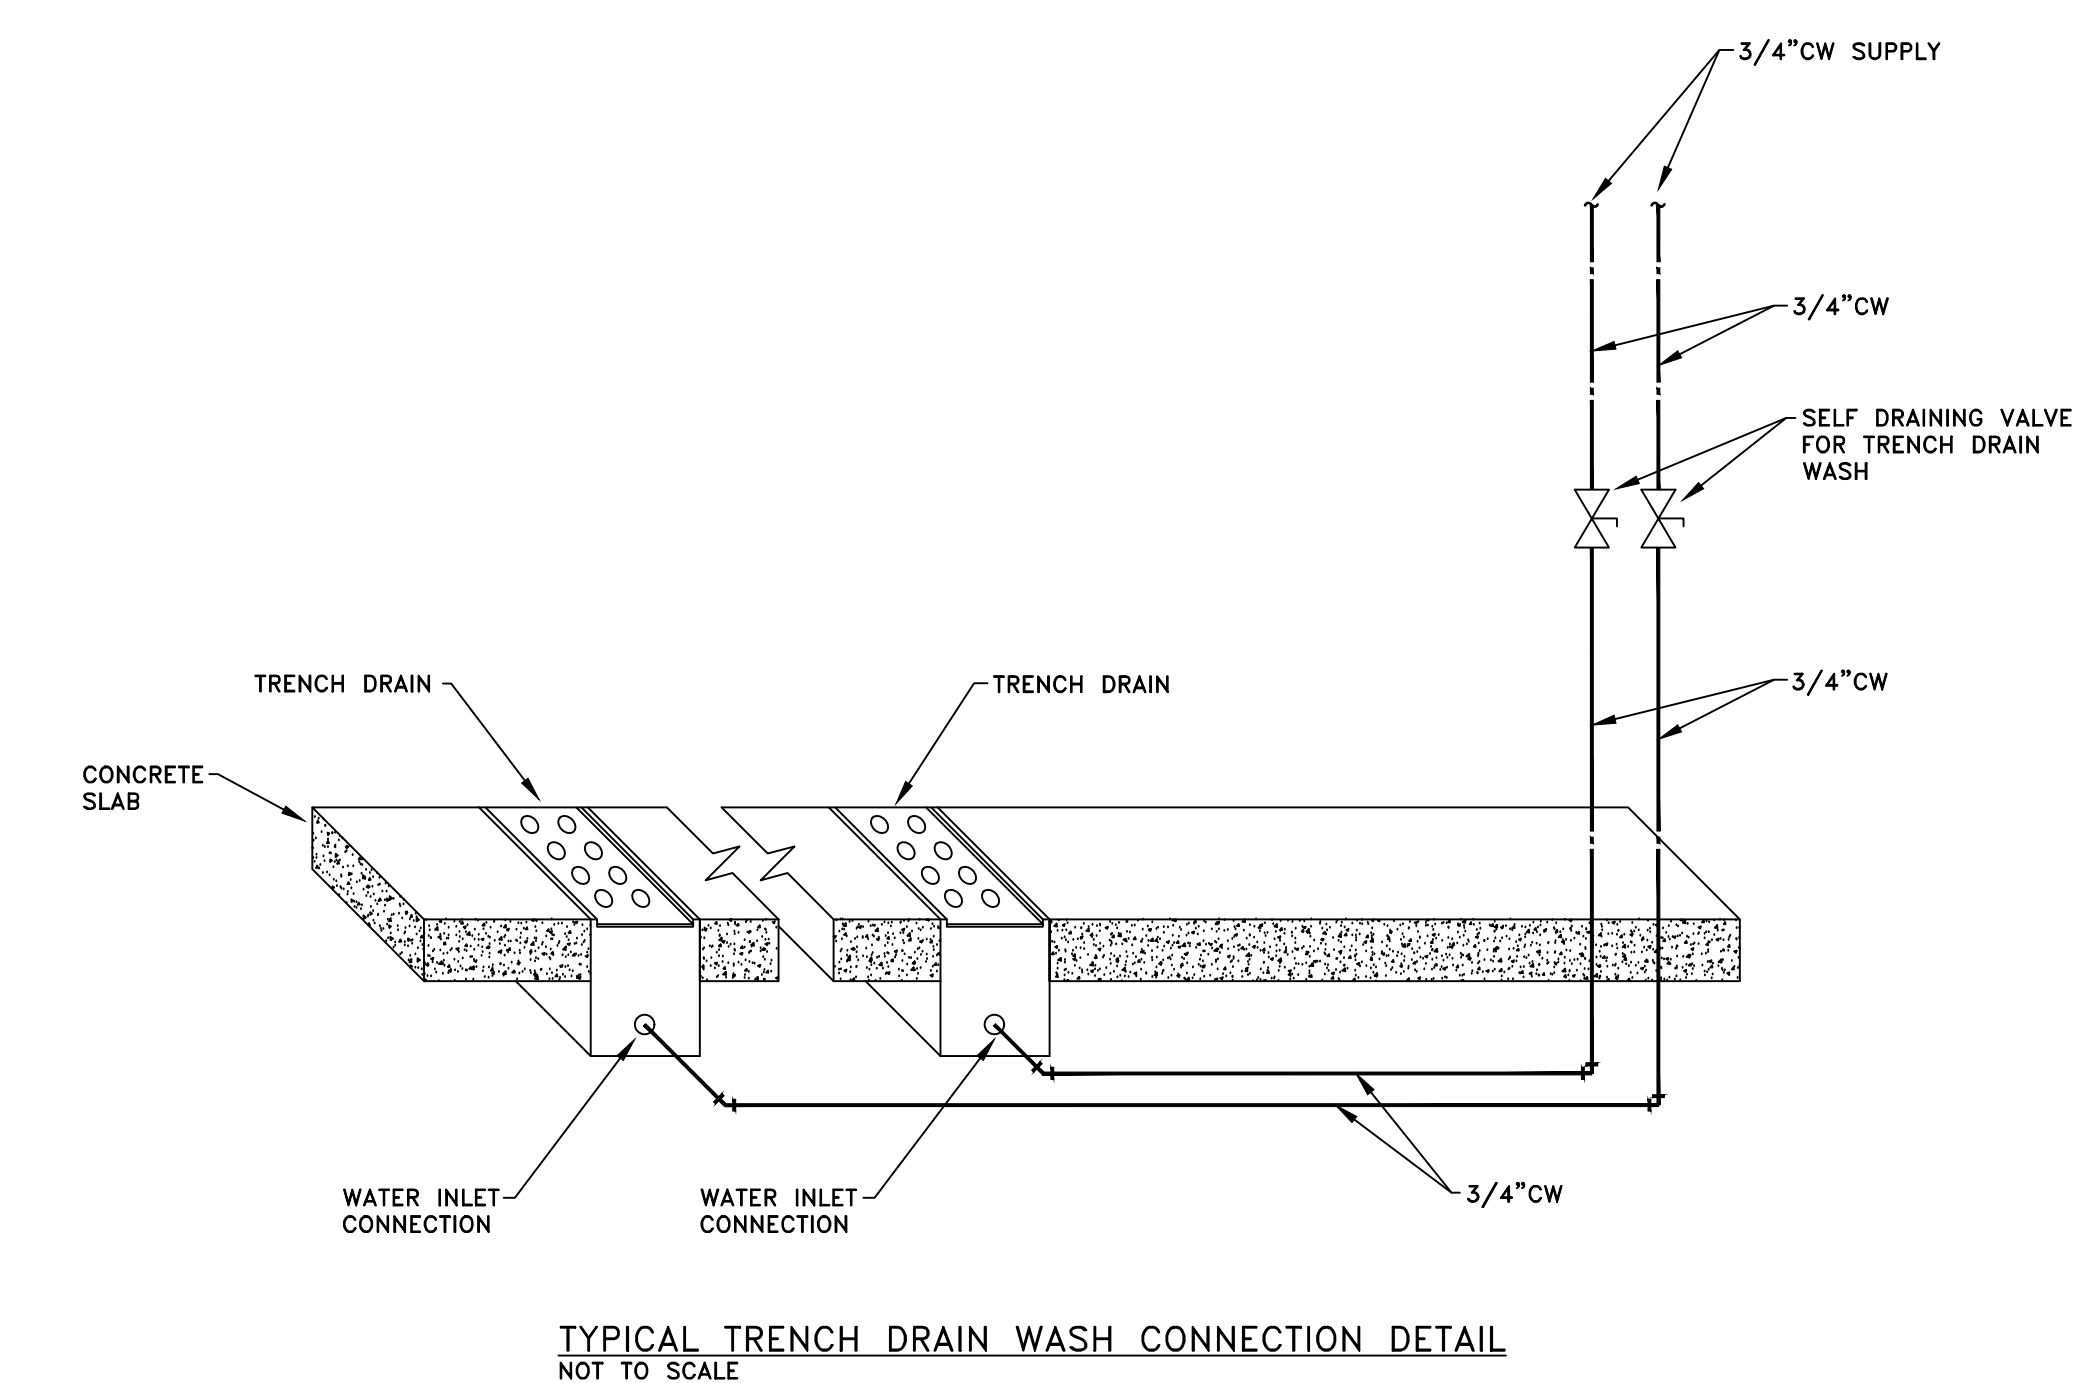
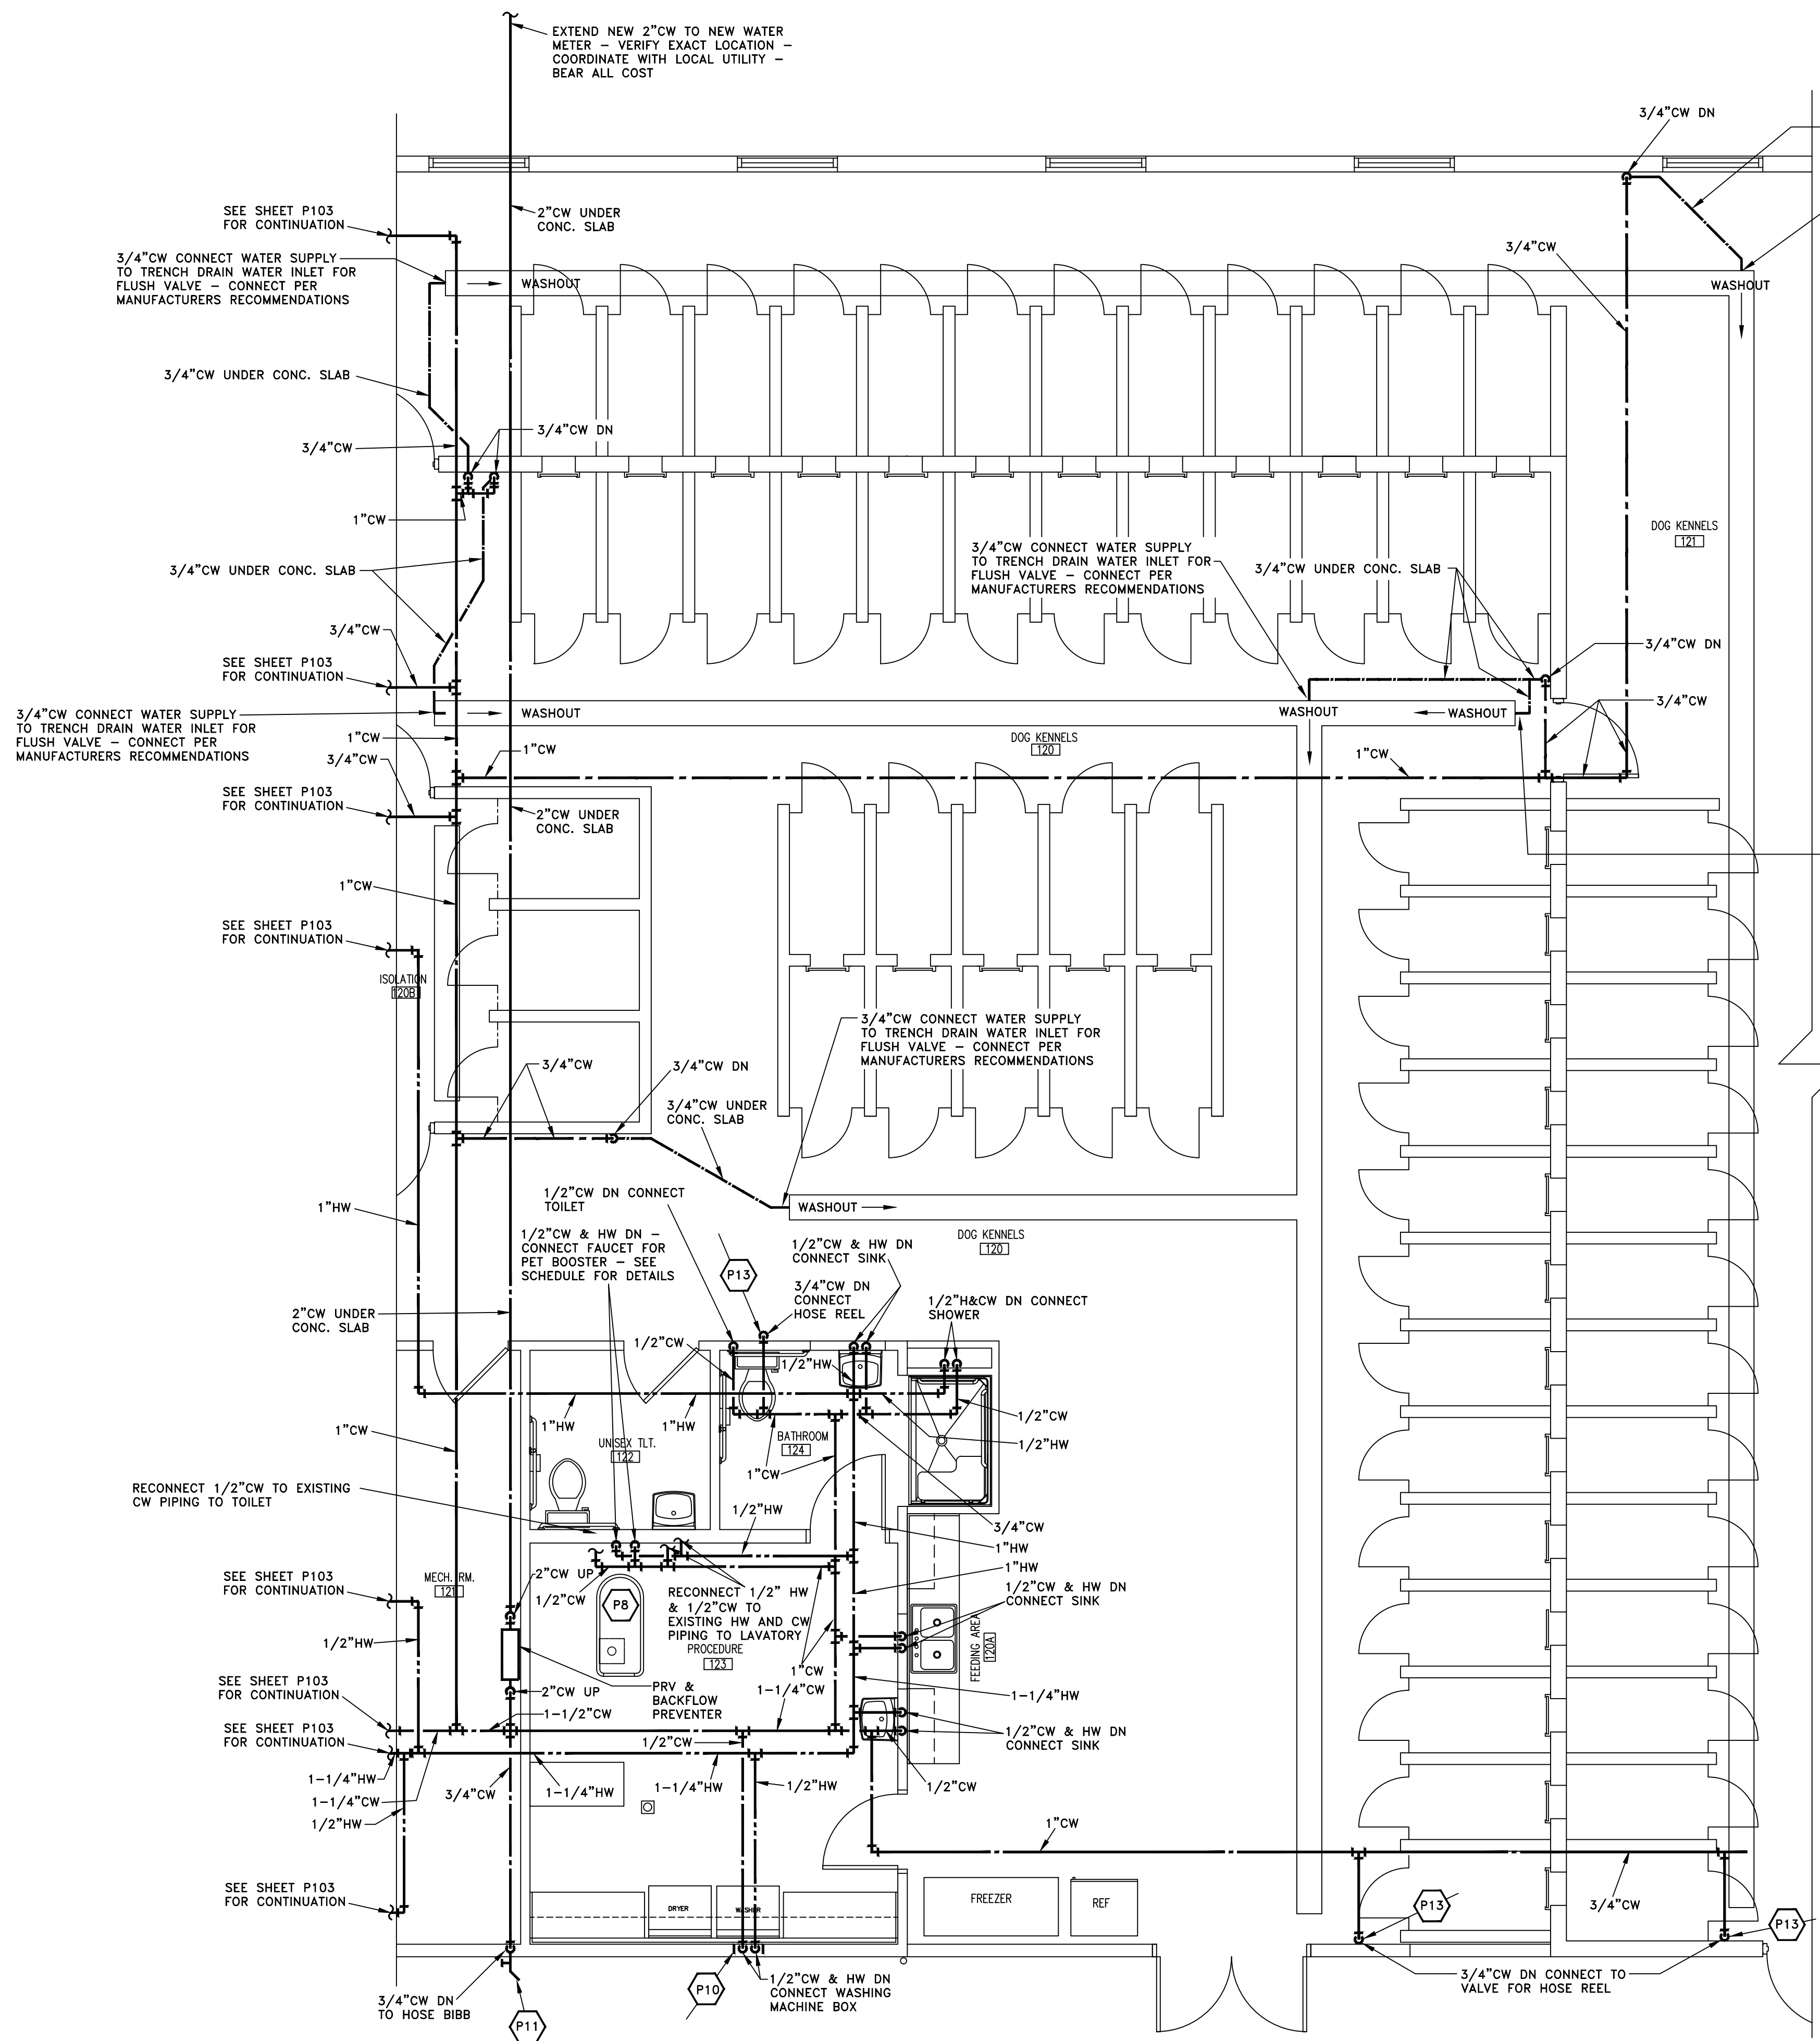
SHEET: **P103**

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PROJECT NO. TLG-22136

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DOMESTIC WATER PIPING FLOOR PLAN

SCALE: 1/4" = 1'-0"

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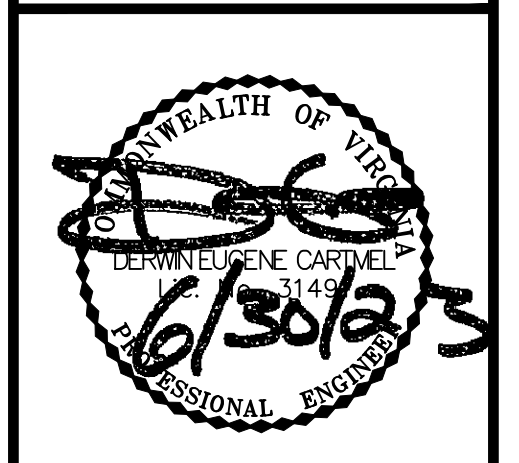
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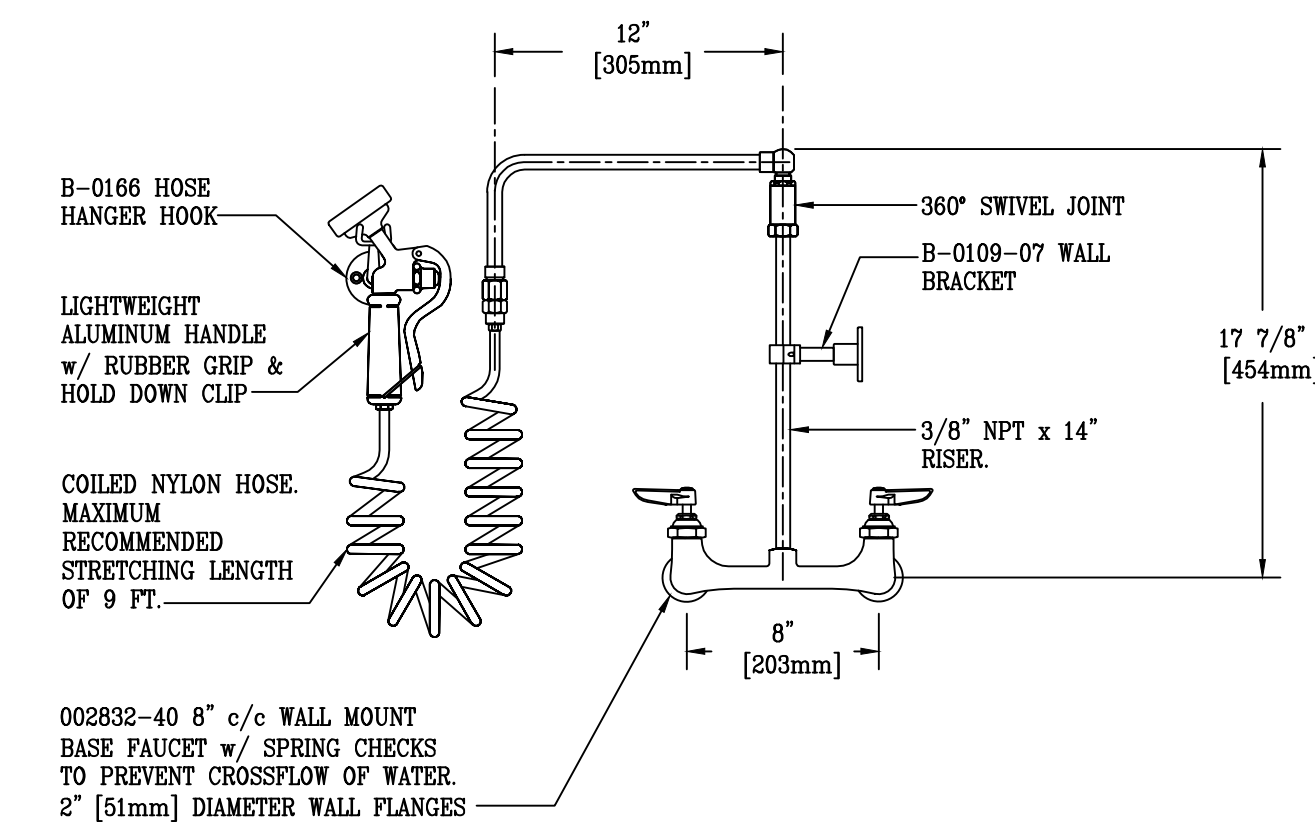
**DOMESTIC WATER PIPING
 FLOOR PLAN**




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THE LANE GROUP INC.	

PLUMBING FIXTURE SCHEDULE

NO.	TYPE	SIZE	REMARKS	MAKE	MODEL
P1	WATER CLOSET HANDICAPPED	16-1/2" H.	EVERCLEAN FLOOR MOUNTED, PRESSURE ASSISTED SIPHON JET, ELONGATED 16-1/2" HIGH TANK TYPE WITH WHITE MOLTEX SEAT WITH OPEN FRONT. CONNECT 1/2" COLD WATER AND 4" SOIL. 1.6 GALLON FLUSH.	AMERICAN STANDARD	2467.016
P2	WALL-HUNG LAVATORY HANDICAPPED	20"x18"	VITREOUS CHINA, WALL-HUNG WITH #7385.043 SINGLE LEVER FAUCET ON 4" CENTERS WITH INTEGRAL GRID DRAIN AND AERATOR FOR 2-1/2 GPM FLOW. CONNECT 1/2" HOT AND COLD WATER, 1-1/4" WASTE. MOUNT 34" ABOVE FINISHED FLOOR. NEATLY INSULATE ALL EXPOSED PIPING WITH FACTORY INSULATION KIT EQUAL TO "LAV-GUARD 2" BY TRUEBRO INC. MODEL #102 E-Z (WHITE). PROVIDE CHAIR CARRIER. PROVIDE AND INSTALL WATTS LFMV THERMOSTATIC MIXING VALVE FOR EACH LAVATORY. INSTALL PER MANUFACTURER'S RECOMMENDATIONS	AMERICAN STANDARD	0355.012
P3	WALL-HUNG LAVATORY	20"x18"	VITREOUS CHINA, WALL-HUNG WITH #7385.043 SINGLE LEVER FAUCET WITH ON 4" CENTERS WITH INTEGRAL GRID DRAIN AND AERATOR FOR 1-1/2 GPM FLOW. CONNECT 1/2" HOT AND COLD WATER, 1-1/4" WASTE. PROVIDE CHAIR CARRIER.	AMERICAN STANDARD	0355.012
P4	DOUBLE COMPARTMENT SINK	33"x19-1/2"	18 GAUGE STAINLESS STEEL, BUILT-IN SELF RIMMING WITH TWO #LK-35 STRAINERS AND ONE #LK-1000 SINGLE LEVER FAUCET WITH AERATOR FOR 3-HOLE INSTALLATION. CONNECT 1/2" HOT AND COLD WATER, 1-1/2" WASTE.	ELKAY	LR3722
P5	SHOWER UNIT AND SHOWER TRIM (A.D.A.)	60"x36"	ADA ROLL-IN SHOWER, 7/8" BARRIER FREE THRESHOLD, SELF-SUPPORTING AND PRE-LEVELLED SHOWER BASE, FULLY REINFORCED WALLS, TILE PATTERN EASY TO CLEAN APPLIED ACRYLIC, TEXTURED SLIP-RESISTANT FLOOR, CENTER DRAIN, 30 YEAR WARRANTY. SYMMONS ALLURA SHOWER/HAND SHOWER TRIM UNIT, LEVER HANDLE FOR INTEGRAL VOLUME CONTROL, INTEGRAL STOPS, EXTERNAL ADJUSTABLE VOLUME CONTROL HEAD, 2 GPM FLOW RESTRICTOR, SAFETY-MIX PRESSURE BALANCING VALVE, AND TEMPERATURE LIMITING STOPS SET AT 115°F. CONNECT 1/2" HOT AND COLD WATER. SQUARE FLOOR DRAIN TO BE ZURN MODEL ZN415S. CONNECT 2"W, SHOWER HEAD HEIGHT AS DIRECTED.	FREEDOM SHOWER BASE SYMMONS SHOWER SYSTEM TRIM	APF06437BF875 4705TRMTC
P6	FLOOR DRAIN		FLOOR DRAIN DURA-COATED CAST IRON BODY WITH BOTTOM OUTLET, COMBINATION INVERTIBLE MEMBRANE CLAMP AND ADJUSTABLE COLLAR WITH TYPE "B" POLISHED NICKEL BRONZE STRAINER.	ZURN	ZB-415
P7	SANI-FLOOR RECEPTOR (FLOOR SINK)	12"x12"	CAST IRON, WHITE ACID-RESISTING ENAMEL BODY INTERIOR, NICKEL-BRONZE FRAME, ALUMINUM ANTI-SPLASH INTERIOR DOME STRAINER. CONNECT 2" WASTE.	ZURN	ZN-1902-33
P8	PET BOOSTER TUB		OWNER PROVIDED TUB - PROVIDE AND INSTALL T&S BRASS AND BRONZE WORKS, INC. PET GROOMING STATION 8" WALL MOUNT BASE FAUCET - SEE DETAIL THIS SHEET	-	-
P9	ELECTRIC WATER HEATER	80 GAL.	FOAM INSULATED WITH 6 YEAR GUARANTEE, FACTORY INSTALLED AUTOMATIC RESETTING RELIEF VALVE WITH WASTE TO DRAIN, DIELECTRIC UNIONS GATE VALVES ON EACH WATER CONNECTION AND DRAIN VALVE. SEE DETAIL FOR INSTALLATION. MAKE 1-1/4" WATER CONNECTIONS. UNIT FOR 3 PHASE, 208 VOLTS, 36 KW	STATE	CSB 82 36 IFE
P10	WASHING MACHINE BOX		PLASTIC UNIVERSAL WASHING MACHINE BOX, HIGH IMPACT PLASTIC WASHING MACHINE OUTLET BOX, WITH BRASS VALVE BY MFG. AND KNOCK OUT WASTE.	IPS	W4700
P11	WALL HYDRANT		AUTOMATIC DRAINING, FREEZELESS WALL HYDRANT. CONNECT 3/4" COLD WATER. MOUNT 24" ABOVE FINISHED GRADE.	WOODFORD	19
P12			NOT USED	-	-
P13	HOSE REEL		SPRING RETRACTABLE COMPOSITE HOSE REEL, 50' 5/8" WATER HOSE, LIGHTWEIGHT COMPOSITE MEDIUM MATERIAL - WALL, CEILING OR FLOOR MOUNT - MOUNT AS DIRECTED BY OWNER/ARCHITECT	REELCRAFT	SWA3850-OLP
P14	TRENCH DRAIN		6-1/4"WIDE, 4" THROAT, DURACOAT CAST IRON TRENCH DRAIN - WITH BOTTOM DOME STRAINER - 3" DRAIN - SLOPE 1/8" PER FT - PROVIDE STAINLESS STEEL COVER	ZURN	Z886
P15	ICE MAKER CONNECTION BOX		ICE MAKER CONNECTION BOX WITH COVER, HIGH IMPACT PLASTIC. BOTTOM SUPPLY. FURNISHED WITH 1/2" FIP INLET ANGLE VALVE.	IPS	87967



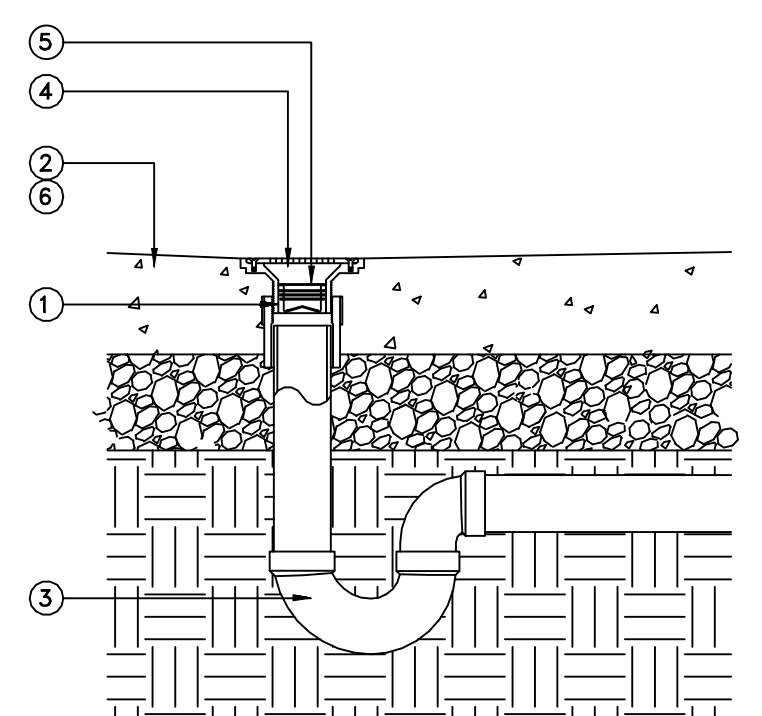
PET GROOMING STATION WALL MOUNT BASE FAUCET DETAIL
NO SCALE



FLOOR DRAIN with WATERLESS TRAP DETAIL
NO SCALE

NUMBERED NOTES

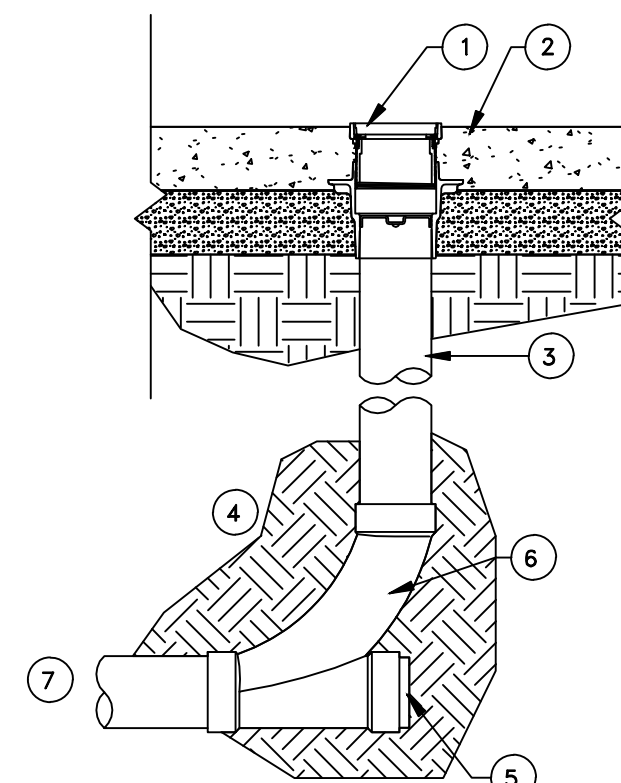
- ADJUSTABLE FLOOR DRAIN ASSEMBLY, SEE SCHEDULE, COORDINATE ELEVATION WITH STRUCTURAL AND ARCHITECTURAL, COORDINATE FLOOR FINISH
- CONCRETE FLOOR
- PVC P-TRAP
- BRASS COVER AND RING
- WATERLESS TRAP SEAL
- FLOOR SLOPE- COORDINATE



NUMBERED NOTES

- ADJUSTABLE FLOOR CLEAN OUT w/ ANCHOR FLANGE, MATCH PIPE SIZE SERVED. INSTALL FLUSH w/ FINISH FLOOR. COORDINATE
- FLOOR SYSTEM - COORDINATE w/ STRUCTURAL AND ARCHITECTURAL
- RISER
- COMPACTED BACKFILL
- IF LINE DEAD ENDS, INSTALL WATERTIGHT PLUG
- COMFINATION WYE 1/8 BEND, ONE PIECE
- SEWER PIPE

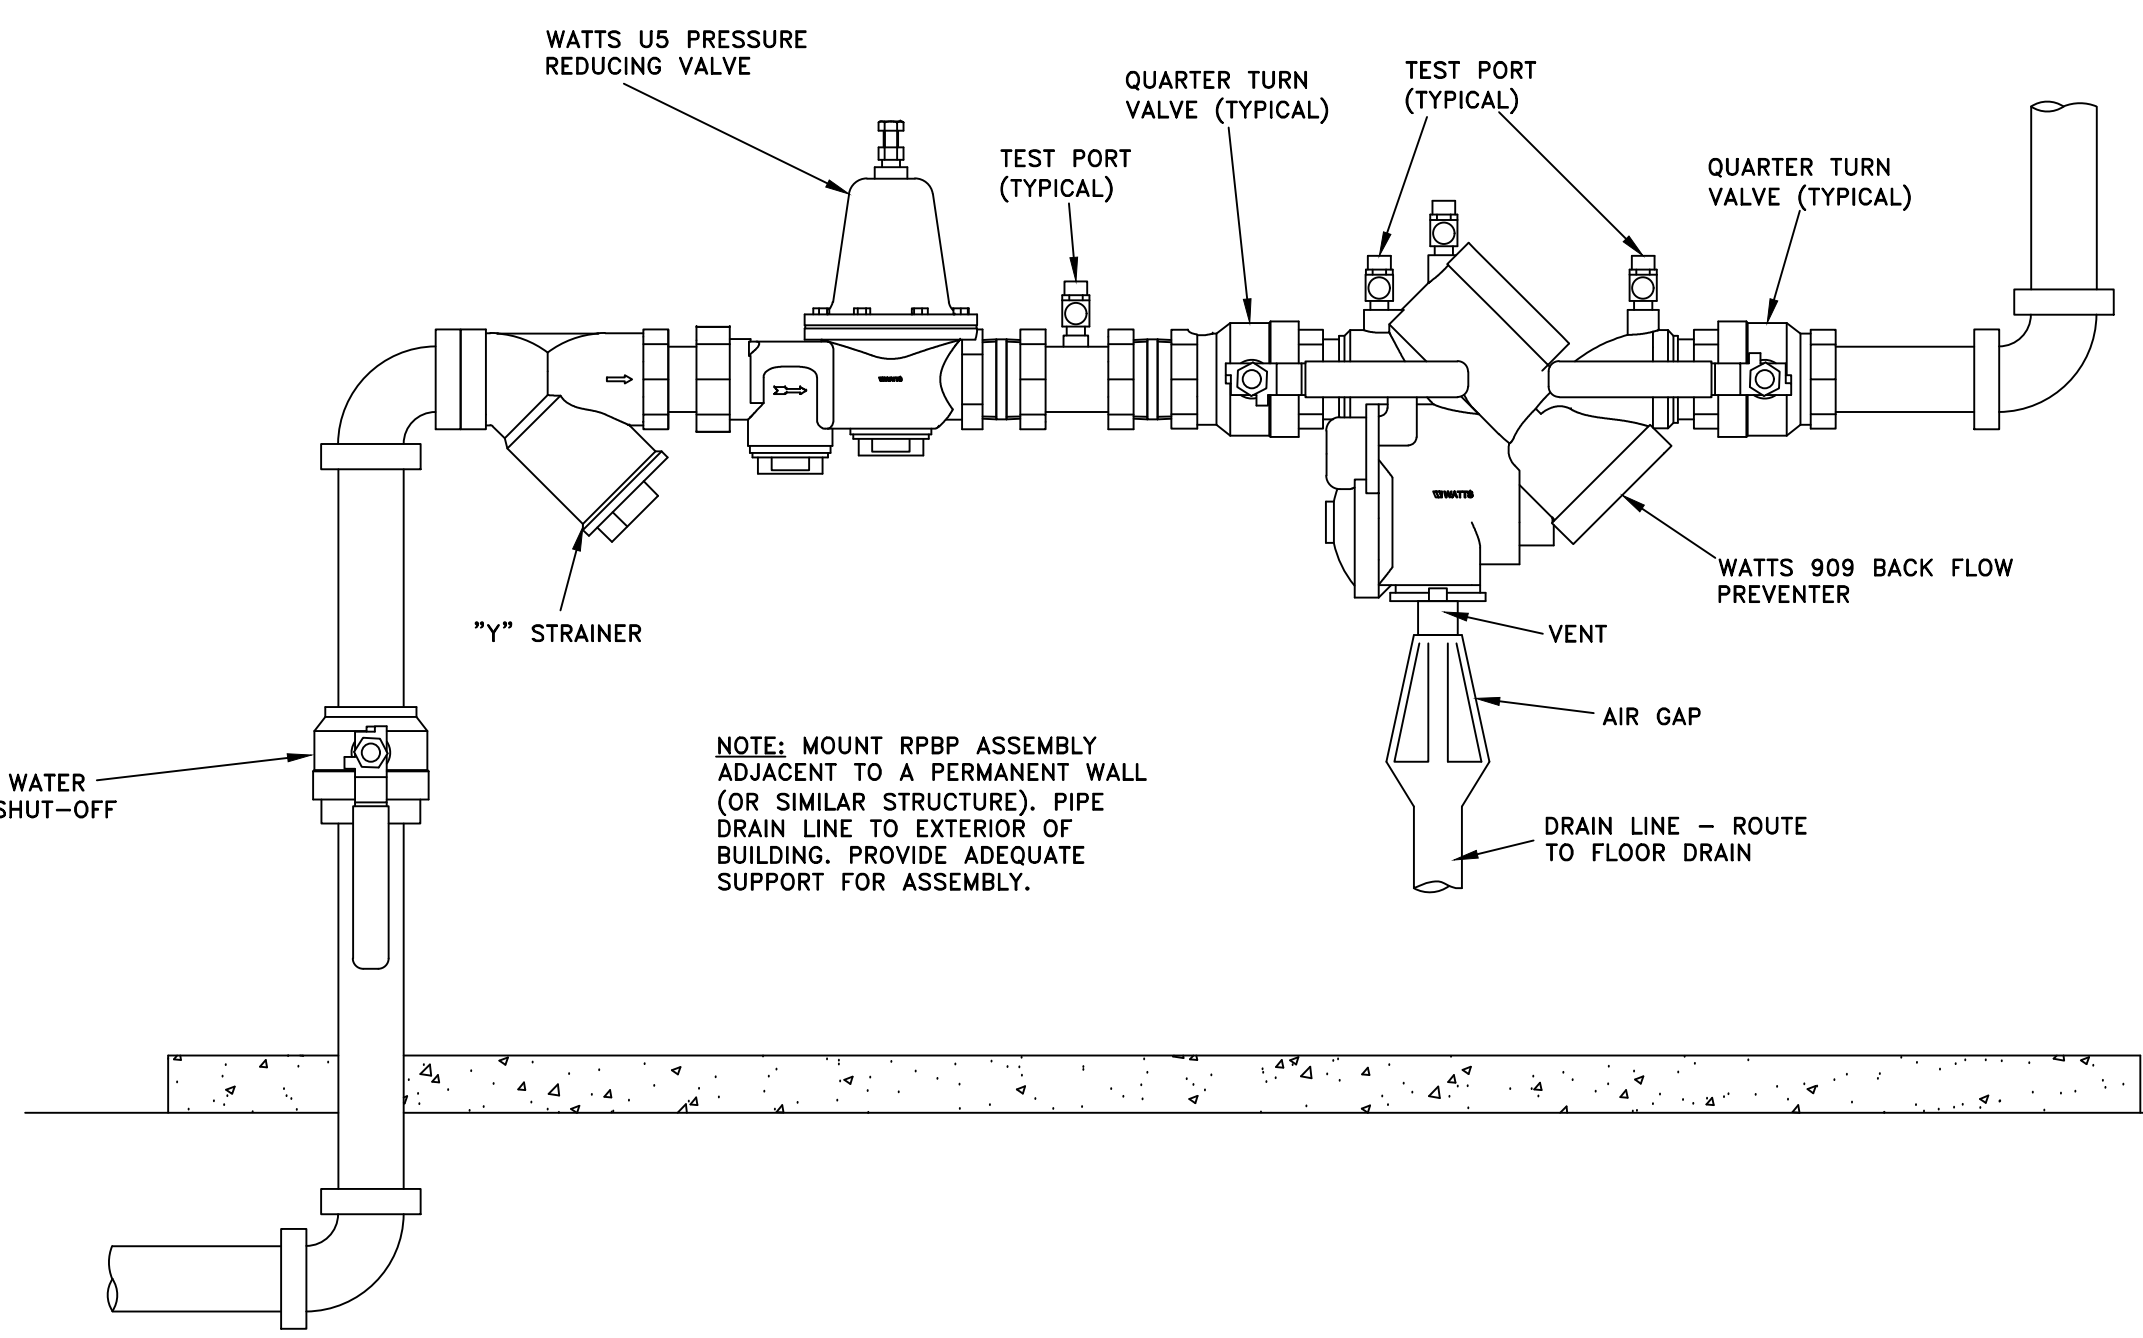FLOOR CLEANOUT DETAIL
NO SCALE



PRESSURE REDUCER AND BACKFLOW PREVENTER DETAIL
NO SCALE

PLUMBING LEGEND

- CW COLD WATER SUPPLY PIPING
- HW HOT WATER SUPPLY PIPING
- HWR HOT WATER RETURN PIPING
- S&W SANITARY SOIL & WASTE PIPING
- V SANITARY VENT PIPING
- GATE OR BALL VALVE
- FD FLOOR DRAIN WITH P-TRAP AND WATERLESS TRAP PRIMER
- FCO FLUSH CLEANOUT
- VTR VENT THRU ROOF
- P1 PLUMBING FIXTURES - SEE PLUMBING FIXTURE SCHEDULE
- PIPE ELBOW AND TEE IN PLANE
- PIPE ELBOW AND TEE TURNED DOWN
- PIPE ELBOW AND TEE TURNED UP

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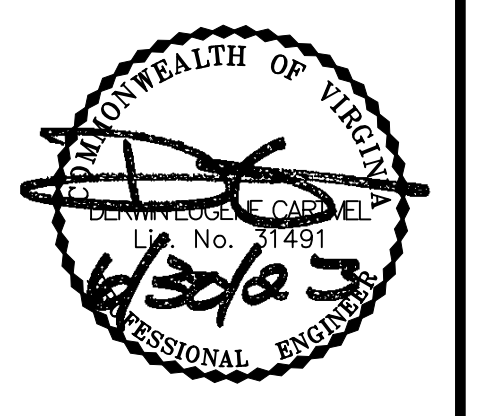
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PLOT DATE: 06/30/2023 HE PROJECT #23-008

the **LANE GROUP**
 engineering architecture environmental
 310 Valley Street NW
 Abingdon, VA 24210
 276.206.8571 - office
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 www.thelanegrp.com

BUILDING RENOVATION FOR
 WASHINGTON COUNTY, VIRGINIA
 ANIMAL SHELTER
 15050 LEE HIGHWAY
 BRISTOL, VIRGINIA 24201

PLUMBING DETAILS

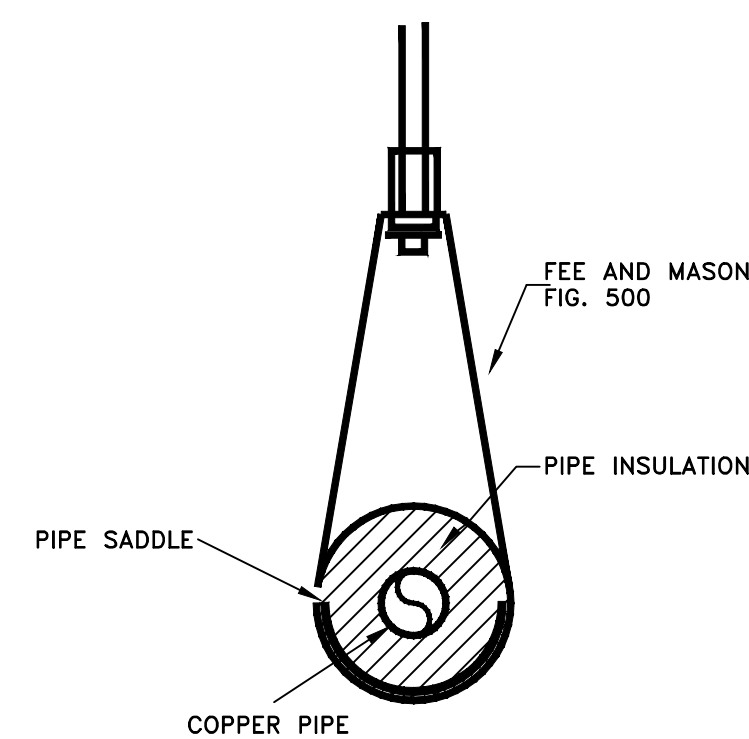


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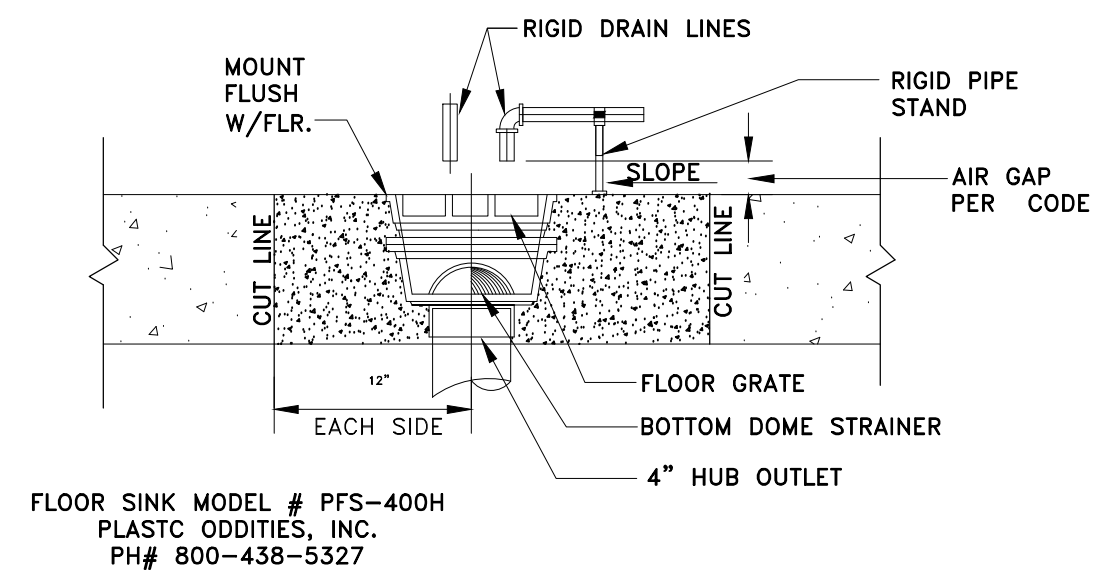
SHEET: **P105**

DRAWN BY: JAP CHECKED BY: DEC
 PROJECT NO: TLG-22136

THE LANE GROUP INC.

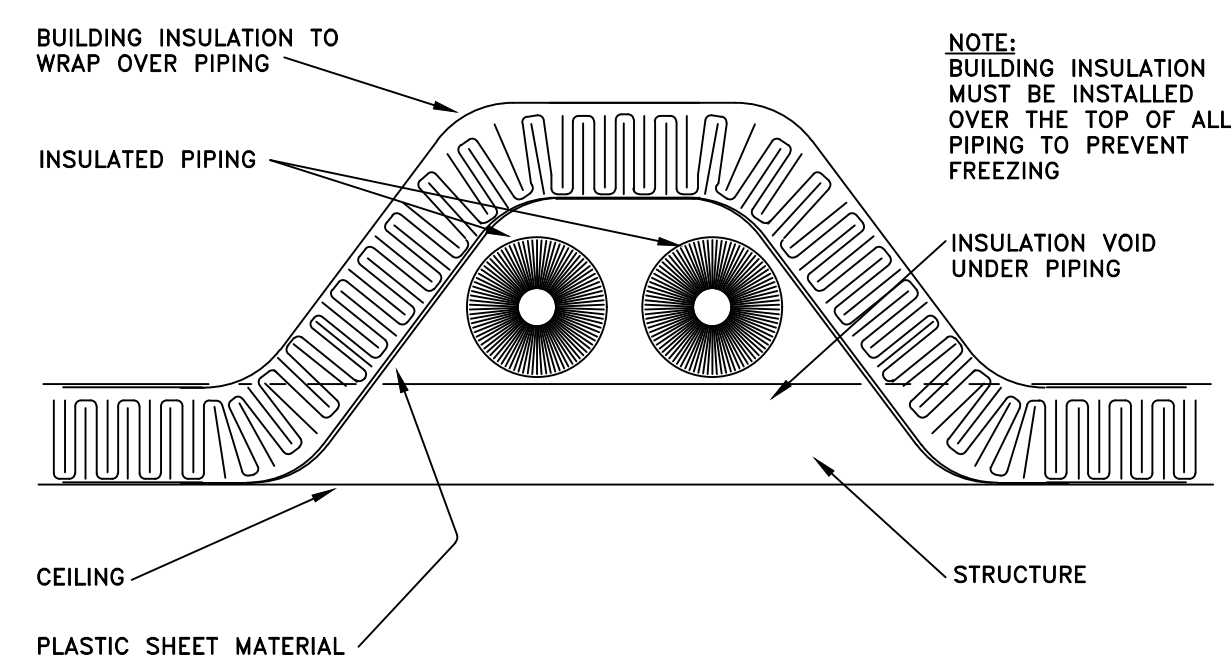


PIPE SUPPORT DETAIL
NO SCALE




FLOOR SINK MODEL # PFS-400H
PLASTIC ODDITIES, INC.
PH# 800-438-5327

FLUSH MOUNTED FLOOR SINK DETAIL
NO SCALE




NOTE:
BUILDING INSULATION
MUST BE INSTALLED
OVER THE TOP OF ALL
PIPING TO PREVENT
FREEZING

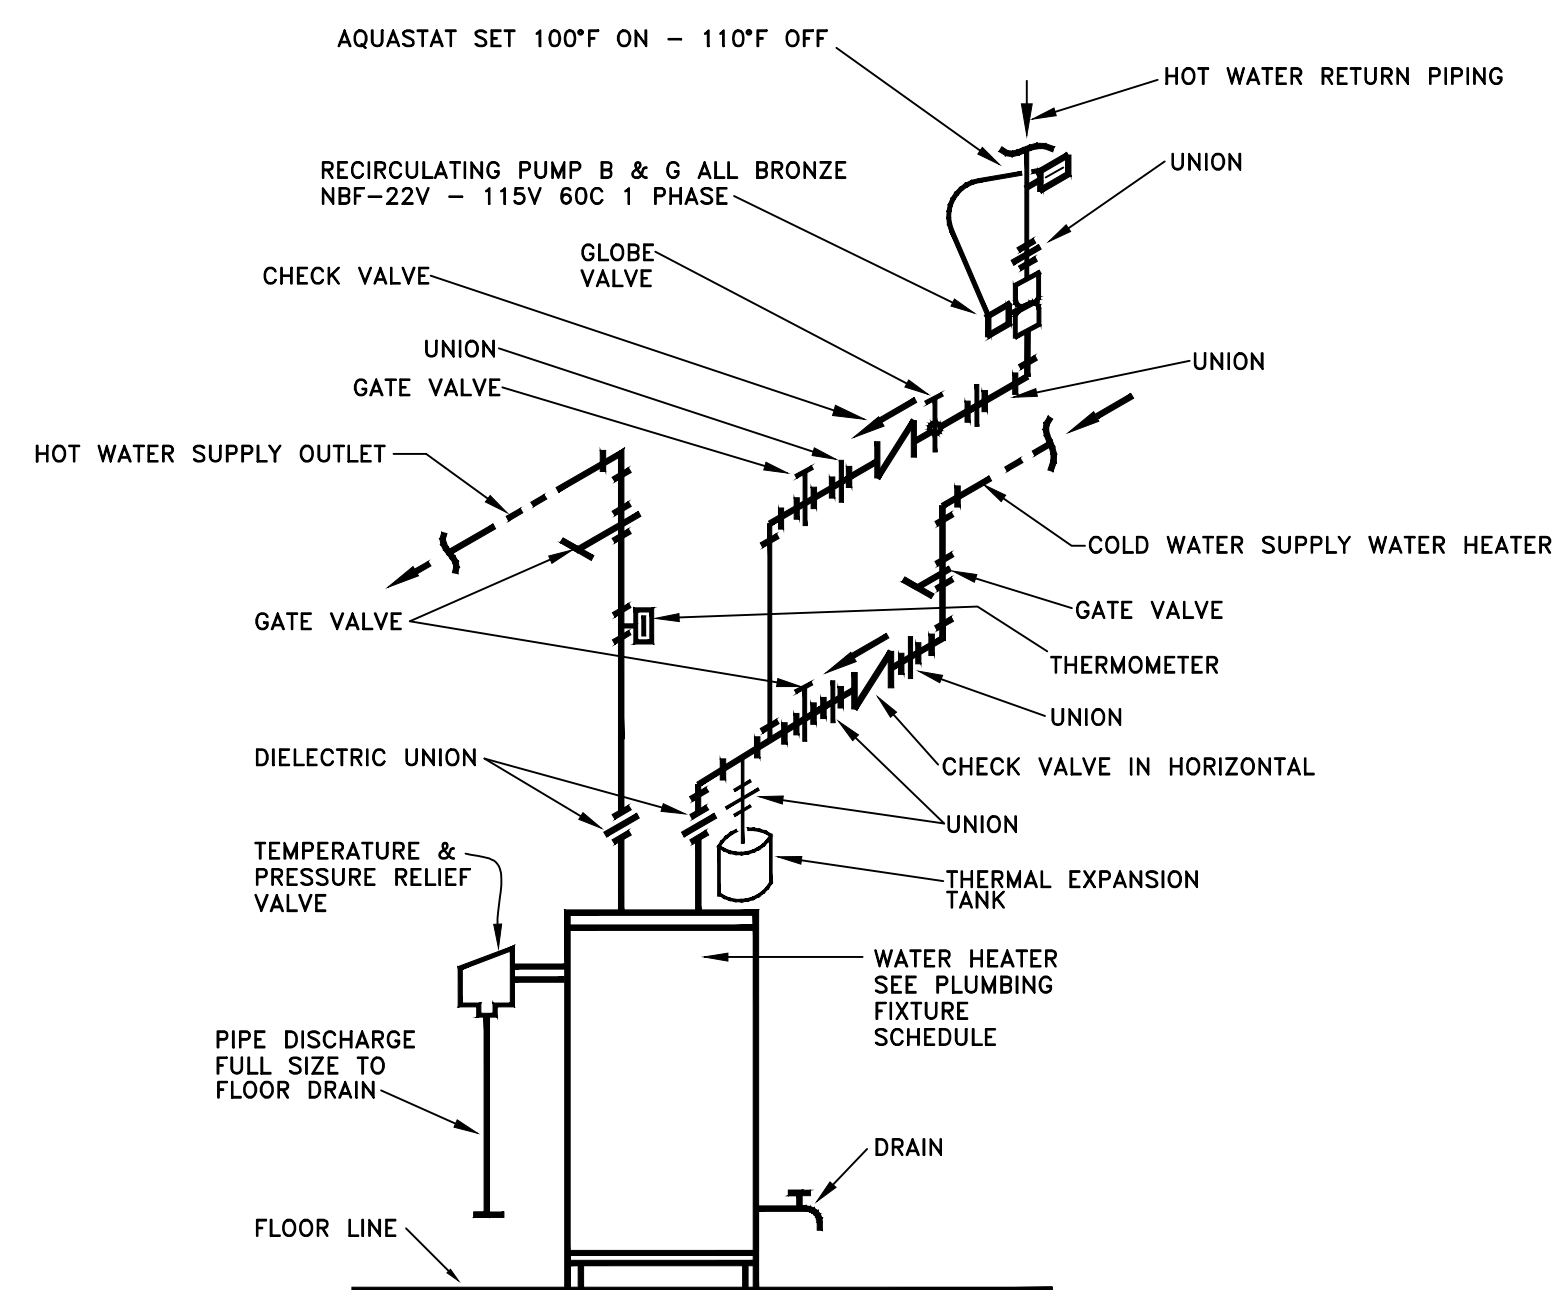DOMESTIC HOT & COLD WATER
LINES IN ATTIC DETAIL
NO SCALE



NOTE: SEE FLOOR PLANS FOR PIPE SIZES.

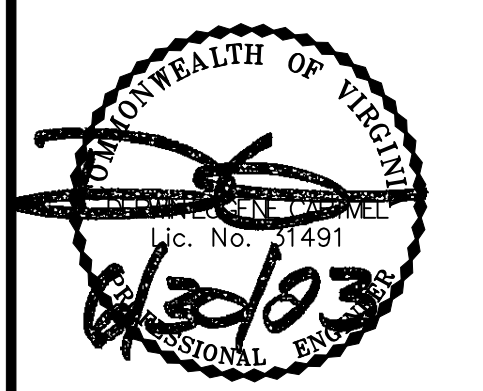TYPICAL WATER HEATER DETAIL
NO SCALE



DATE:	06-30-2023
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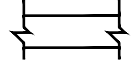
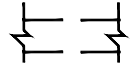
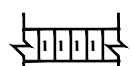
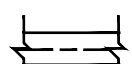
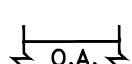
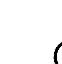
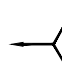
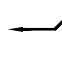
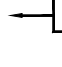
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DRAWN BY:	JAP
CHECKED BY:	DEC
PROJECT NO.	TLG-22136
THE LANE GROUP INC.	


HE HOLSTON ENGINEERING, INC.
301 MONTGOMERY ST., SUITE #4, JOHNSON CITY, TN 37604 (423)926-5991 holston.engineering@holsteng.com

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H.V.A.C. LEGEND

-  SUPPLY DUCTWORK WITH 2" EXTERNAL INSULATION
-  RETURN DUCTWORK WITH 2" EXTERNAL INSULATION
-  FLEXIBLE DUCTWORK EQUAL TO GENFLEX 1L-1
-  ROUND DUCTWORK WITH 2" EXTERNAL INSULATION
-  OUTSIDE AIR DUCTWORK WITH 2" EXTERNAL INSULATION
-  ROOM THERMOSTAT - SEE CONTROL SPECIFICATION
-  H.V.A.C. UNIT - SEE SCHEDULE AND DETAILS
-  AIR DISTRIBUTION OUTLET - SEE SCHEDULE
-  EXHAUST FAN - SEE SCHEDULE AND DETAIL
- S.F. SPIN-IN FITTING WITH AIR SCOOP
- B.D. BALANCING DAMPER - SEE DETAIL



H.V.A.C. EQUIPMENT SCHEDULE		
UNIT DESIGNATION	①	②
TYPE INDOOR UNIT	GAS FURNACE/ELECTRIC COOLING SPLIT SYSTEM	GAS FURNACE/ELECTRIC COOLING SPLIT SYSTEM
MANUFACTURER	CARRIER	CARRIER
GAS FURNACE MODEL #	58SC0A045E171*12	58SC0A090E21*20
TOTAL AIR FLOW	955	1685
EXTERNAL STATIC PRESSURE IN H2O AFTER WET COIL	.50"	.50"
TOTAL BTUH - IN	44,000	88,000
TOTAL BTUH - OUT	35,000	72,000
BREAKER SIZE	15 A	20 A
FAN HP	1/2	1
ELEC. CHARACTER	115 V/1Ø	115 V/1Ø
COOLING COIL	CAMPF3717AL	CAMPMP6121AL
OUTDOOR UNIT MODEL #	24SCA536W003	24SCA56W003
TOTAL COOLING CAPACITY BTUH	34,200	57,430
SENSIBLE COOLING CAPACITY BTUH	23,630	46,740
SYSTEM KW	2.92	5.17
S.E.E.R. 2	14.3	14.3
VOLTAGE	208/230V/1Ø	208/230V/1Ø
M.C.A.	16.7 A	33.4 A
BREAKER SIZE	25 A	50 A
OUTSIDE AIR	210 CFM	430 CFM

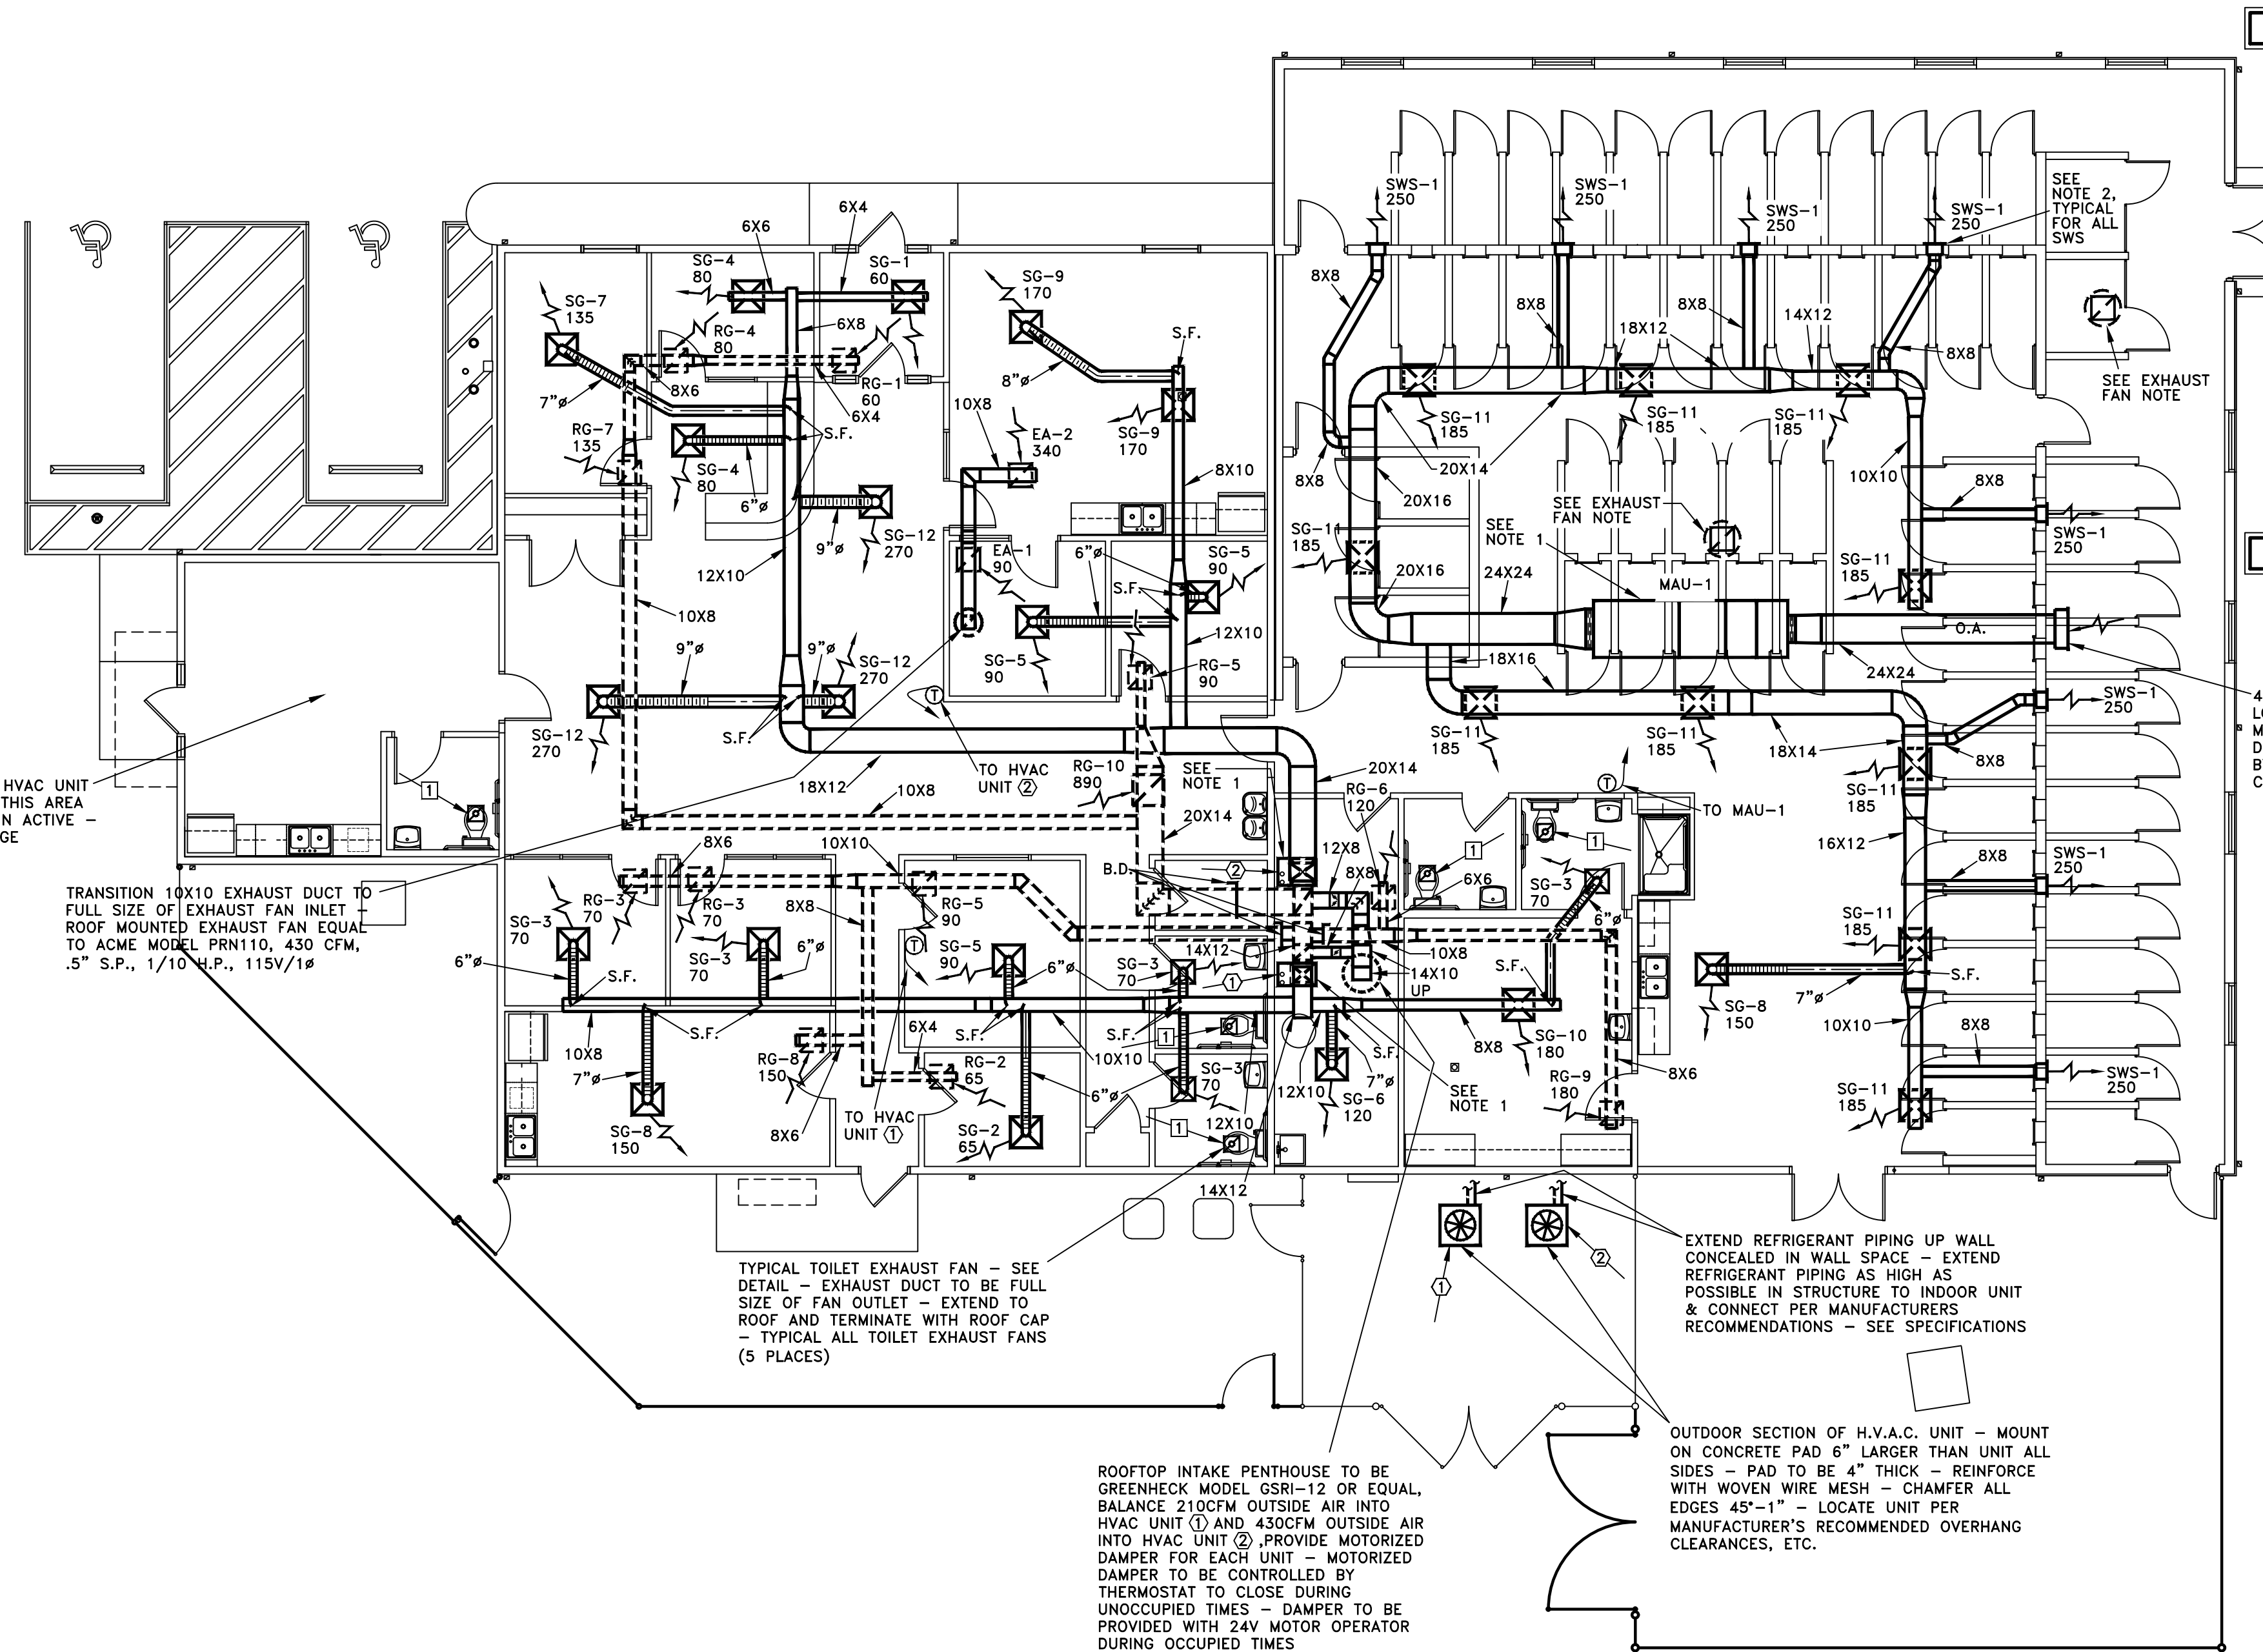MAKE-UP AIR UNIT EQUIPMENT SCHEDULE	
UNIT DESIGNATION	MAU-1
TYPE INDOOR UNIT	MAKE-UP AIR UNIT - HEATING & VENTILATION ONLY
MANUFACTURER	GREENHECK
MODEL #	IGX-P116-H22-MF-N
SUPPLY CFM	4000
EXTERNAL STATIC PRESSURE IN H2O AFTER WET COIL	.75"
MOTOR HP	2
FUEL TYPE	NATURAL GAS
BTUH INPUT	500,000
BTUH OUTPUT	400,000
TEMP RISE MIN °F	3.5
TEMP RISE MAX °F	92.6
ELEC. CHARACTER	208V/60/3Ø
MCA	11.8 A
MOCP	15 A
OUTDOOR AIR	4000 CFM

MECHANICAL FLOOR PLAN

SCALE: 1/8" = 1'-0"

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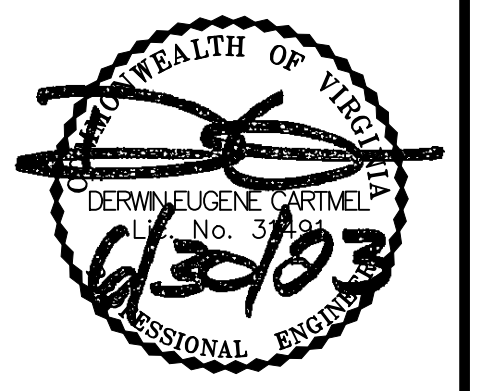
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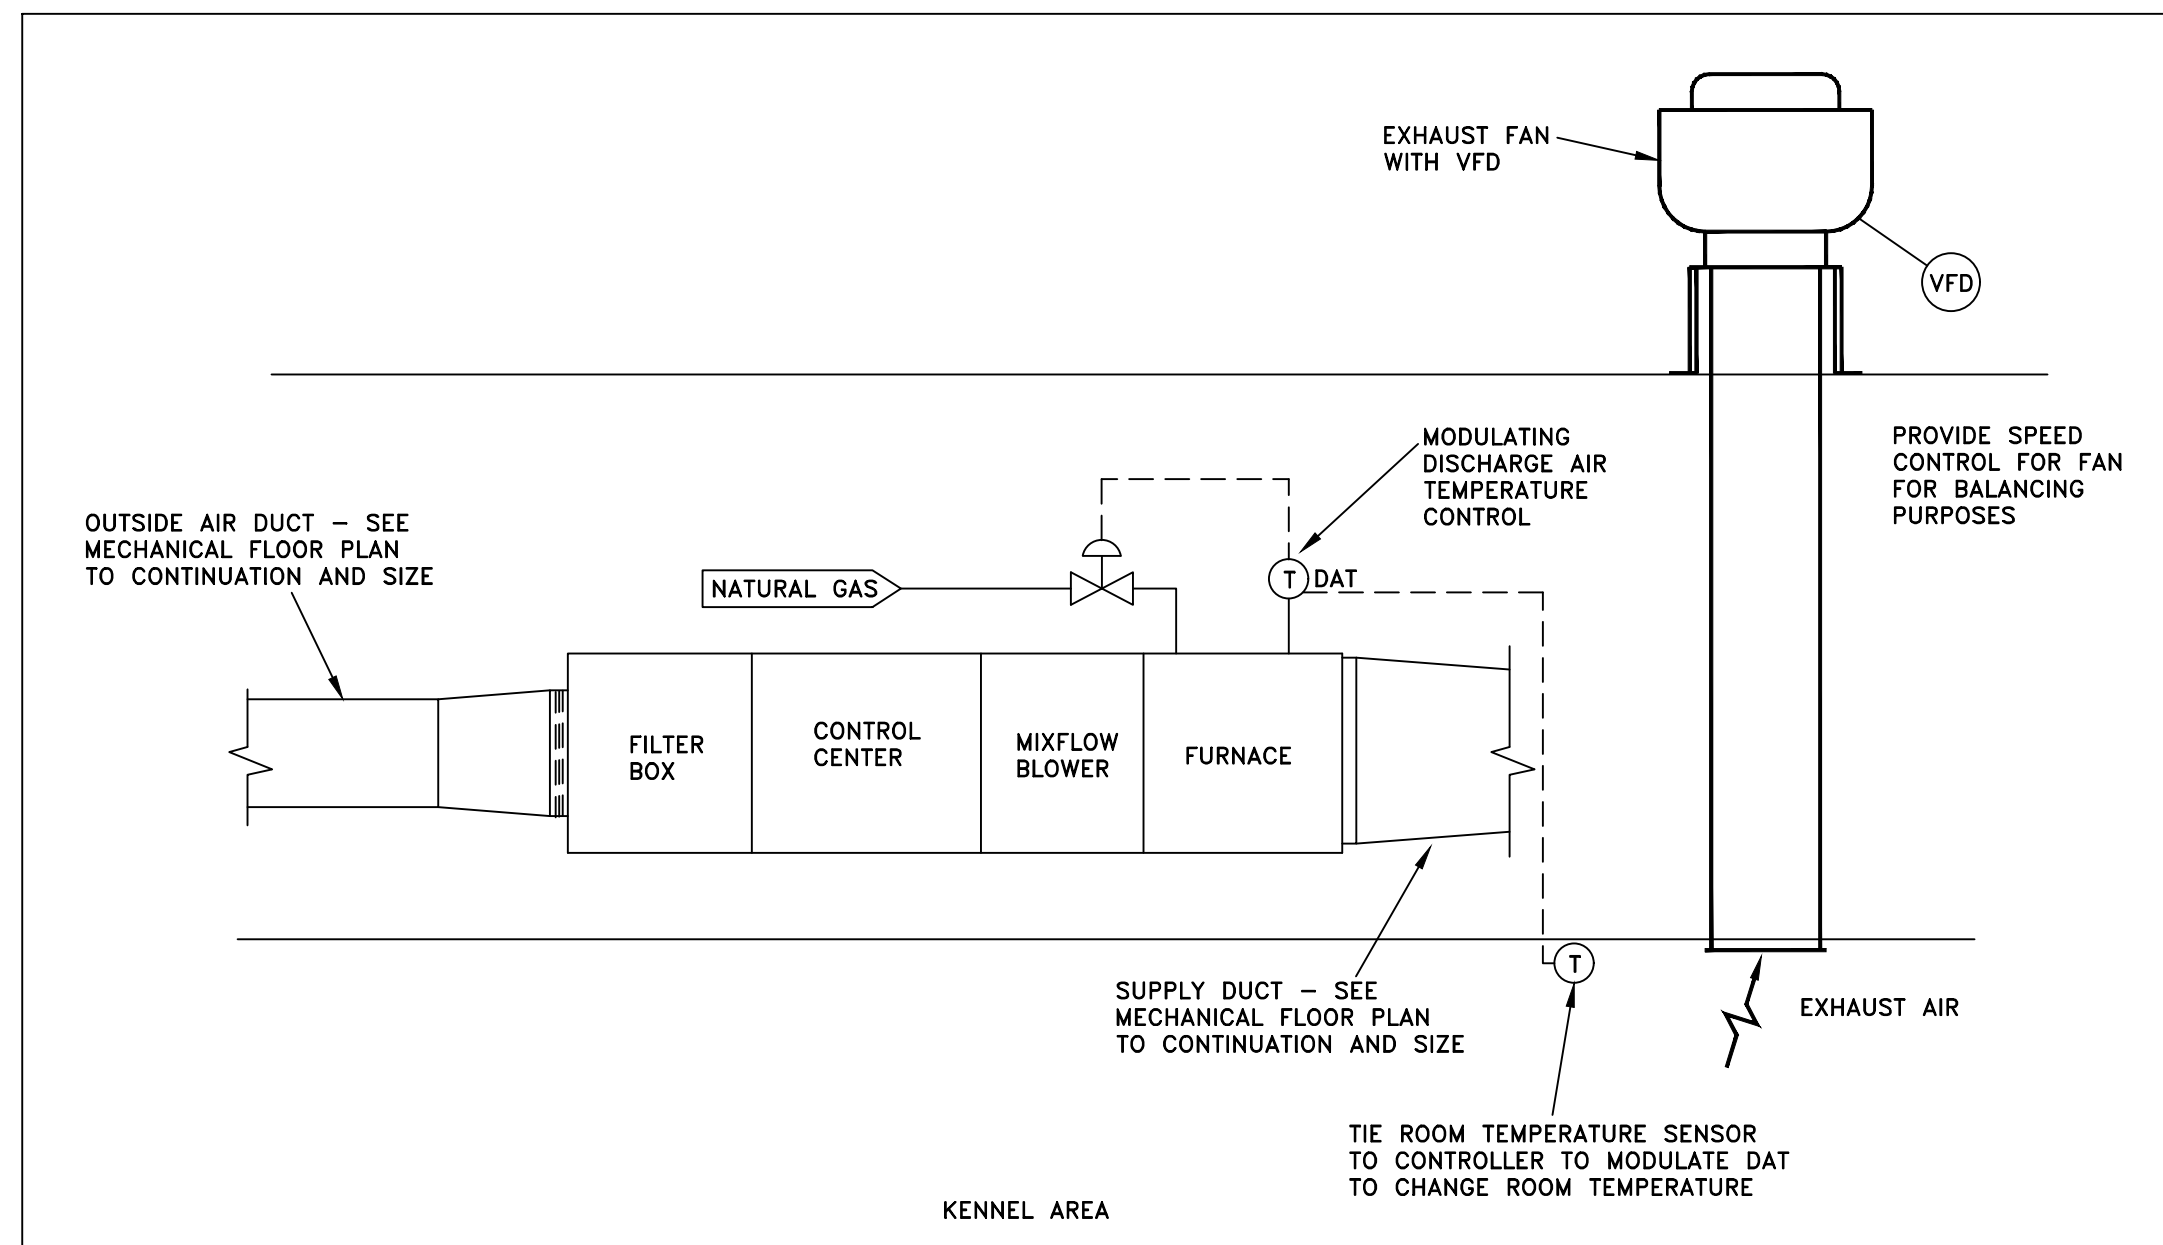
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BUILDING RENOVATION FOR
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MECHANICAL FLOOR PLAN



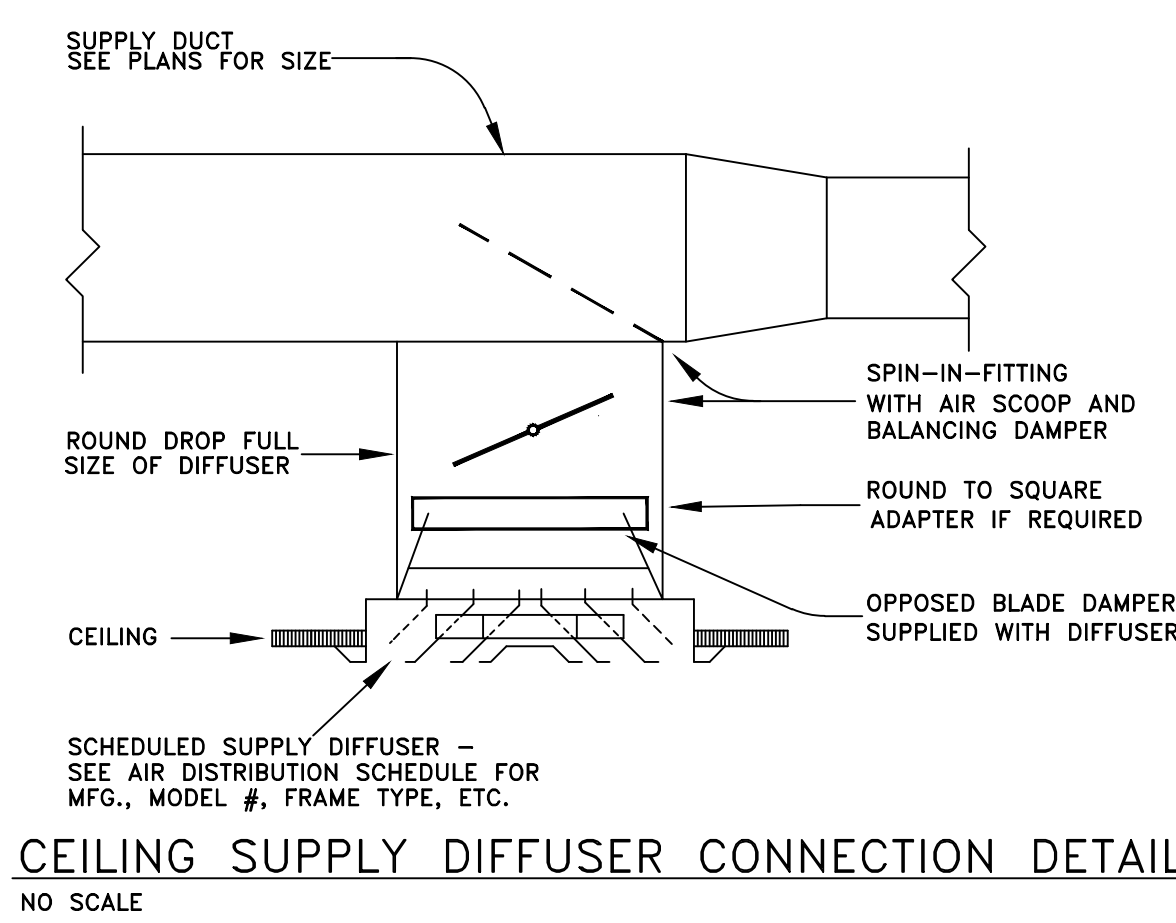
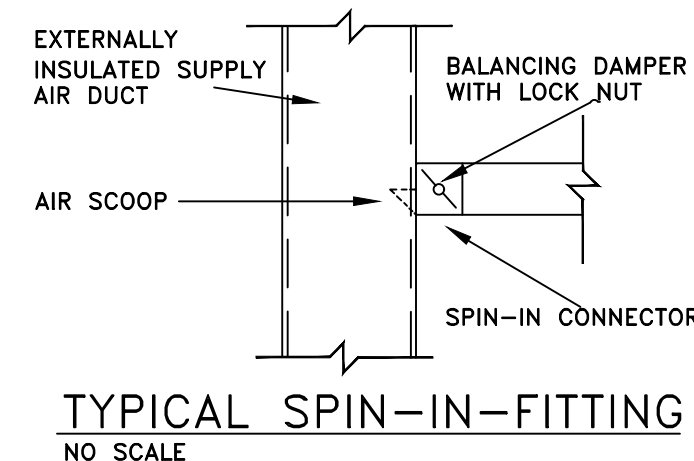
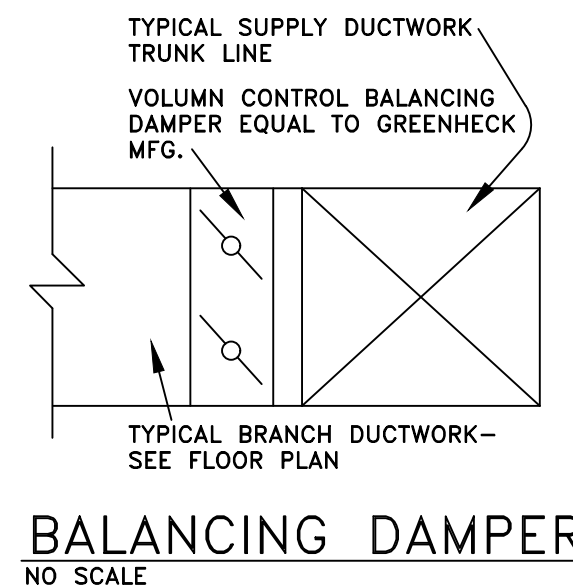
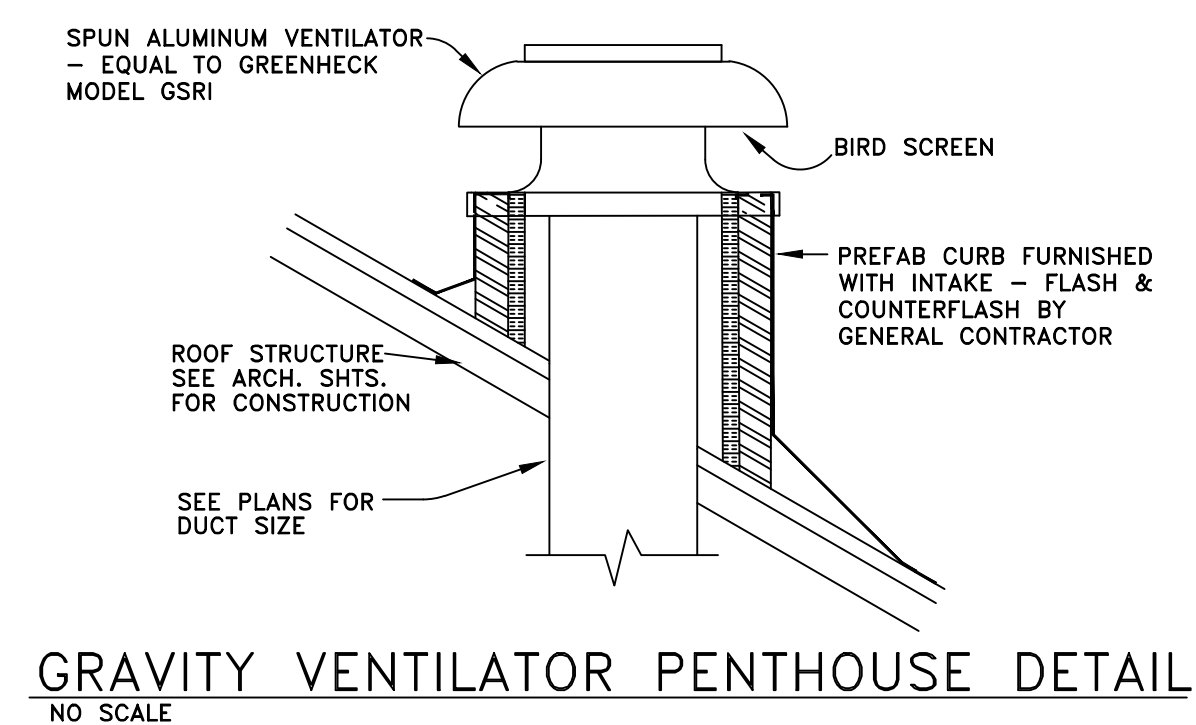
DATE:	06-30-2023
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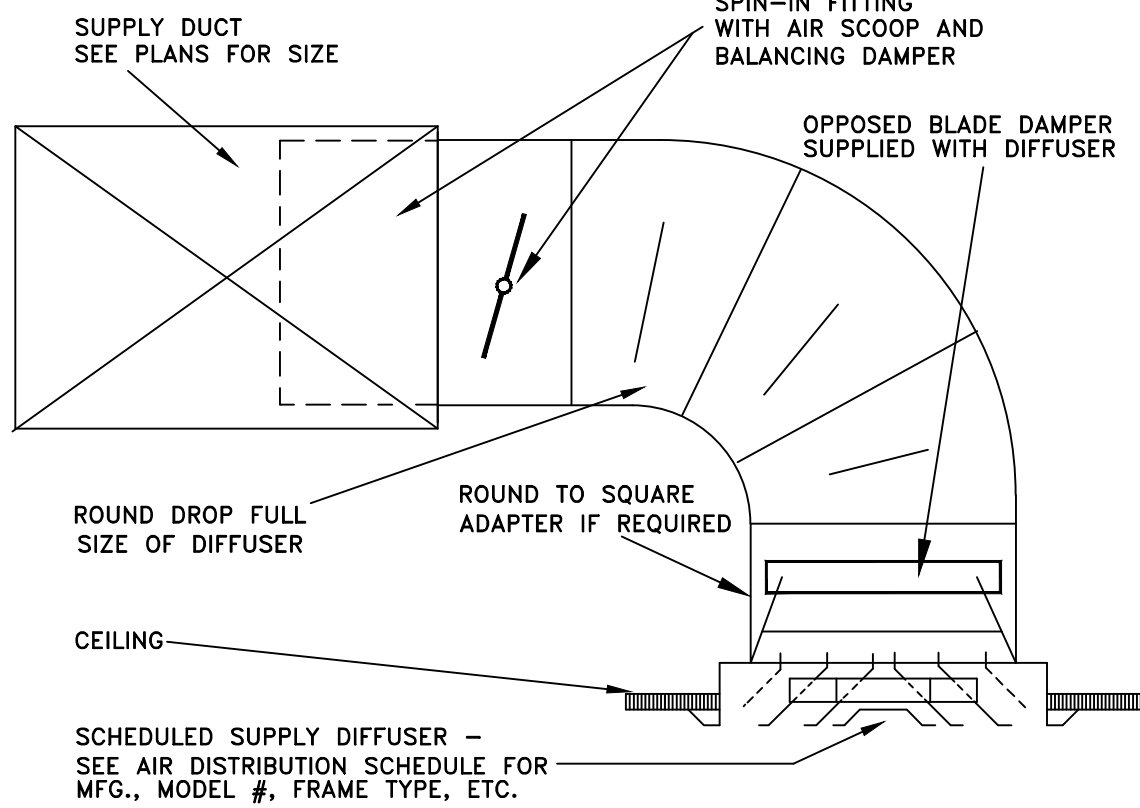
KENNEL CONTROL SCHEME

- CONTROL**
- SUMMER - 100% OUTSIDE AIR VENTILATION WITH EXHAUST FAN RUNNING TO GET SPACE AT PRESSURE NEUTRAL
 - WINTER - 100% OUTSIDE AIR - HAVE DISCHARGE AIR TEMP SET POINT MAINTAINING BY MODULATING GAS VALVE. EXHAUST FAN RUNNING TO PROVIDE SPACE @ SLIGHTLY NEGATIVE PRESSURE
 - FIELD SET VFD FOR EXHAUST FAN FOR SLIGHTLY NEGATIVE SPACE CONDITIONS AT 100% OUTSIDE AIR.
 - PROVIDE DISCHARGE AIR TEMPERATURE WITH CONTROLLER FOR DISCHARGE AIR TEMPERATURE CONTROL IN KENNEL.


AIR DISTRIBUTION SCHEDULE									
MARK	MANUFACTURER & MODEL NO.	SERVICE	SIZE	C.F.M.	F.P.M.	DESCRIPTION	MATERIAL	FINISH	ACCESSORIES & FEATURES
SG-1	KRUEGER SHPC-04	SUPPLY	6X6	60	240	FOUR WAY THROW DIFFUSER WITH FLANGED FRAME	STEEL	WHITE	FULLY ADJUSTABLE WITH AIR PATTERN CONTROLLERS AND OPPOSED BLADE DAMPER WITH FLANGED FRAME
SG-2			6X6	65	260				
SG-3			6X6	70	280				
SG-4			6X6	80	320				
SG-5			6X6	90	360				
SG-6			9X9	120	215				
SG-7			9X9	135	240				
SG-8			9X9	150	270				
SG-9			9X9	170	305				
SG-10			9X9	180	320				
SG-11			9X9	185	330				
SG-12			12X12	270	270				
SG-13	NOT USED								
SWS-1	KRUEGER 880	SUPPLY	12X8	250	375	SIDEWALL SUPPLY GRILLE	STEEL	COLOR BY ARCHITECT	OPPOSED BLADE DAMPER DOUBLE DEFLECTION
SWS-2	NOT USED								
RG-1	KRUEGER S580	RETURN	6X6	60	240	RETURN GRILLE WITH FLANGED FRAME	ALUMINUM	WHITE	HORIZONTAL BLADES ANGLED TO PREVENT SEE THROUGH AND OPPOSED BLADE DAMPER
RG-2			6X6	65	260				
RG-3			6X6	70	280				
RG-4			6X6	80	320				
RG-5			6X6	90	360				
RG-6			10X6	120	285				
RG-7			10X6	135	320				
RG-8			10X6	150	360				
RG-9			10X6	180	430				
RG-10			18X18	890	395				
RG-11	NOT USED								
EA-1	KRUEGER S580	EXHAUST	6X6	90	360	EXHAUST GRILLE WITH FLANGED FRAME	ALUMINUM	WHITE	HORIZONTAL BLADES ANGLED TO PREVENT SEE THROUGH
EA-2	KRUEGER S580	EXHAUST	12X12	340	340				
EA-3	NOT USED								



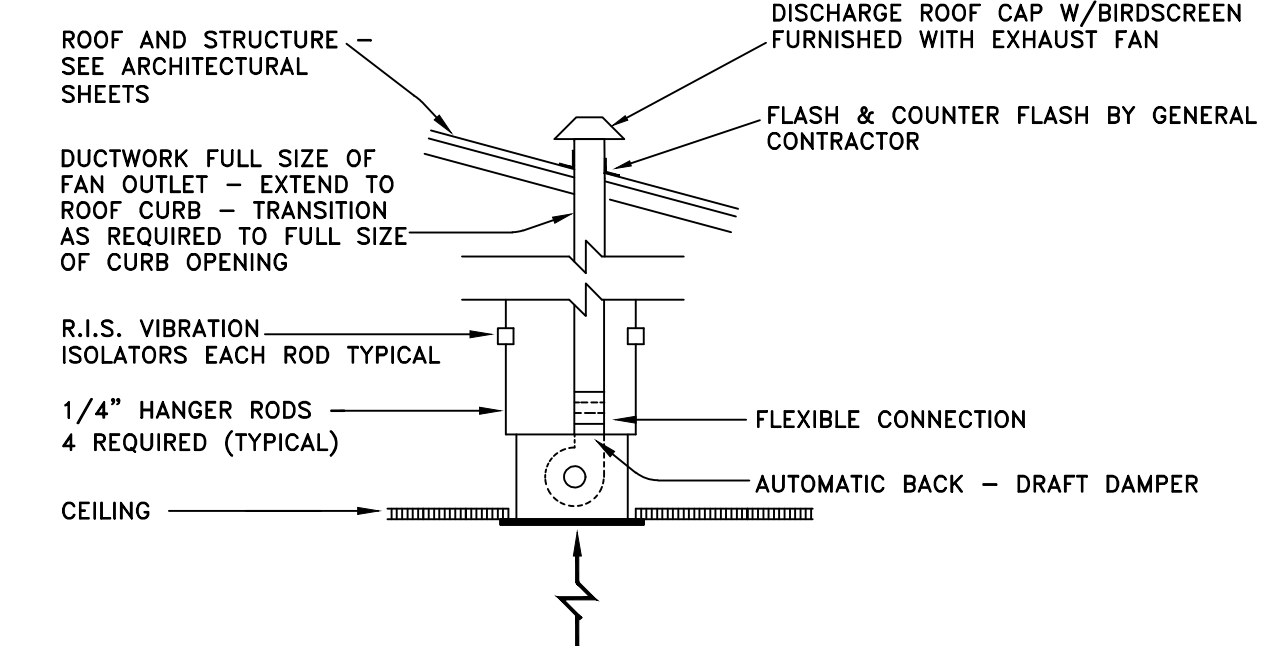CEILING SUPPLY DIFFUSER CONNECTION DETAIL
NO SCALE

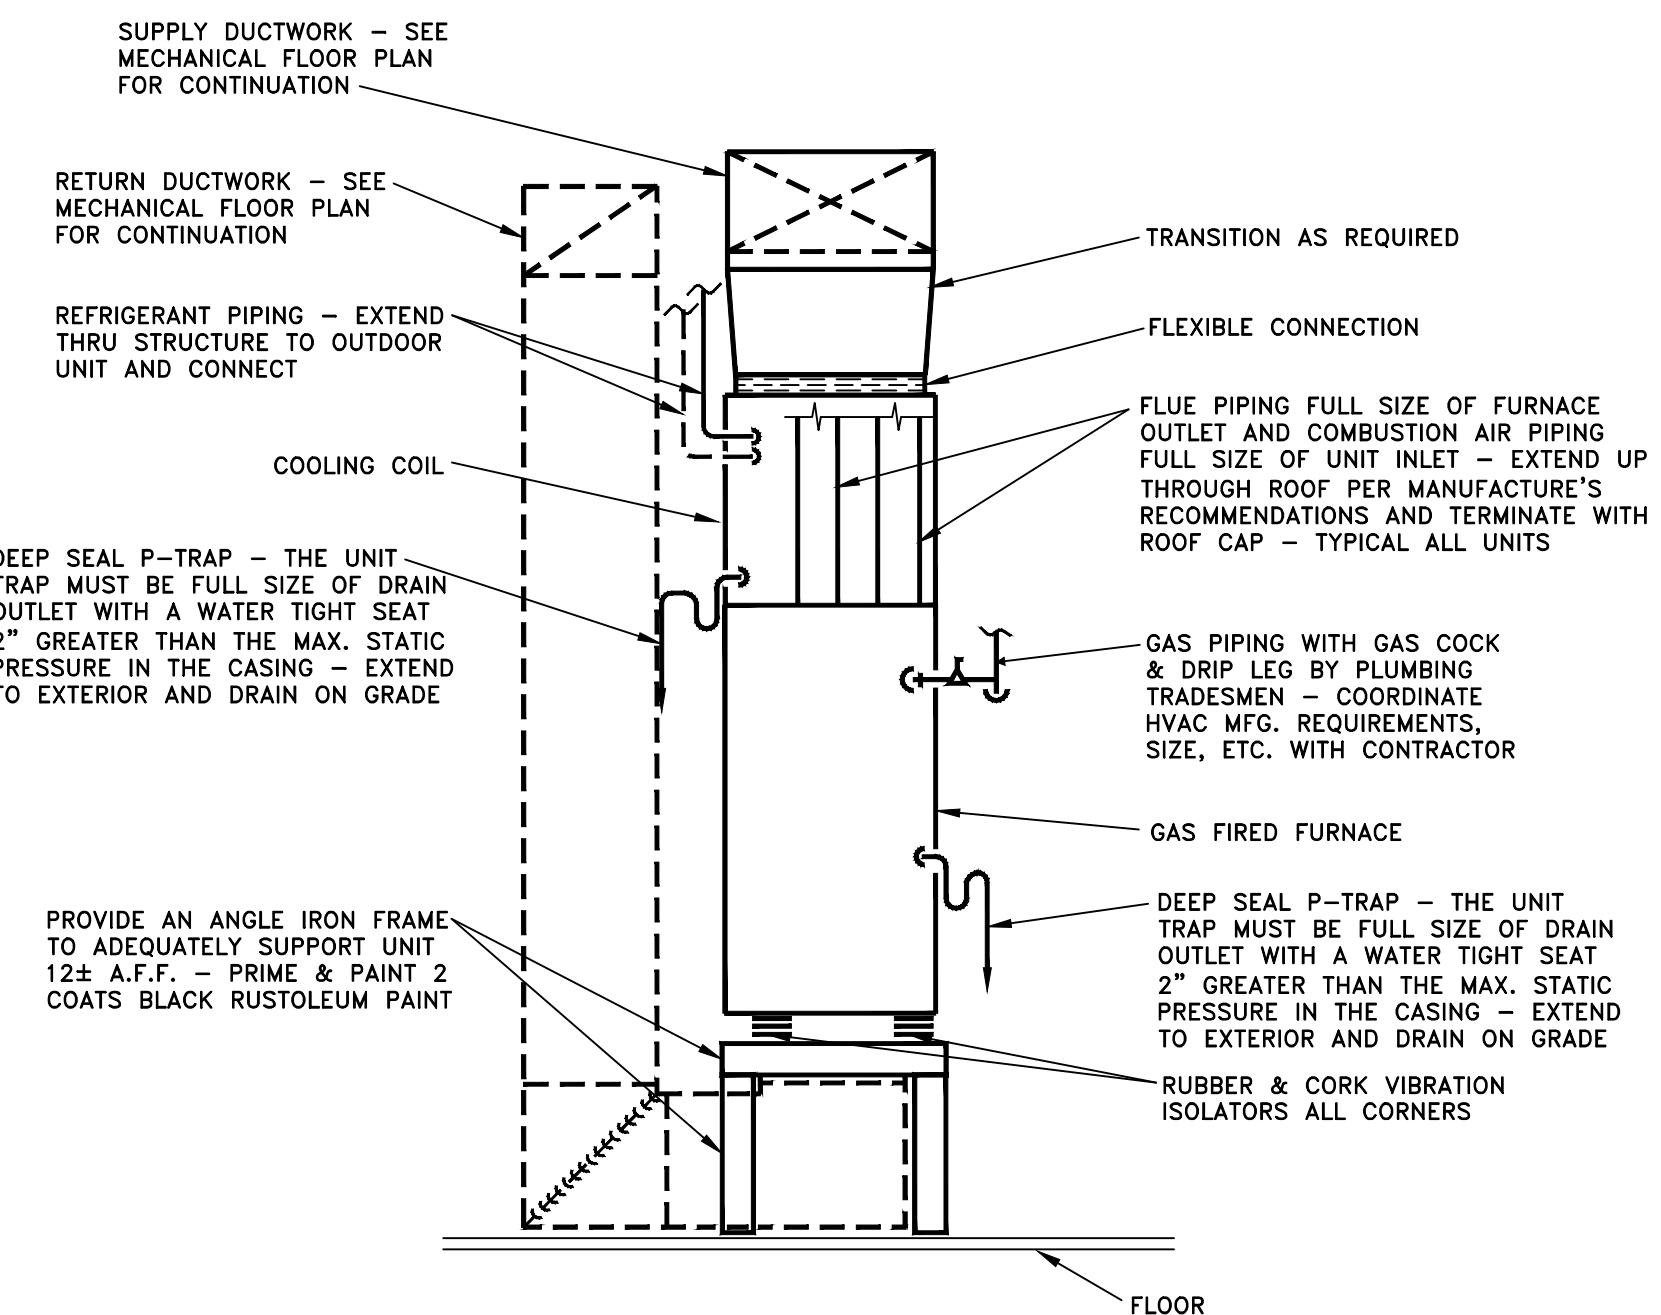


CEILING SUPPLY DIFFUSER CONNECTION DETAIL
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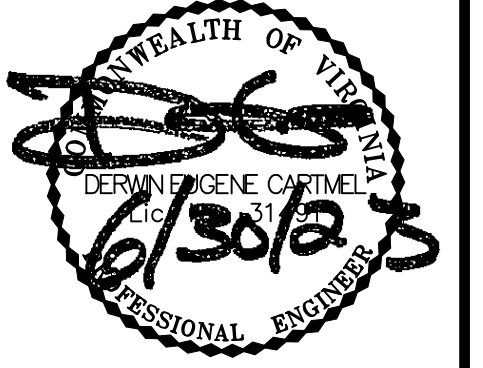


TYPICAL TOILET EXHAUST FAN DETAIL
NO SCALE

FAN NO.	MFG.	MODEL	CFM	S.P.	WATTS	PH/V
1	ACME	V0090ESa	70	1/4"	32	1#/120




TYPICAL INDOOR H.V.A.C. UNIT DETAIL
NO SCALE



DATE:	06-30-2023
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SHEET:	M102
DRAWN BY:	TRM
CHECKED BY:	DEC
PROJECT NO.	TLG-22136
THE LANE GROUP INC.	

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MAIN LEVEL LIGHTING FLOOR PLAN

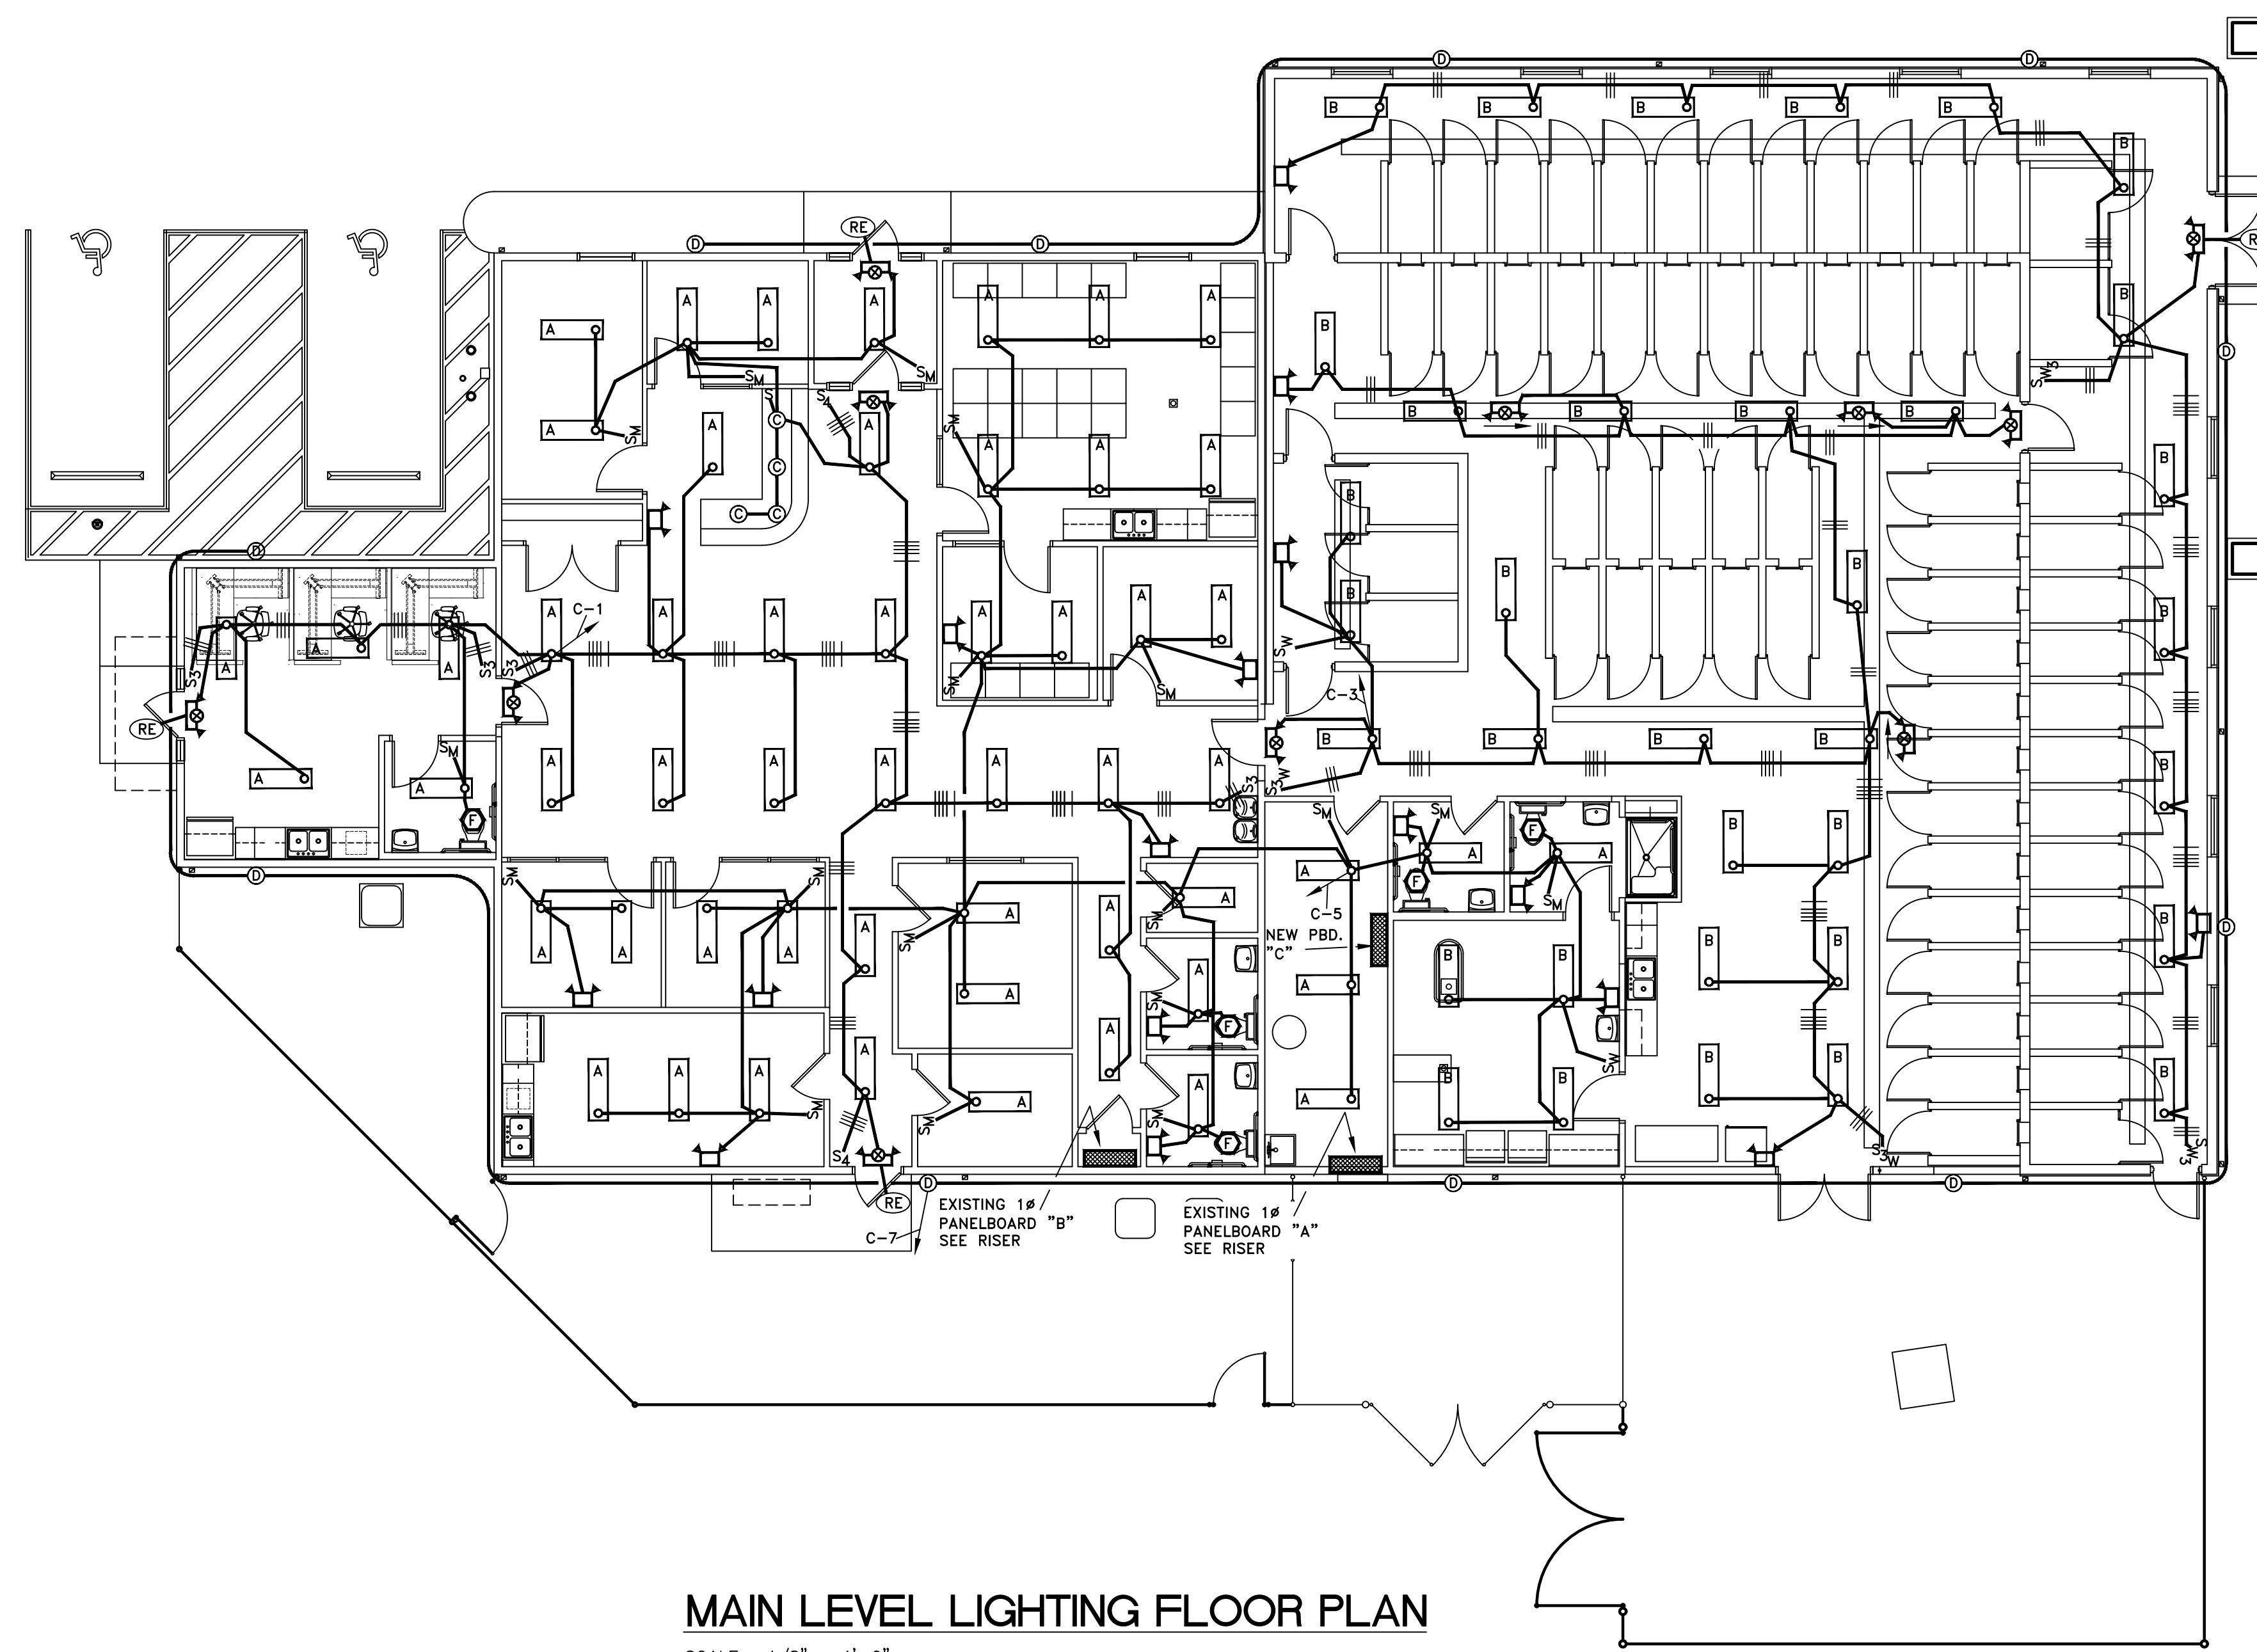SCALE: 1/8" = 1'-0"

LIGHTING FIXTURE SCHEDULE

TYPE	DESCRIPTION
RE	SURFACE MOUNTED EMERGENCY EXIT/LIGHTING UNIT WITH EXTERIOR REMOTE EMERGENCY HEAD, LED LAMPS, NICAD BATTERY, RED FACE, WHITE HOUSING, & ELECTRONIC CHARGING/SWITCHING. LITHONIA-LHGM-LED-R-HO/ELA-LED-WP-M1Z
EM	EMERGENCY BATTERY BACKUP LUMINAIRE WITH SOLID STATE CHARGING & SWITCHING AND ALL CATALOGUED FEATURES LITHONIA-EU2-LED-M1Z
A	4' SURFACE-MOUNTED LED LUMINAIRE WITH 4,600 LUMENS, 4000K COLOR TEMPERATURE, AND 120 VOLT INPUT [41 WATTS] CONTRACTOR-SELECT LITHONIA-LBL4-LPB40
B	4' SURFACE-MOUNTED WHITE LED LUMINAIRE WITH ALUMINUM HOUSING, POLY LENS, 4,500 LUMENS AND 4000K COLOR TEMP. [45 WATTS] KENALL MLHAB-48-F-MW-CP-2-45L40K-120
C	6" ROUND LED DOWNLIGHT WITH 1,500 LUMENS, 4000K COLOR TEMPERATURE, AND 120 VOLT INPUT [18 WATTS] LITHONIA-LDN6-40/15-MVOLT-GZ10-HSG
D	LED WALL PACK LUMINAIRE WITH 2,912 LUMENS, 4000K COLOR TEMP, DARK BRONZE FINISH & 120 VOLTS [24.4 WATTS] LITHONIA-WPX1-LED-P2-40K-MVOLT-DOBXD-M4
E	4' SURFACE-MOUNTED LED STRIP LIGHT WITH 4,500 LUMENS, 4000K COLOR TEMP, 80 CRI, & 120 VOLTS. [35 WATTS] LITHONIA-MNSL-L48-2LL-MVOLT-40K-80CRI-M6

ELECTRIC LEGEND

○ A	LIGHTING OUTLET LED. INSERT IS TYPE.
⊗	EXIT LIGHTS, WITH ARROW AND REMOTE EMERGENCY HEAD WHERE NOTED. SEE LIGHTING FIXTURE SCHEDULE.
⊕ W	DUPLEX 20 AMPERE WEATHERPROOF GROUND-FAULT CONVENIENCE OUTLET. BRYANT #GFR53FT WITH #GFRWPV WEATHERPROOF COVER.
⊕ A	DUPLEX 15 AMPERE CONVENIENCE OUTLET WITH GROUND. BRYANT #5262-I. SUBSCRIPT "A" INDICATES 20 AMPERE SIZE.
⊕ GF	DUPLEX 15 AMPERE GROUND-FAULT CONVENIENCE OUTLET. BRYANT #GFR52FT-I.
⊕	FLOOR OUTLET WITH GROUND - STEEL CITY #601 WITH P-60-DR FLOOR PLATE, DUPLEX 20 AMP GROUND-FAULT SPEC GRADE RECEPTACLE. INSTALL CARPET FLANGE WHERE REQUIRED. VERIFY EXACT LOCATION PRIOR TO ROUGH-IN.
⊕	JUNCTION BOX OUTLET. CONNECT POWER. VERIFY LOCATION AND SERVICE PRIOR TO ROUGH-IN.
⊕ F	FAN OUTLET. CONNECT POWER. VERIFY LOCATION AND SERVICE PRIOR TO ROUGH-IN.
⊕	WALL MOUNTED DATA OUTLET WITH STAINLESS STEEL PLATE WITH OPENING AS REQUIRED BY OWNER/VENDOR. EXTEND 3/4" CONDUIT TO ABOVE CEILING
⊕	FUSIBLE SAFETY DISCONNECT SWITCH.
■	BRANCH CIRCUIT PANELBOARD.
S	SINGLE POLE, QUIET ACTION, 20 AMPERE TOGGLE SWITCH - BRYANT #4901-I. SUBSCRIPT "W" INDICATES A WEATHERPROOF COVER FOR THE SWITCH EQUAL TO CARLON #E98TSCN
S ₃ S ₄	3 AND 4 WAY QUIET ACTION 20 AMPERE TOGGLE SWITCHES. BRYANT #4903-I AND #4904-I.
S _M	WALL MOUNTED MOTION DETECTOR SWITCH WITH TIME DELAY OFF SETTING, MANUAL ON/OFF SWITCH AND DIMMING. nLIGHT nWSX LV
○ OS	OCCUPANCY SENSOR - SENSOR SWITCH-CM-9
—	CONDUIT CONCEALED. GROUND NOT SHOWN BUT REQUIRED.
—+—	CONDUIT AND 3 WIRES. NO MARKS INDICATE 2 WIRES. GROUND NOT SHOWN BUT REQUIRED.
1-1,3	CONDUIT AND WIRE HOME RUN. NUMBERS INDICATE PANELBOARD AND CIRCUIT NUMBERS. GROUND NOT SHOWN BUT REQUIRED.

- INSTALL SWITCHES 48"± ABOVE FINISHED FLOOR AND RECEPTACLES AND PHONE/LAN OUTLETS 18"± ABOVE FINISHED FLOOR AND 8"± ABOVE COUNTERS UNLESS NOTED OTHERWISE. ALL DEVICES FLUSH MOUNTED UNLESS OTHERWISE REQUIRED.
- ALL SWITCH AND DEVICE PLATES SATIN FINISH STAINLESS STEEL.
- EQUAL SPEC GRADE DEVICES OF BRYANT, HUBBELL, P & S, LEVITON, AND GENERAL ELECTRIC MAKE ACCEPTABLE. NONE OTHER ACCEPTABLE, EXCEPT WITH WRITTEN PERMISSION.




DATE: 06-30-2023

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SHEET: **E101**

DRAWN BY: PWM	CHECKED BY: JWR
PROJECT NO: TLG-22136	

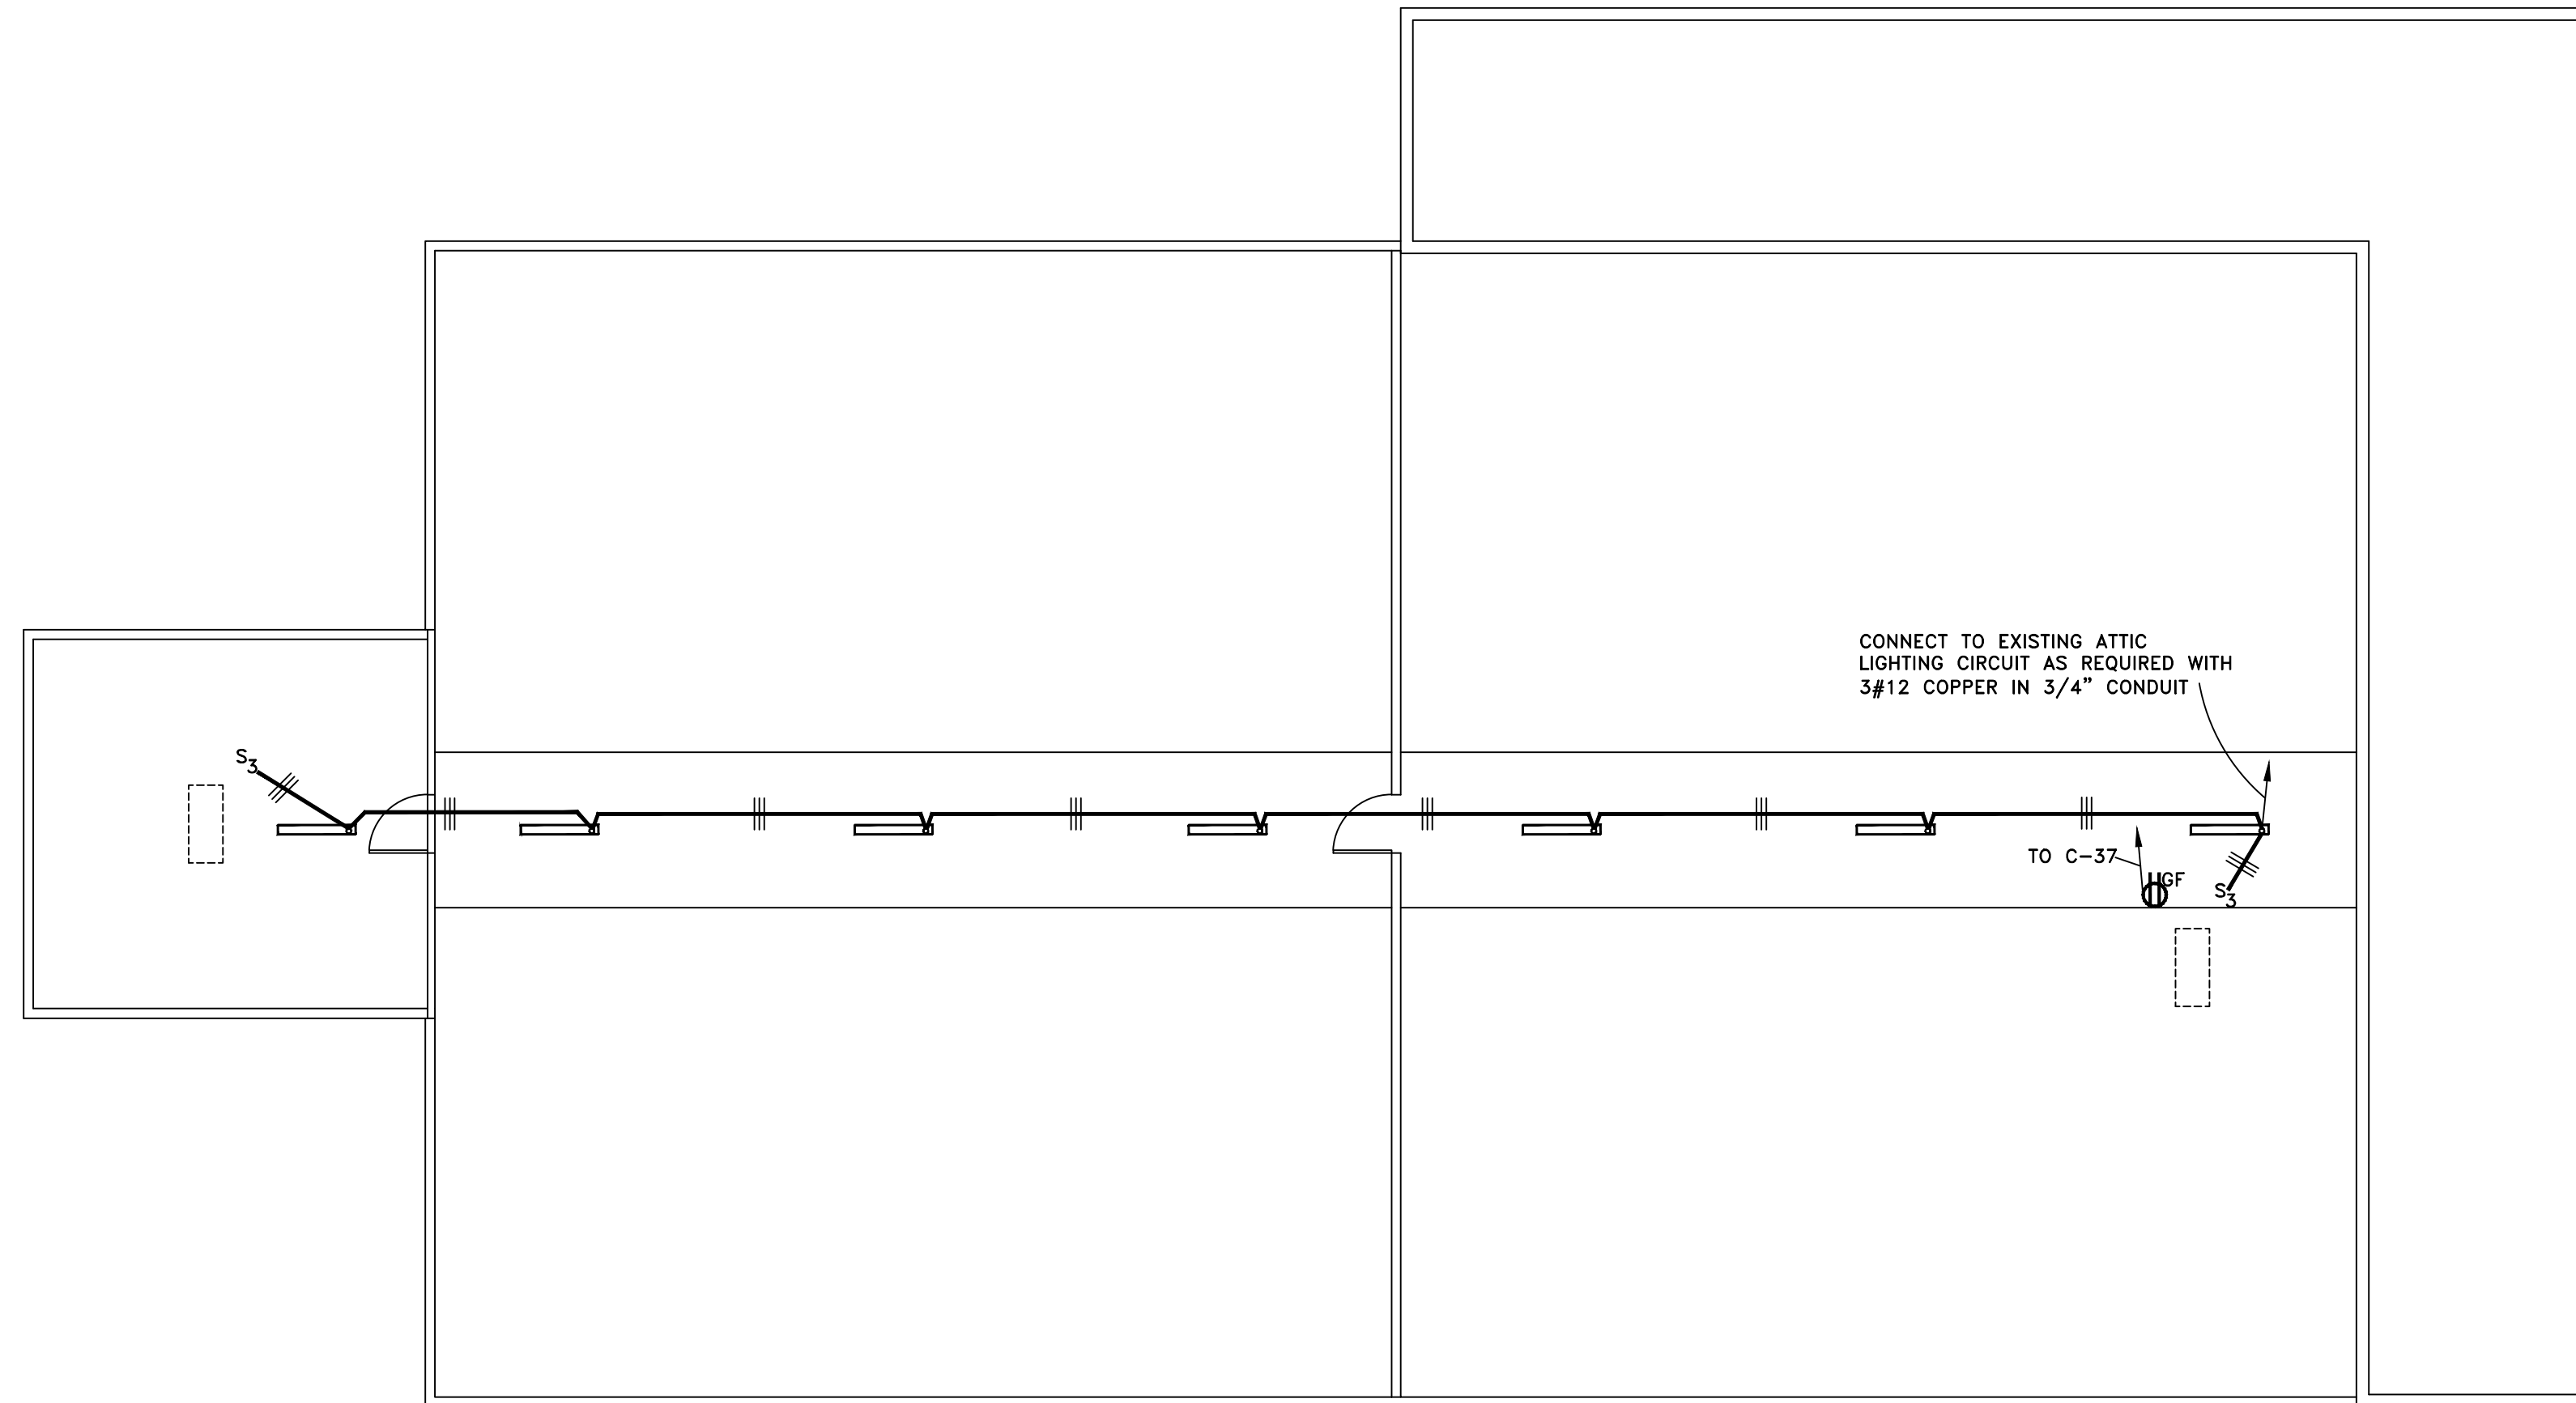THE LANE GROUP INC.



ATTIC ELECTRICAL PLAN

SCALE: 1/8" = 1'-0"

NOTE: ALL FIXTURES THIS SHEET ARE TYPE "E" UNLESS OTHERWISE NOTED.

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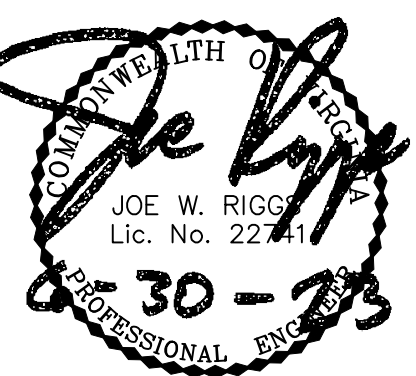
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HE PROJECT # 23-008

**BUILDING RENOVATION FOR
 WASHINGTON COUNTY, VIRGINIA
 ANIMAL SHELTER
 15050 LEE HIGHWAY
 BRISTOL, VIRGINIA 24201**

ATTIC ELECTRICAL PLAN



DATE: 06-30-2023


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SHEET: **E102**

DRAWN BY: PWM
 CHECKED BY: JWR
 PROJECT NO: TLG-22136

THE LANE GROUP INC.

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MAIN LEVEL POWER + COMM. FLOOR PLAN

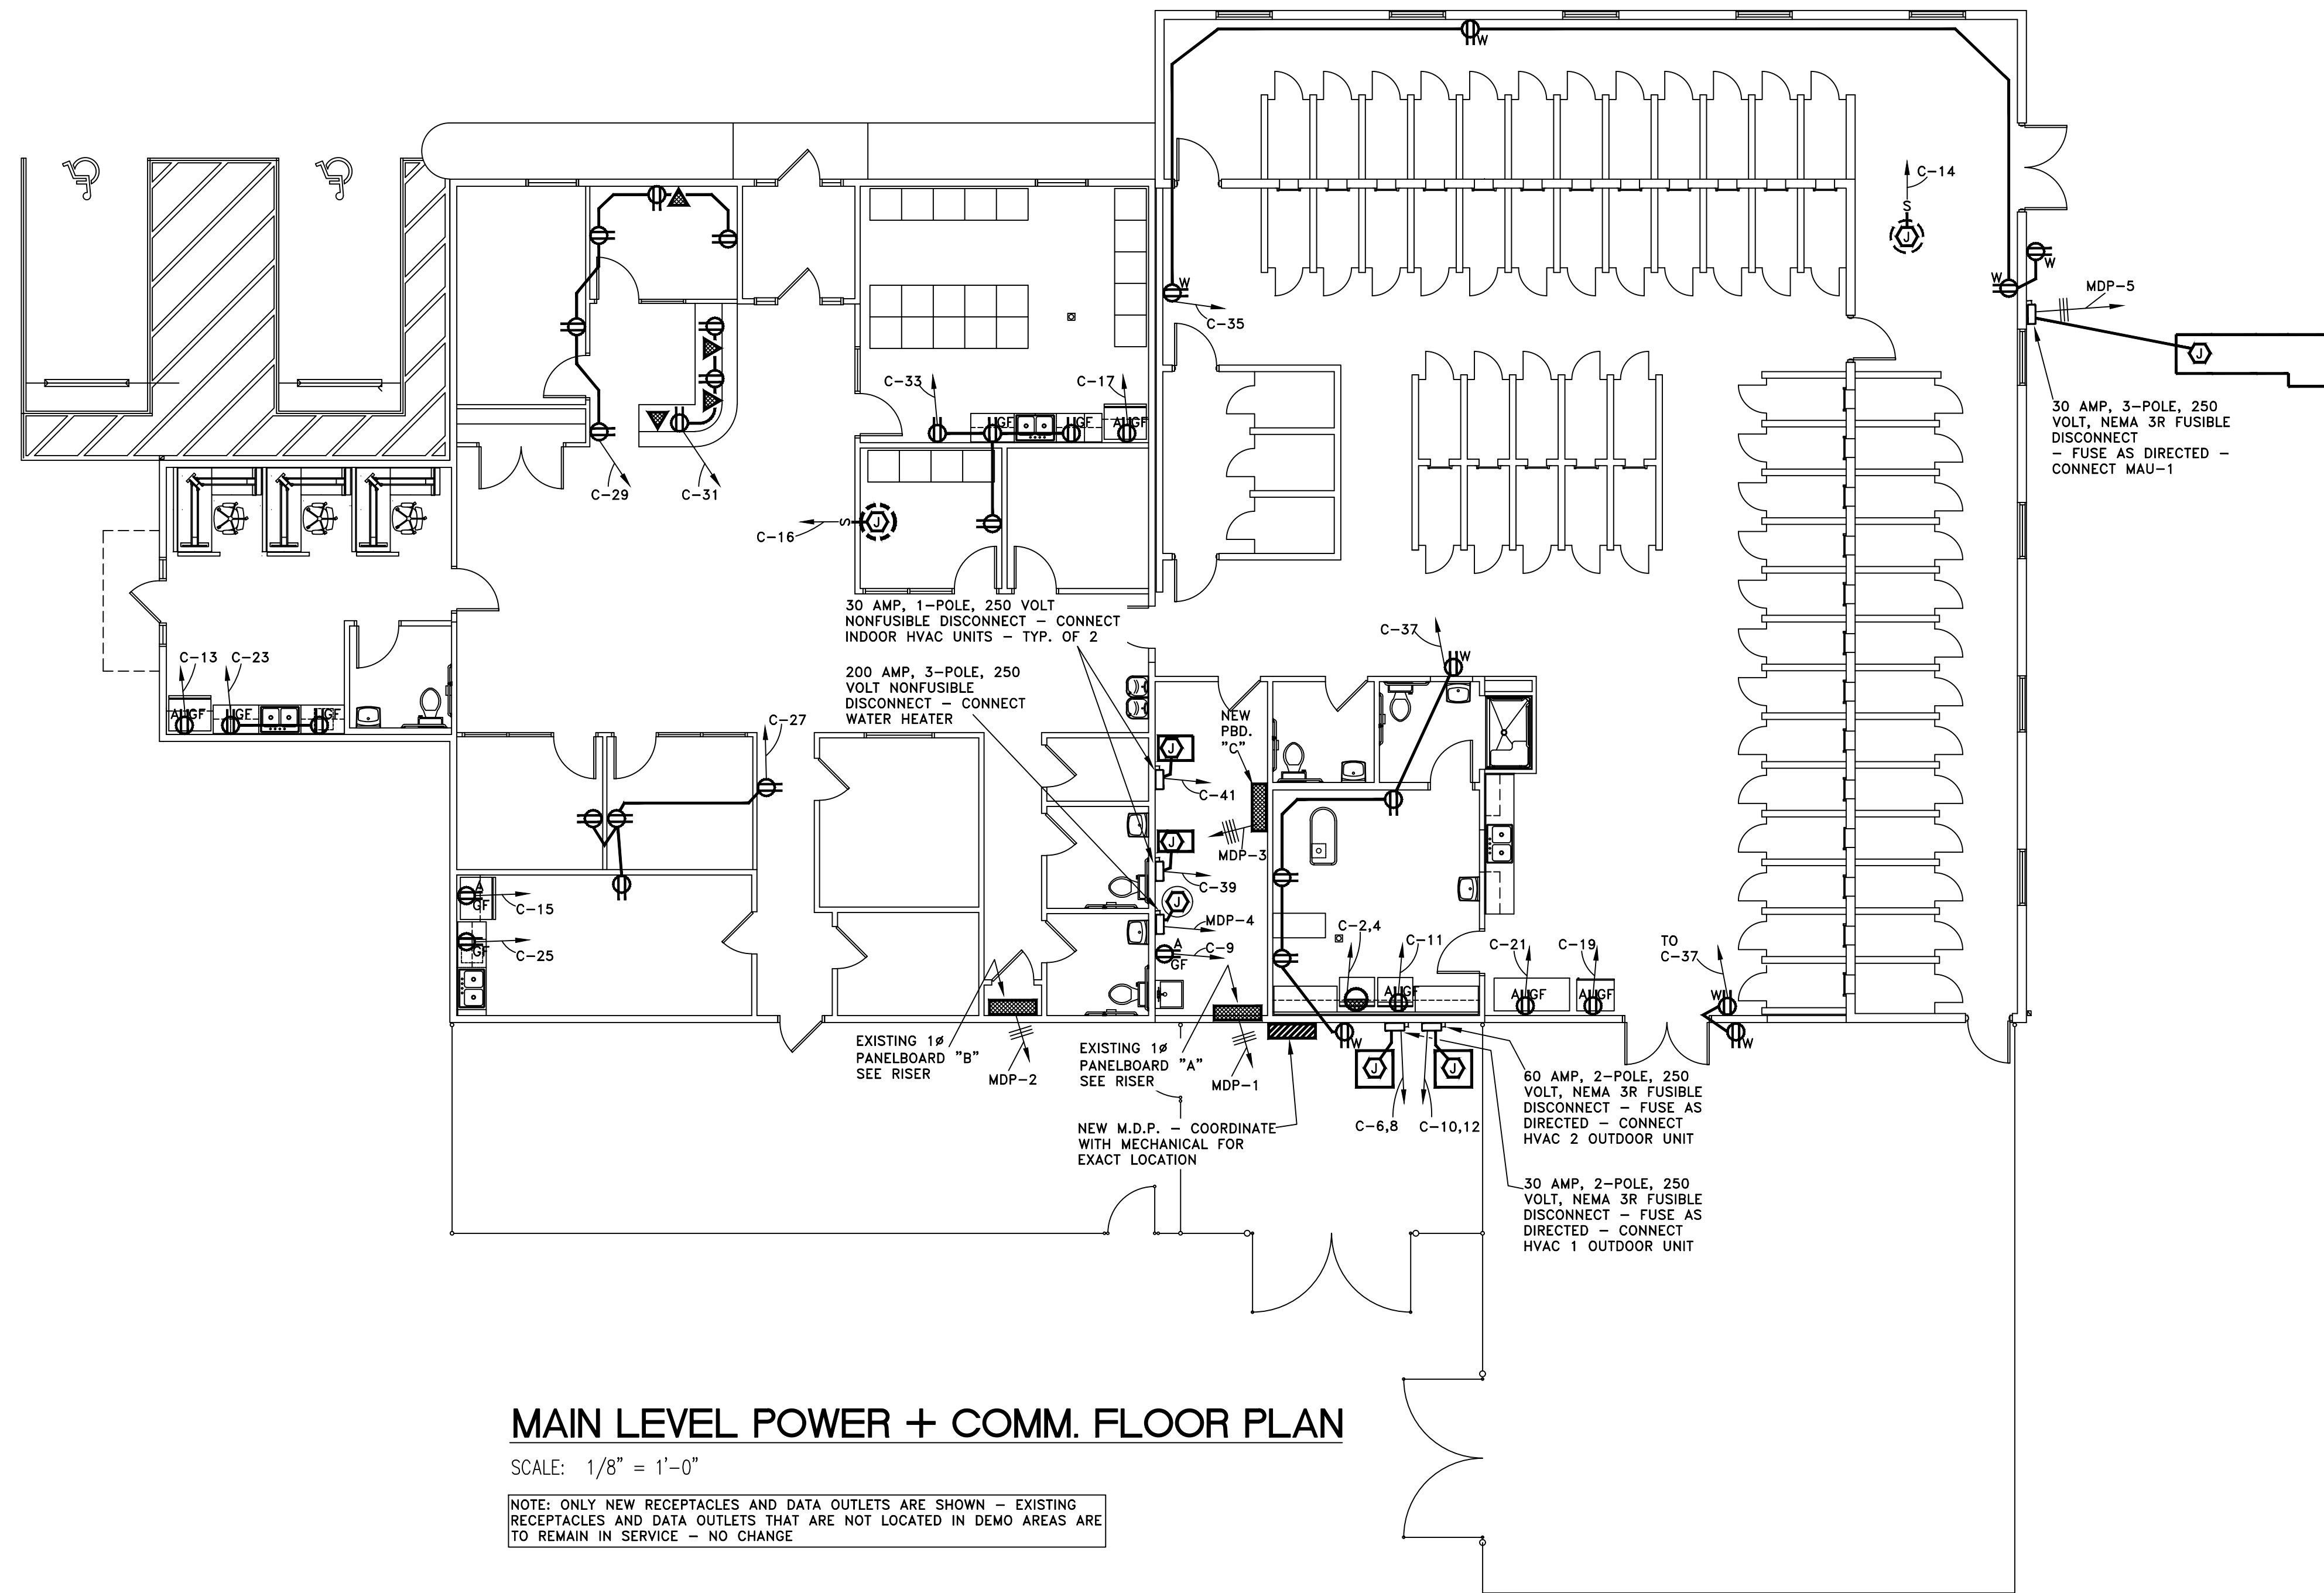SCALE: 1/8" = 1'-0"

NOTE: ONLY NEW RECEPTACLES AND DATA OUTLETS ARE SHOWN - EXISTING RECEPTACLES AND DATA OUTLETS THAT ARE NOT LOCATED IN DEMO AREAS ARE TO REMAIN IN SERVICE - NO CHANGE

DESC.	FEEDING	AMPS	POLES	FRAME	COPPER			PHASE LOADING-KW		
					WIRE	GND	COND.	A	B	C
1	EXISTING PBD. "A"	200	2		3#3/0 THWN	6	2"	18.0	15.9	-
2	EXISTING PBD. "B"	200	2		3#3/0 THWN	6	2"	17.0	14.0	
3	PBD. "C"	200	3		4#3/0 THWN	6	2"	12.8	14.8	13.6
4	WATER HEATER	125	3		3#1 THWN	6	1 1/2"	12.0	12.0	12.0
5	MAU-1	15	3		3#12 THWN	12	3/4"	0.7	0.7	0.7
TOTALS								43.5	60.4	40.3

FURNISH AND INSTALL A DISTRIBUTION SWITCHBOARD EQUAL TO SQUARE D I-LINE WITH 600 AMP RATING WITH M.L.O. BOARD SHALL BE FOR 3#4W 208Y/120 VOLTS. THE PANEL SHALL BE UL LISTED AND MEET ALL APPLICABLE NEMA STANDARDS AND FEDERAL SPECIFICATIONS. PANEL SHALL BE LABELED FOR SERVICE DUTY AND FURNISHED WITH SOLID NEUTRAL.


BUSS BARS SHALL BE PLATED AND OF SUFFICIENT CROSS SECTIONAL AREA TO CONTINUOUSLY CARRY RATED FULL LOAD CURRENT AT A MAXIMUM TEMPERATURE RISE OF 65°C ABOVE AMBIENT OF 40°C. BUSS BARS SHALL BE BRACED FOR A MINIMUM OF 100,000 RMS SYMMETRICAL AMPERES AT 208 VOLTS.

CIRCUIT BREAKERS SHALL BE MOLDED CASE TYPE OF THE FRAME SIZE AS SCHEDULED AND BE TRIP FREE. CIRCUIT BREAKERS SHALL HAVE AN INTERRUPTING RATE OF NOT LESS THAN _____ AMPERES AT RATED VOLTAGE.

BRANCH CIRCUIT PANELBOARD

PANELBOARD NO. C											
FEEDING	WIRE	CIRCUIT AMPS	NO.	PBD.	CIRCUIT NO.	AMPS	WIRE	FEEDING	PHASE	LOADING-KW	
									A	B	C
LIGHTS	12	20	1	2	30	10	DRYER		3.5		
			3	4	25	10	HVAC 1 OUTDOOR			4.0	
			7	8	25	10	HVAC 2 OUTDOOR		2.0		3.1
EXT. LIGHTS			9	10	50	8	HVAC 2 OUTDOOR			4.5	
RECIRC. PUMP			11	12	20	12	EXHAUST FAN		2.7		
WASHER			13	14	20	12	EXHAUST FAN			2.2	
REFRIGERATOR			15	16	12	12	EXHAUST FAN			1.2	1.2
			17	18	-	-	SPARE				
			19	20	-	-			1.2		
FREEZER			21	22	-	-				1.2	
RECEPTACLES			23	24	-	-			1.0		1.0
			25	26	-	-	SPACE			0.8	
			27	28	-	-					
			29	30	-	-			1.0		1.0
			31	32	-	-				1.0	
			33	34	-	-					
			35	36	-	-			1.4		0.8
			37	38	-	-					
HVAC 1 INDOOR			39	40	-	-					1.8
HVAC 2 INDOOR			41	42	-	-					1.8
PANELBOARD LOADING									12.8	14.8	13.6
LOCATION SEE PLANS		MAINS		200 AMPS WITH 200 AMP MAIN BREAKER							
MOUNTING SURFACE		TYPE		NQ							
SERVICE 3# 4W 208Y/120 VOLTS		TOTAL LOAD		40.2 KW							

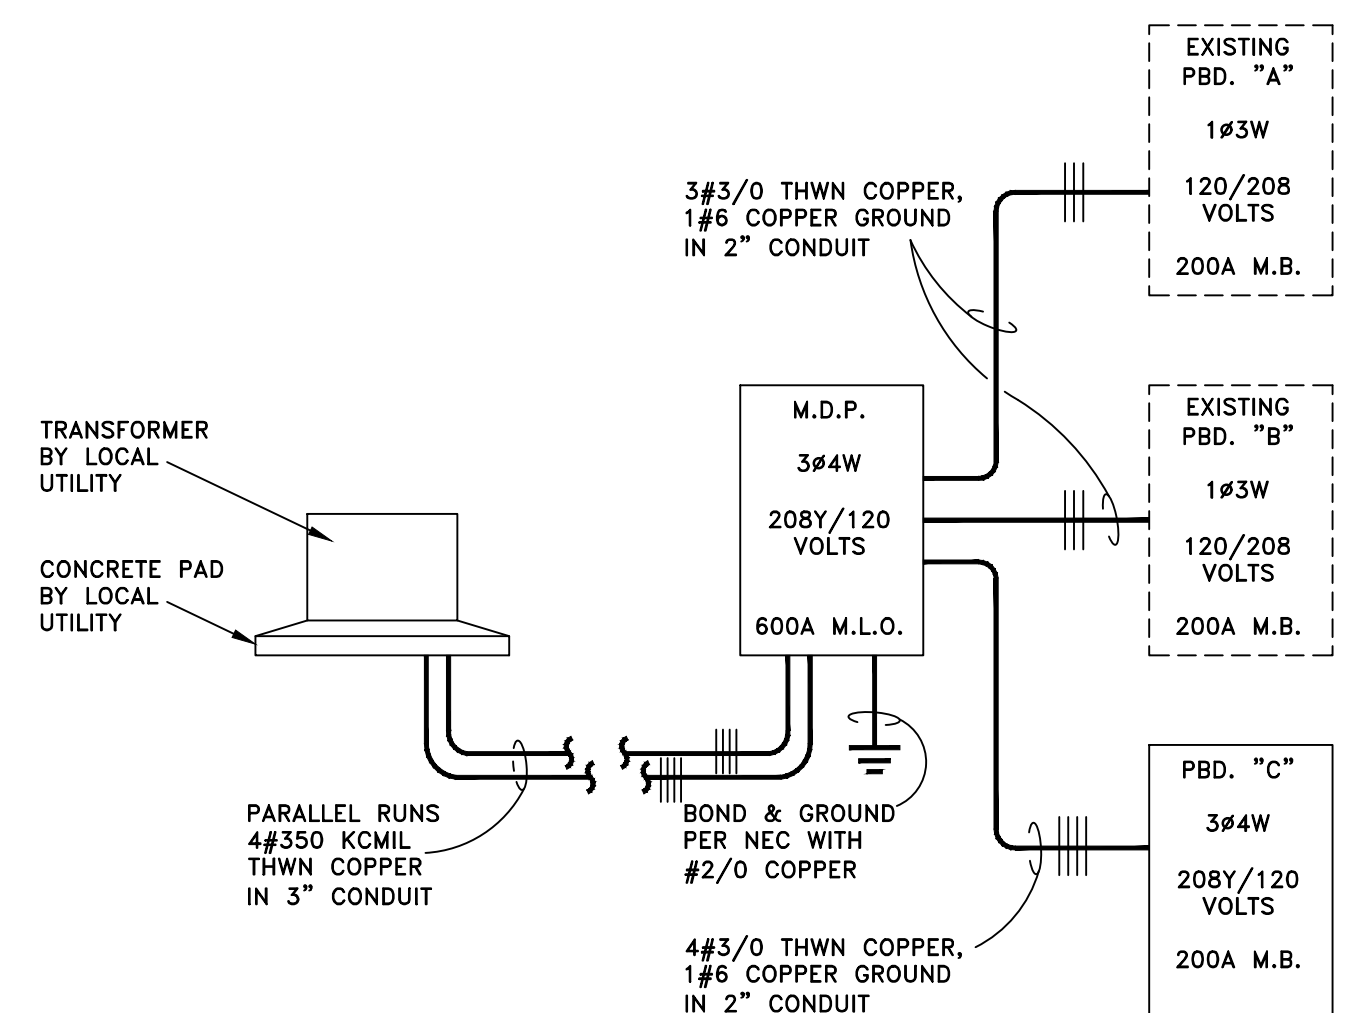NOTE: PROVIDE TIMECLOCK/PHOTOCELL CONTROL FOR EXTERIOR LIGHTING CKT. 1-7



ELECTRIC SERVICE RISER DIAGRAM

NOT TO SCALE

DESIGN DATA	
SERVICE CHARACTERISTICS	3# 4W 208Y/120 VOLTS
CONNECTED LOADS:	
LIGHTS	5.2 KW
HVAC	16.9 KW
WATER HEATER	36.0 KW
MISC. POWER	21.2 KW
EXISTING PBD. "A"	33.9 KW
EXISTING PBD. "B"	31.0 KW
TOTAL ESTIMATED CONNECTED LOAD	144.2 KW
ESTIMATED DEMAND	100.0 KW
ESTIMATED FUTURE LOAD	NONE
SERVICE CAPACITY	600 AMPS

HE HOLSTON ENGINEERING, INC.
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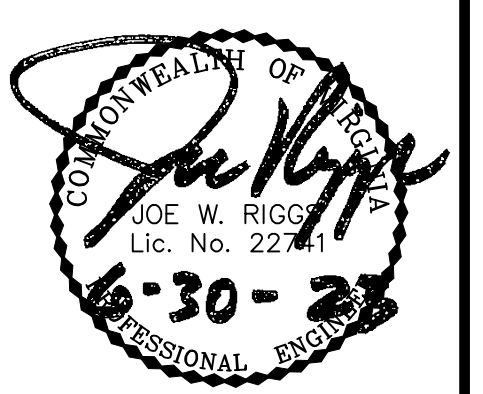
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PLOT DATE: 06/30/2023 HE PROJECT # 23-008

the **LANE GROUP** engineering architecture environmental
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BUILDING RENOVATION FOR WASHINGTON COUNTY, VIRGINIA ANIMAL SHELTER
15050 LEE HIGHWAY BRISTOL, VIRGINIA 24201

MAIN LEVEL POWER & COMM. FLOOR PLAN



DATE:	06-30-2023
NO.	REVISION DATE
1	
2	
3	
SHEET:	E103
DRAWN BY:	PWM
CHECKED BY:	JWR
PROJECT NO.	TLG-22136
THE LANE GROUP INC.	